

VILLAGE OF GREAT NECK ARCHITECTURAL REVIEW COMMITTEE April 29, 2025 Agenda

I. <u>CONTINUED CASES</u>

A. ARC CASE #24-34 14 LAWSON LANE SECTION 1 BLOCK 203 LOT 87

II. <u>NEW CASES</u>

- A. ARC CASE #25-4 105 MAPLE STREET SECTION 1 BLOCK 189 LOT 3
- B. ARC CASE #25-5 41 STRATHMORE ROAD SECTION 1 BLOCK 203 LOT 66
- C. ARC CASE #25-6 2 MARGARET COURT SECTION 1 BLOCK 128 LOT 291

III. NEXT MEETING DATE

A. NEXT MEETING DATE MAY 27 2025



ITEM TITLE:

ARC CASE #24-34 14 LAWSON LANE SECTION 1 BLOCK 203 LOT 87

SUBJECT:

Continued case from last ARC meeting.



ITEM TITLE:

ARC CASE #25-4 105 MAPLE STREET SECTION 1 BLOCK 189 LOT 3

SUBJECT:

Application for propose exterior and interior renovation of existing 1-family building, with vertical and horizontal extension. Work conducted to include exterior facade, interior partition, plumbing and structural work. The exterior will be renovated with the same style as the existing house.

ATTACHMENTS:

Description Type

□ PLANS Backup Material

LEGEND RESIDENCE AA DISTRICT RESIDENCE A DISTRICT RESIDENCE A-1 DISTRICT RESIDENCE B DISTRICT RESIDENCE B-1 DISTRICT RESIDENCE C DISTRICT RESIDENCE D DISTRICT RESIDENCE E DISTRICT or APARTMENT DISTRICT and MIDDLE NECK ROAD MULTIFAMILY INCENTIVE OVERLAY DISTRICT PROPOSE EXTERIOR & INTERIOR RENOVATION OF

EX. 1-FAMILY BUILDING. WORK INVOLVES IN EXTERIOR FACADE, INTERIOR PARTITION, PLUMBING AND STRUCTURAL WORK

PROPERTY INFO							
105 MAPL GREAT NEC							
SECTION	1						
BLOCK	189						
LOT	3						
ZONING DISTRICT	RESIDENCE C						

ALL WORK UNDER THIS APPLICATION SHALL BE PERFORMED IN STRICT ACCORDANCE WITH THE REQUIREMENTS OF THE FOLLOWING CODES AND

- 2020 PLUMBING CODE OF NEW YORK STATE (PCNYS)
- 2020 NYS ENERGY CONSERVATION CODE (ECCNYS) VILLAGE OF GREAT NECK ZONING CODE

2017 NYS ELECTRICAL CODE

VILLAGE OF GREAT NECK BUILDING DEPARTMENT APPROVED TO PROCEED WITH SOARD REVIEW CHAIRPERSON

GENERAL NOTES, PLOT PLAN &

DRAWING INDEX

1 OF 23 DATE ISSUED: 2/15/2025 **DATE CREATED:** 01/24/2024 AS NOTED

DRAWN BY: CHECKED RY: KY FU 24036

SEAL & SIGNATURE:

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TABLE R 301.2(1) CLIMATIC & GEOGRAPHIC DESIGN CRITERIA (NASSAU COUNTY)

WHICH THE LUMBER IS PURCHASED.

PLACED IN ACCORDANCE WITH ACI.

RCNYS AS FOLLOWING

CONCRETE SHALL CONFORM TO THE LATEST EDITION OF ACI-318

STEP FOOTINGS TO BE A RATIO OF 1 VERTICAL TO 2 HORIZONTAL

STRENGTH AND WALLS ARE PROPERLY SHORED OR BRACED

GENERAL CONSTRUCTION NOTES

PREMISES DURING THE COURSE OF CONSTRUCTION

RETARDANT IF REQUIRED BY LOCAL AUTHORITY.

COATS WHEN INTENDED FOR PAINT FINISH

DURING THE COURSE OF CONSTRUCION

OTHER WALLS EXPOSED TO THE WEATHER 4,000 PSI

MINIMUM COMPRESSIVE STRENGTHS OF CONCRETE USED ARE TO BE IN COMPLIANCE WITH TABLE 402 2 OF THE 2020

ALL FOOTING SHALL REST ON UNDISTURBED SOIL HAVING A MINIMUM BEARING CAPACITY OF 1.5 TONS PER SQUARE

UNLESS OTHERWISE NOTED ALL SLABS ON GROUND SHALL BE 4" THICK, REINFORCED WITH 6X6-W1 4XW1 4 W W F

BACK FILLING AGAINST FOUNDATION WALLS SHOW NOT BE DONE UNTIL CONCRETE HAS ATTAINED SUFFICIENT

MINIMUM 8" BETWEEN FINISH GRADE AND TOP OF FOUNDATION WALL FINISH GRADES TO SLOPE AWAY FROM

KEEP STREET AND SIDEWALKS AROUND THE EXTERIOR OF THE CONSTRUCTION AREA FREE FROM RUBBISH

CONTRACTOR SHALL REMOVE ALL RUBBISH FROM THE SITE AND DISPOSE OF GENERAL CONSTRUCTION WASTE

INCLUDING PACKING MATERIAL ETC GENERATED BY ALL TRADES ACCORDING TO LOCAL AGENCIES HAVING

CONTRACTOR SHALL NOT PERFORM ANY WORK THAT REQUIRES SHOP DRAWING APPROVAL BEFORE RECEIPT

OF SUCH APPROVAL FROM THE ARCHITECT NOR SHALL ANY MATERIAL REQUIRING SUBMITTAL APPROVAL BE

A ALL WOOD FRAMING, BLOCKING, SHEATHING, ETC. TO BE CERTIFIED PRESSURE TREATED FIRE

INSTALLED OR APPLIED IN STRICT ACCORDANCE WITH THE MANUFACTURE'S SPECIFICATIONS AND RECOMMENDATIONS UNLESS MORE RESTRICTIVE CONDITIONS BY LOCAL LAWS PREVAIL.

B. ALL MATERIALS MANUFACTURED ARTICLES AND EQUIPMENT SPECIFIED ON THE PLANS SHALL BE

D. CEILING MATERIALS SHALL BE NON COMBUSTIBLE WITH RATED HARDWARE FOR THE SUSPENSION

E ALL DRYWALL MATERIALS SHALL BE 5/8" TYPE-X MATERIAL TAPED AND SPACKLED WITH MINIMUM 3

C. ALL INTERIOR FINISHES TO HAVE FLAME SPREAD RATING AS REQUIRED BY PREVAILING CODE

CONTRACTOR SHALL MAINTAIN AND KEEP CURRENT A COMPLETE SET OF CONTRACT DOCUMENTS ON THE

BASEMENT WALLS, FOUNDATION WALLS, FOOTING WALLS, FOOTINGS, INTERIOR SLABS ON GRADE, EXTERIOR OR

PORCHES, STEPS AND PLATFORMS EXPOSED TO THE WEATHER, AND GARAGE FLOOR SLAB 3500PSI

ALL FOOT TO SITE A MIN 3'-0" BELOW GRADE ON UNDISTURBED SOIL OR SOLID ROCK

E	i											
	E.	GROUND SNOW WIND SEISMIC DESIG				SUBJECT TO DAMAGE FORM				ICE SHIELD	51 000 1147100	AIR FREEZI
		LOAD	SPEED (MPH)	CATEGORY	WEATHERING	FROST LINE DEPTH	TERMITE	DECAY	TEMP.	UNDERPAYMENT REQUIRED	FLUUD HAZARD	INDEX
		20	130 MPH EXPOSURE "B"	В	SEVERE	36"	MODERATE	MODERATE	13°	YES	AS PER P/E	≤1500

CANISTERS APPROVED BY NYC FIRE DEPT

THE POWER CORDS TO HAZARD CONDITIONS

WHICH SHALL BE AVAILABLE WHEN NEEDED.

WORKING HOURS

DISCLAIMER NOTES

ACCORDANCE WITH APPLICABLE CODES

e ALL TARPS USED ON THE JOBSITE ARE TO BE FIRE RATED TO PREVENT FIRE

h. PORTABLE HEATING DEVICES SHALL BE KEPT AWAY FROM COMBUSTIBLES.

f. PLYWOOD SHANTIFS LOCATED INSIDE THE BUILDING SHALL BE MADE OF FIRE RATED PLYWOOD g PAINTS AND PAINT THINNER SHALL BE STORED IN PROPERLY VENTED UTILITY CABINETS.

a ALL POWER TOOLS SHALL BE PROVIDED WITH PROPER GROUNDING AND GFCI PROTECTION.

b ALL EXTENSION CORDS WILL BE PROPERLY MAINTAINED AND DAMAGED CORDS DISCARDED.

EXTENSION CORDS SHALL BE RUN FROM POWER SOURCE TO THE WORK AREA WITHOUT SUBJECTING

d. ONLY LICENSED ELECTRICAL WORKERS SHALL CONDUCT ELECTRICAL WIRING AND INSTALLATION OF

e. ALL ELECTRICAL WORK SHALL BE INSPECTED BY CITY ELECTRICAL INSPECTORS AND APPROVED

ALL EXPOSED WIRING SHALL BE DISCONNECTED OR PROVIDED WITH PROPER COVER PLATES. g. TEMPORARY LIGHTING SHALL BE HUNG BY PORCELAIN INSULATORS AND SECURED ABOVE 8 FEET

a. THE CONTRACTOR SHALL NOT BEGIN WORK ON THE SITE UNTIL 7 00 AM AND COMPLETE DAILY

A EACH SUB CONTRACTOR SHALL PROVIDE THEIR WORKERS WITH A FULLY STOCKED FIRST AID KIT

b THE FIRST AID KIT SHALL INCLUDE INDIVIDUALLY WRAPPED PACKETS OF ASPIRIN, BACITRACIN, GAUZE

c. THE FIRST AID KIT SHALL BE CHECKED PERIODICALLY AND REPLENISHED AS NEEDED, IN ADDITION TO

THE CONTRACTOR SHALL MAKE ARRANGEMENTS TO PROVIDE WATER ON THE SITE TO PREVENT

c WHEN WORKERS NEED TO WORK IN DUST CONDITIONS, THE WORKERS SHALL WEAR APPROVED TYPE

EXCESSIVE DUST FROM BEING KICKED UP WHEN CONSTRUCTION VEHICLES DRIVE ON SITE

b ALL HVAC DUCTWORK SHALL BE ENCLOSED TO PREVENT DUST INFILTRATION INTO DUCT WORK

THIS PLAN IS APPROVED ONLY FOR WORK INDICATED ON THE APPLICATION SPECIFICATION SHEET ALL OTHER MATTER SHOWN ARE NOT TO BE RELIED UPON OR TO BE CONSIDERED AS EITHER BEING APPROVED OR IN

THE FIRST AID KIT THERE SHOULD BE A SEPARATE EYE WASH STATION NEARBY THAT WORKERS CAN

OPERATIONS BY 6 00 PM THESE HOURS REMAIN IN EFFECT MONDAY THROUGH FRIDAY

WRAP, ANTISEPTIC WIPES, STERILE GLOVES, EYE WASH SOLUTION ETC

OPERATE TO FLUSH OUT FOREIGN MATTER FROM THEIR EYES WHEN NEEDED.


RESIDENCE F DISTRICT or SENIOR CITIZEN DISTRICT RESIDENCE G or WATERFRONT RESIDENTIAL DISTRICT BUSINESS A DISTRICT MIXED USE DISTRICT PARKING DISTRICT WATERFRONT DEVELOPMENT DISTRICT WATER BODY BOUNDARY OF FLOOD-PRONE AREA (SEE §296-2 FOR PARCELS IN THESE AREAS) NOT A PUBLIC ROAD (EXCEPT FOREST ROW)


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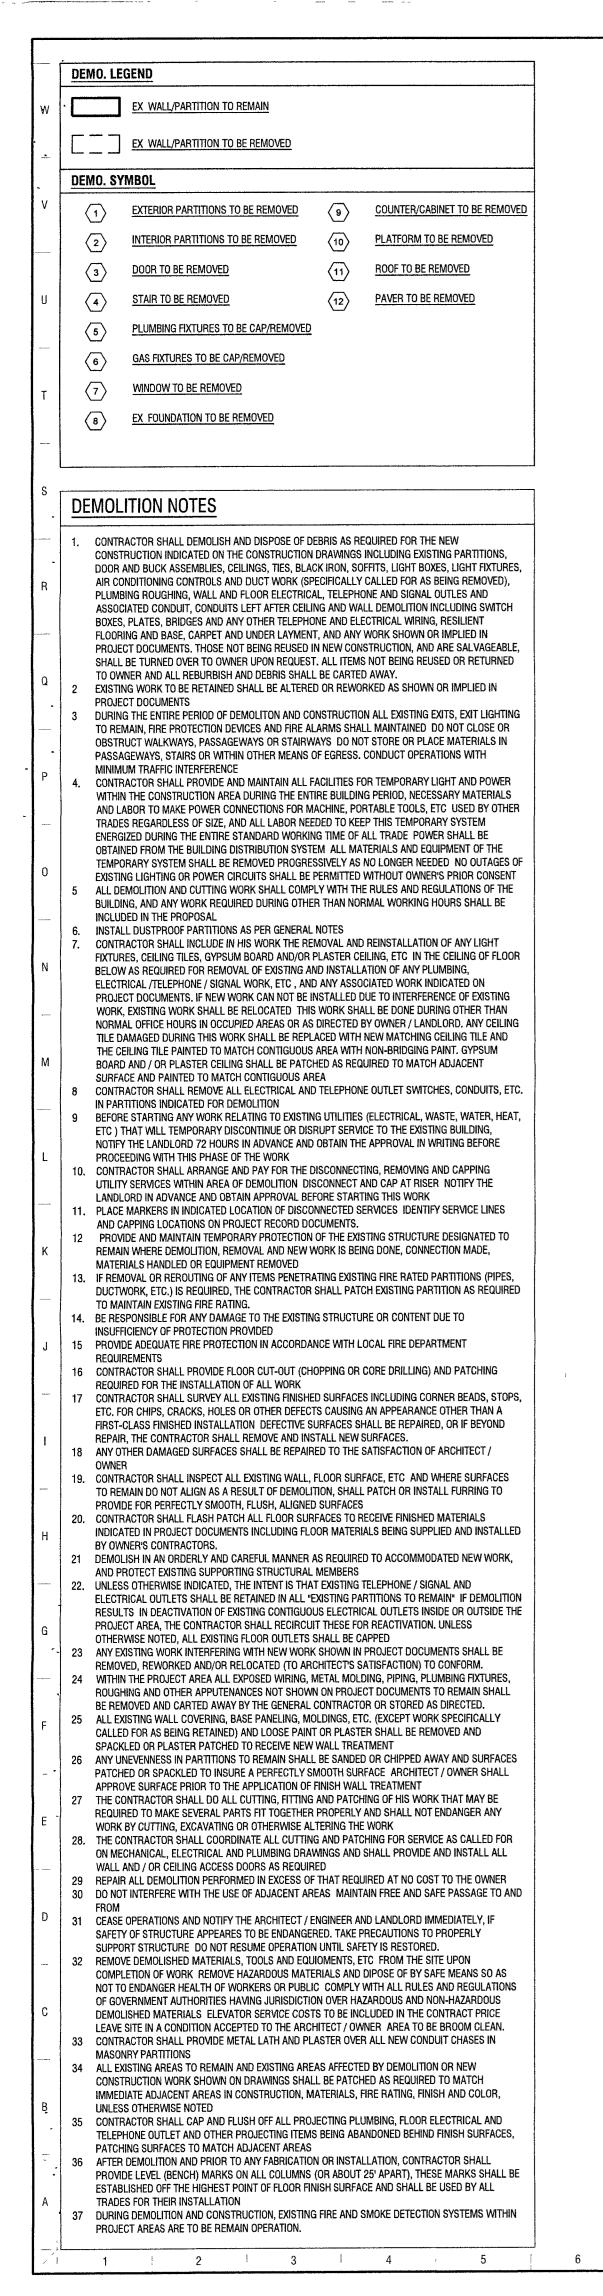
VILLAGE OF GREAT NECK BUILDING DEPARTMENT FEB 19 2025


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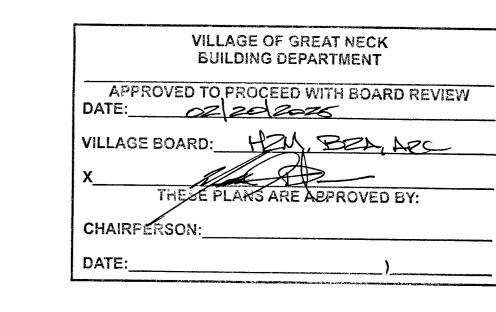
<u>SUBJECT</u>





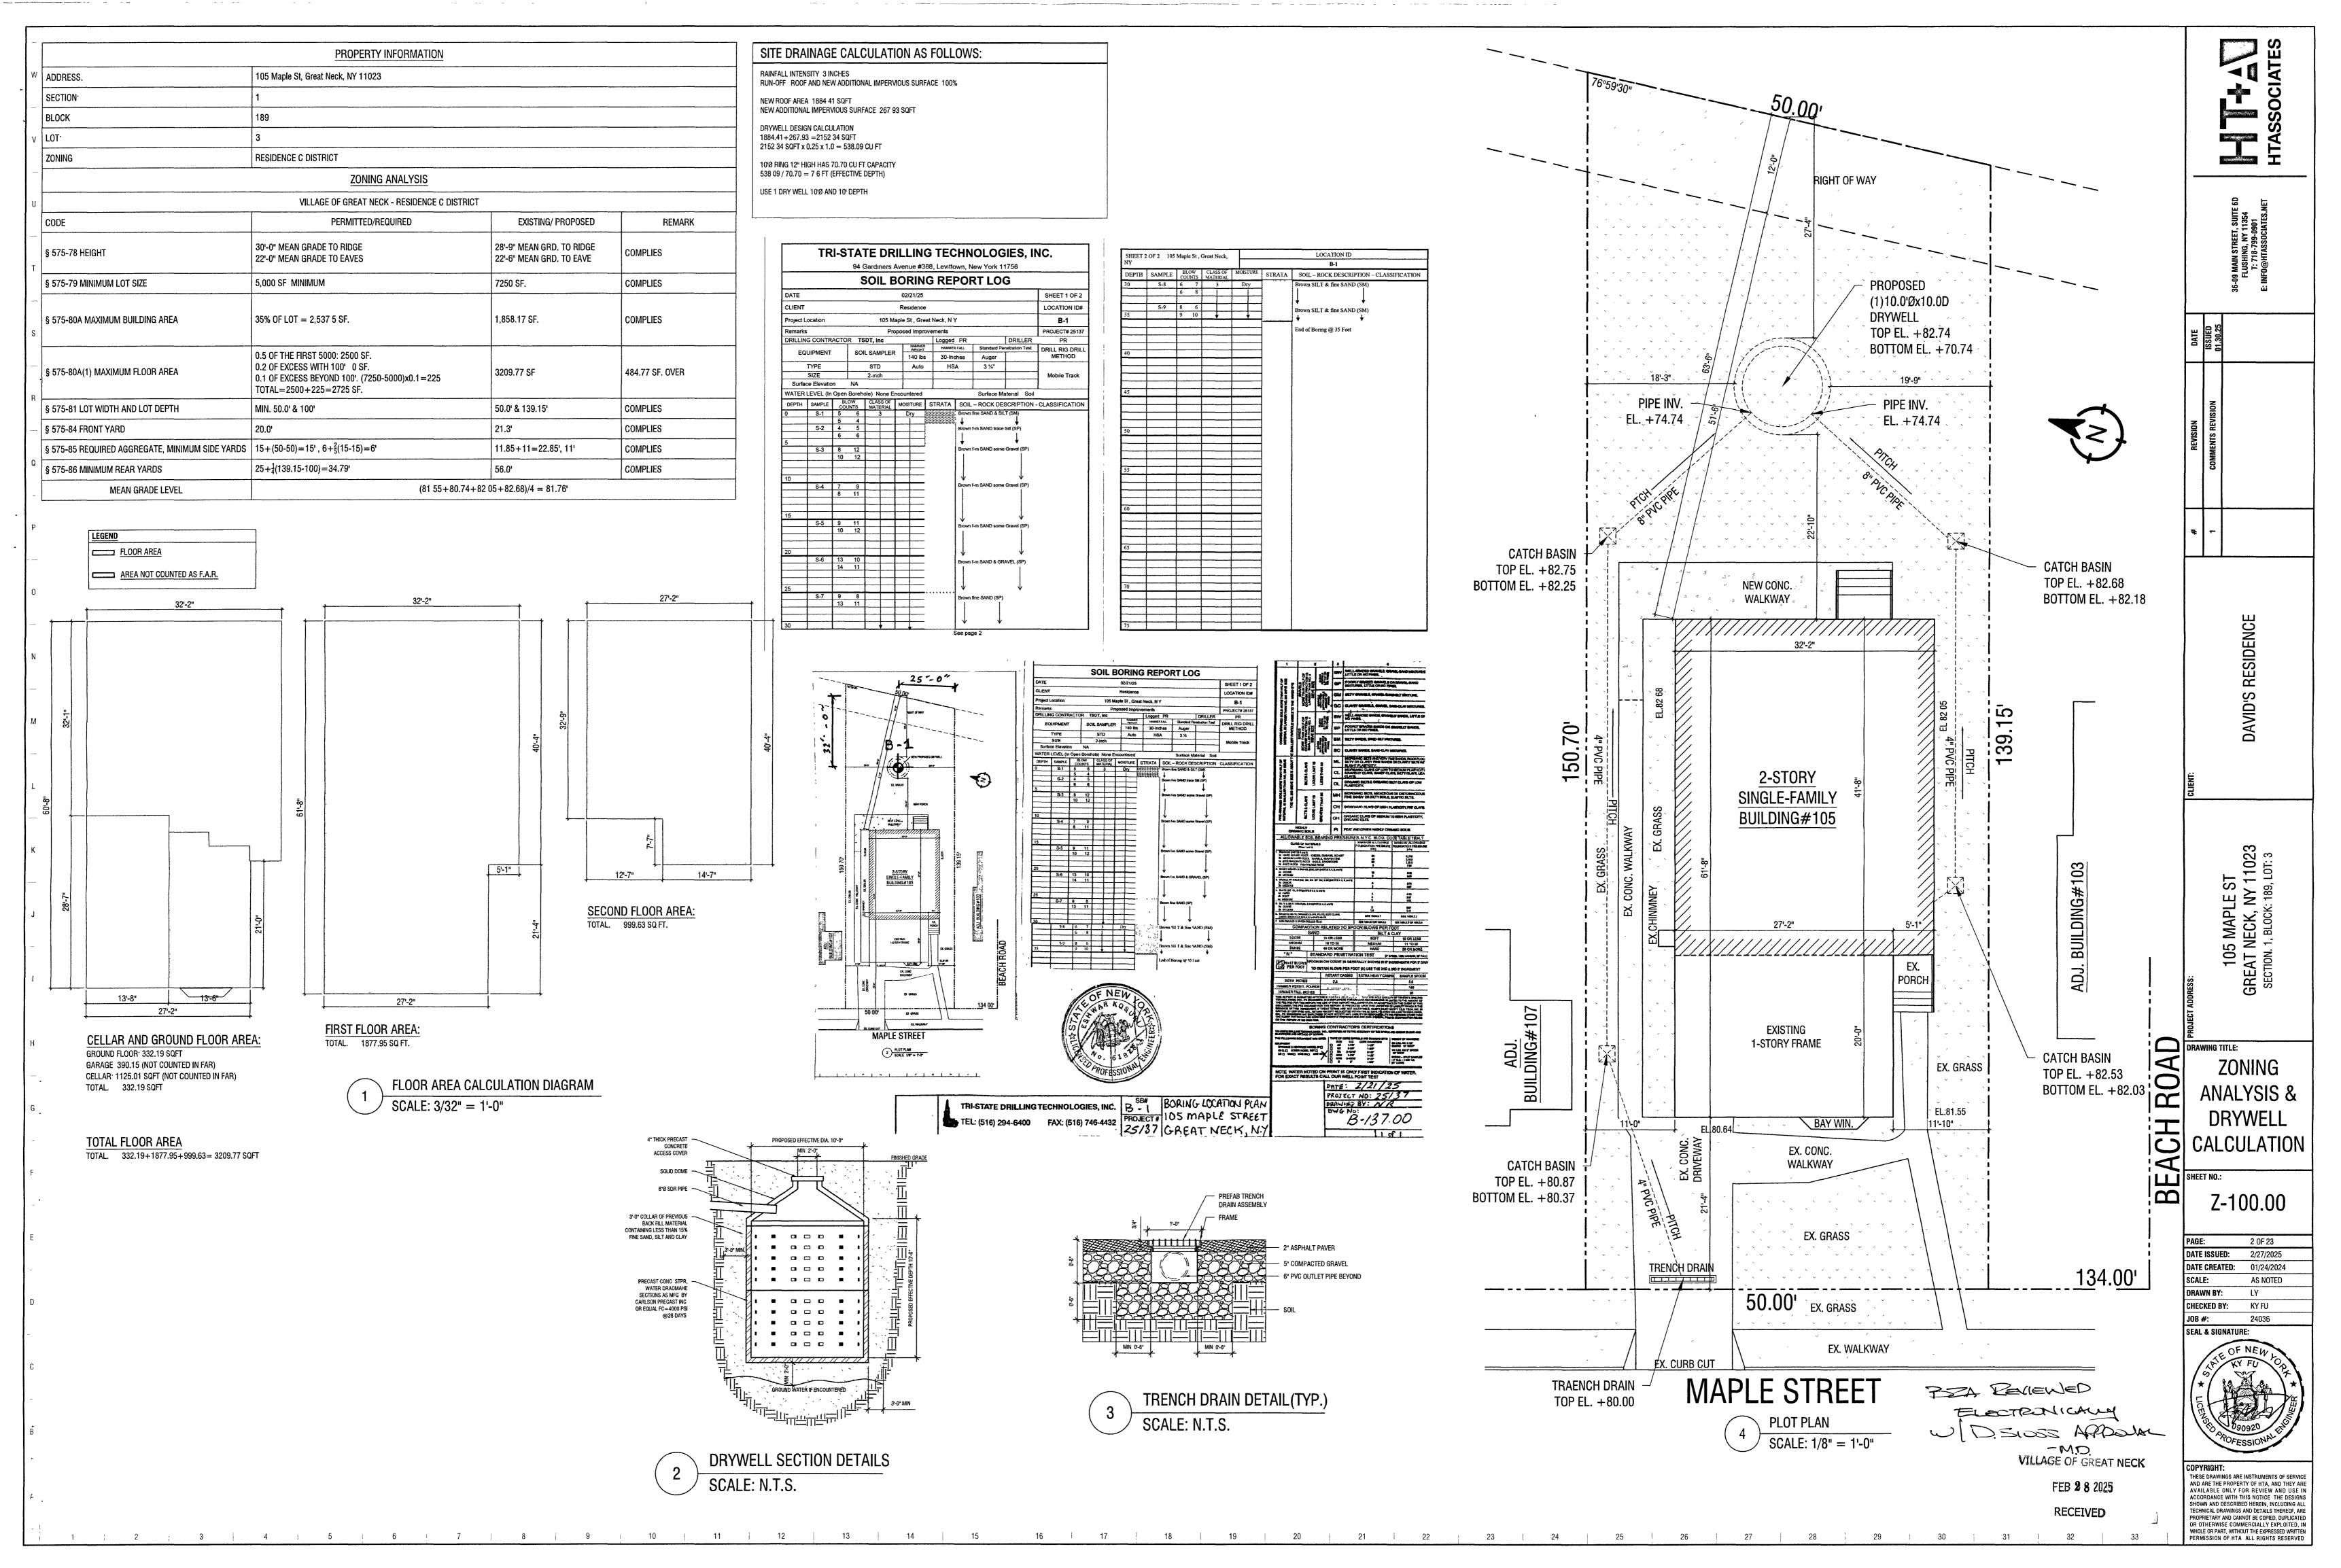

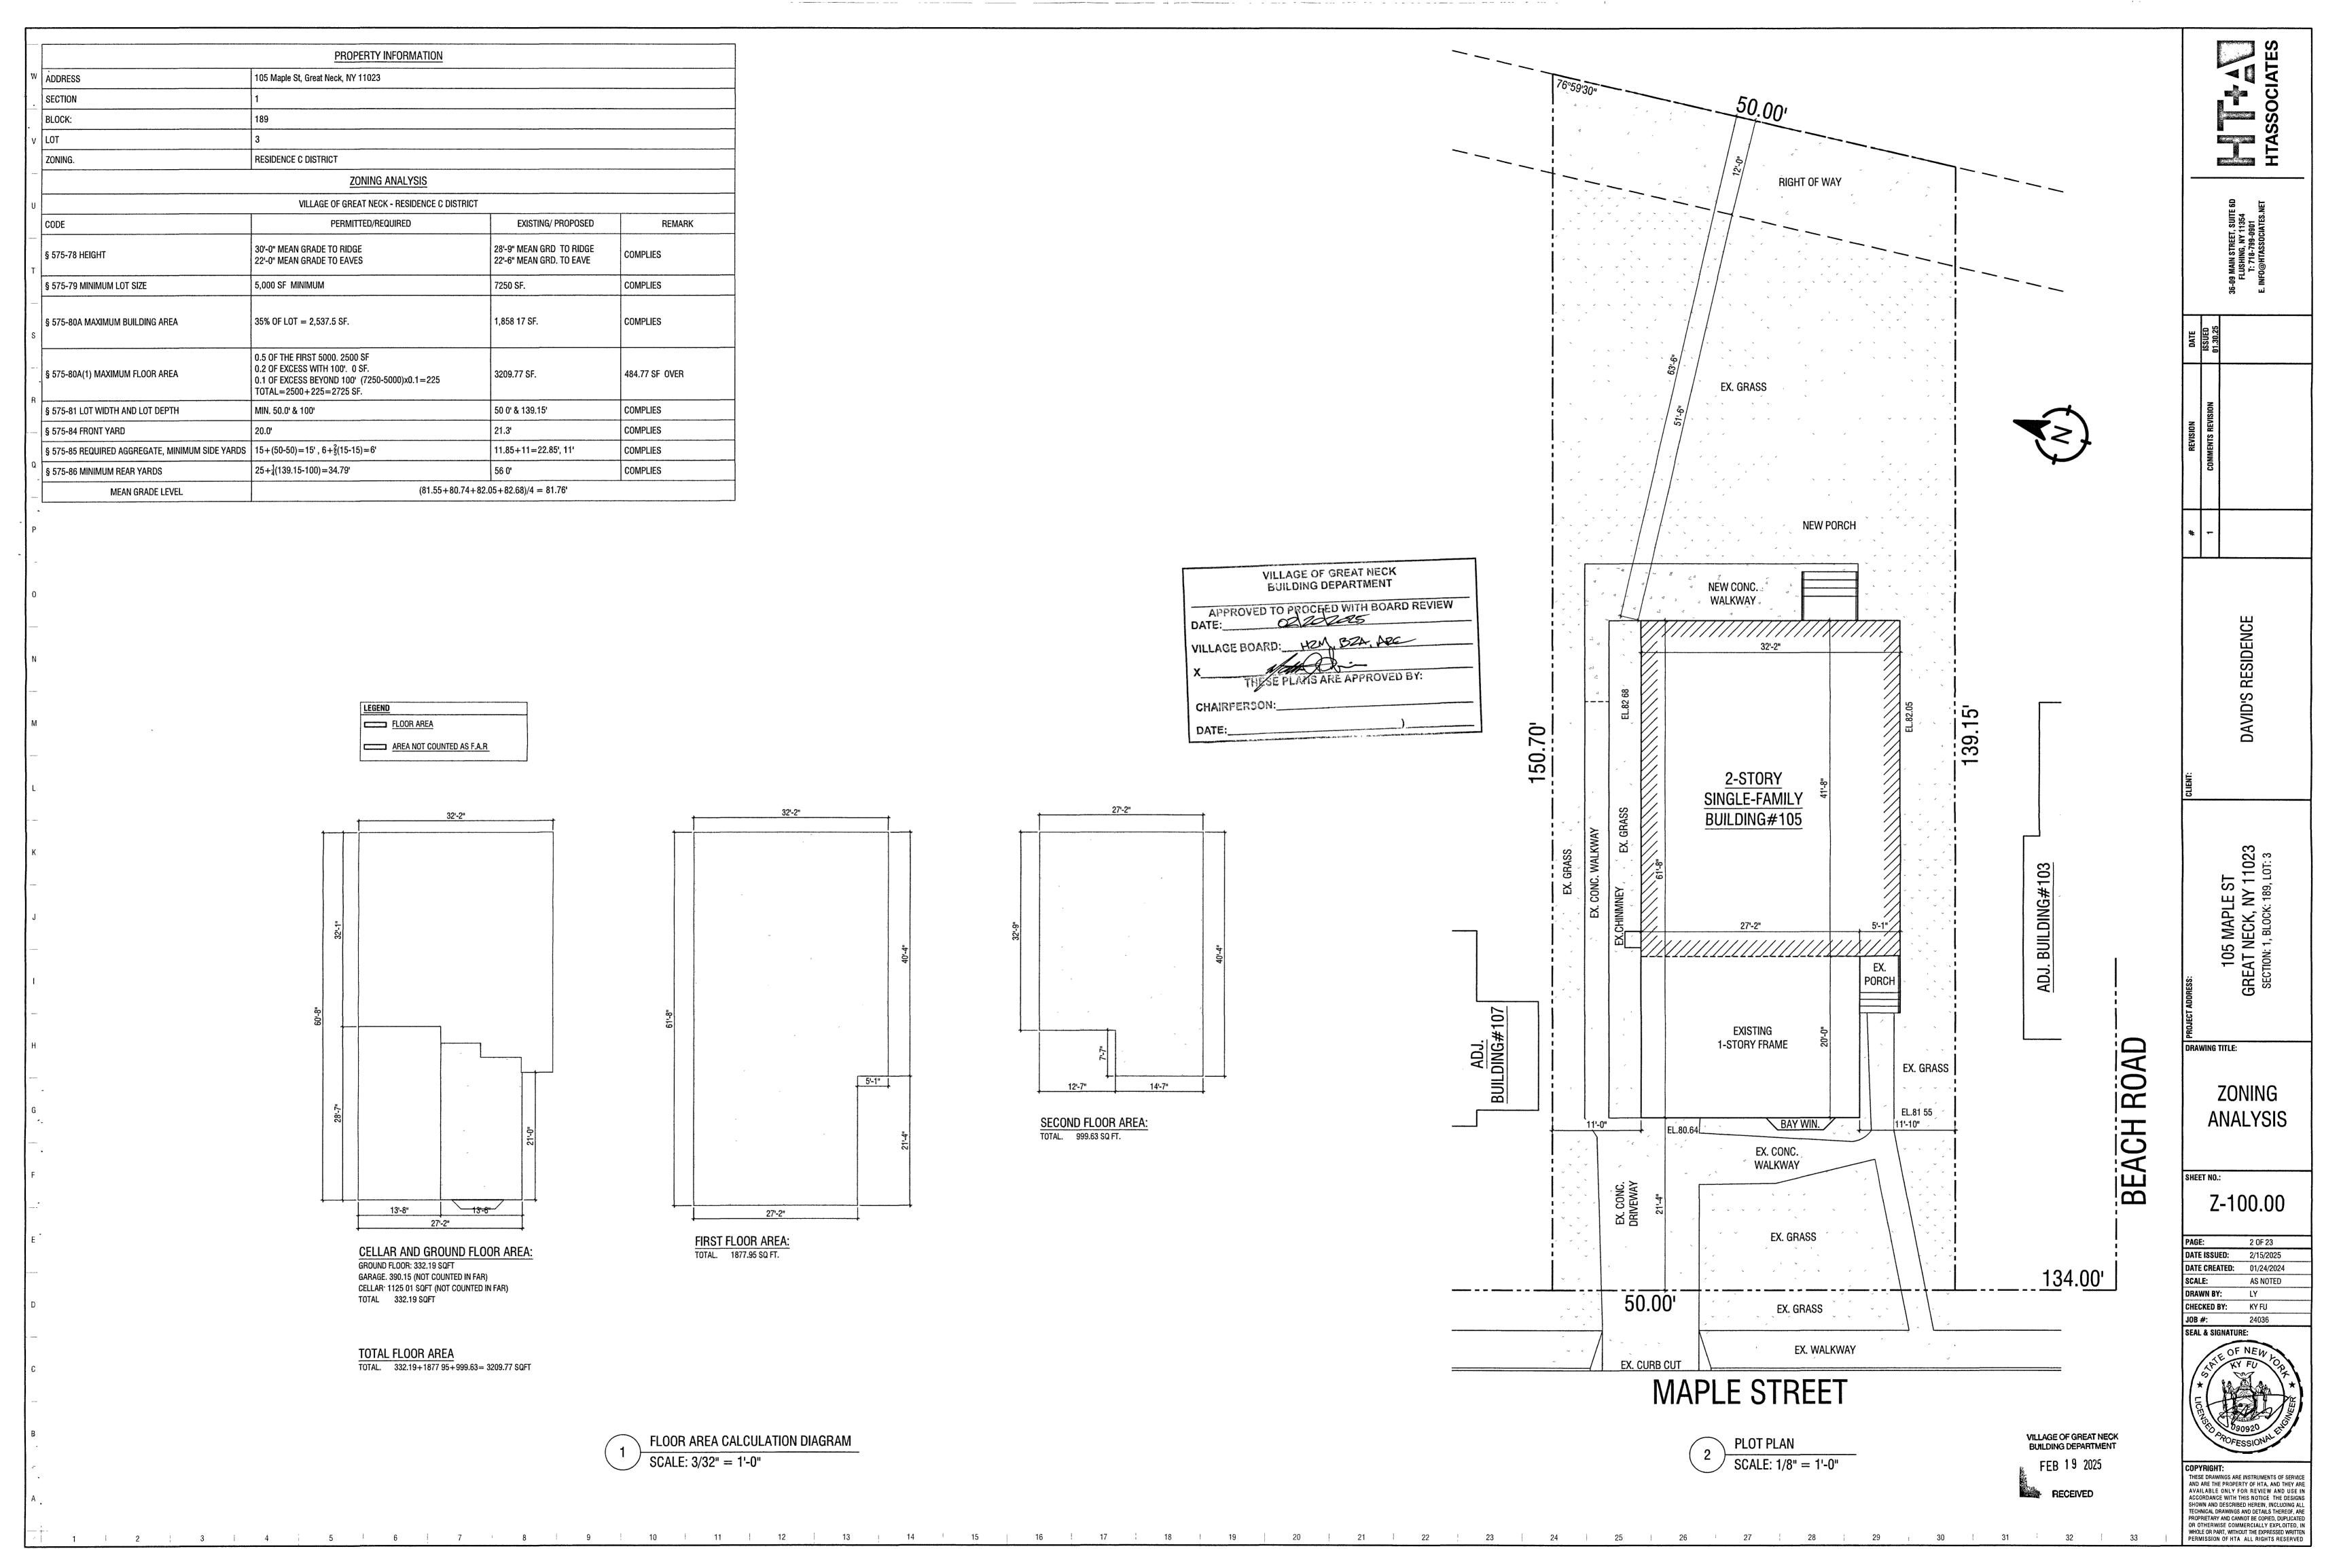

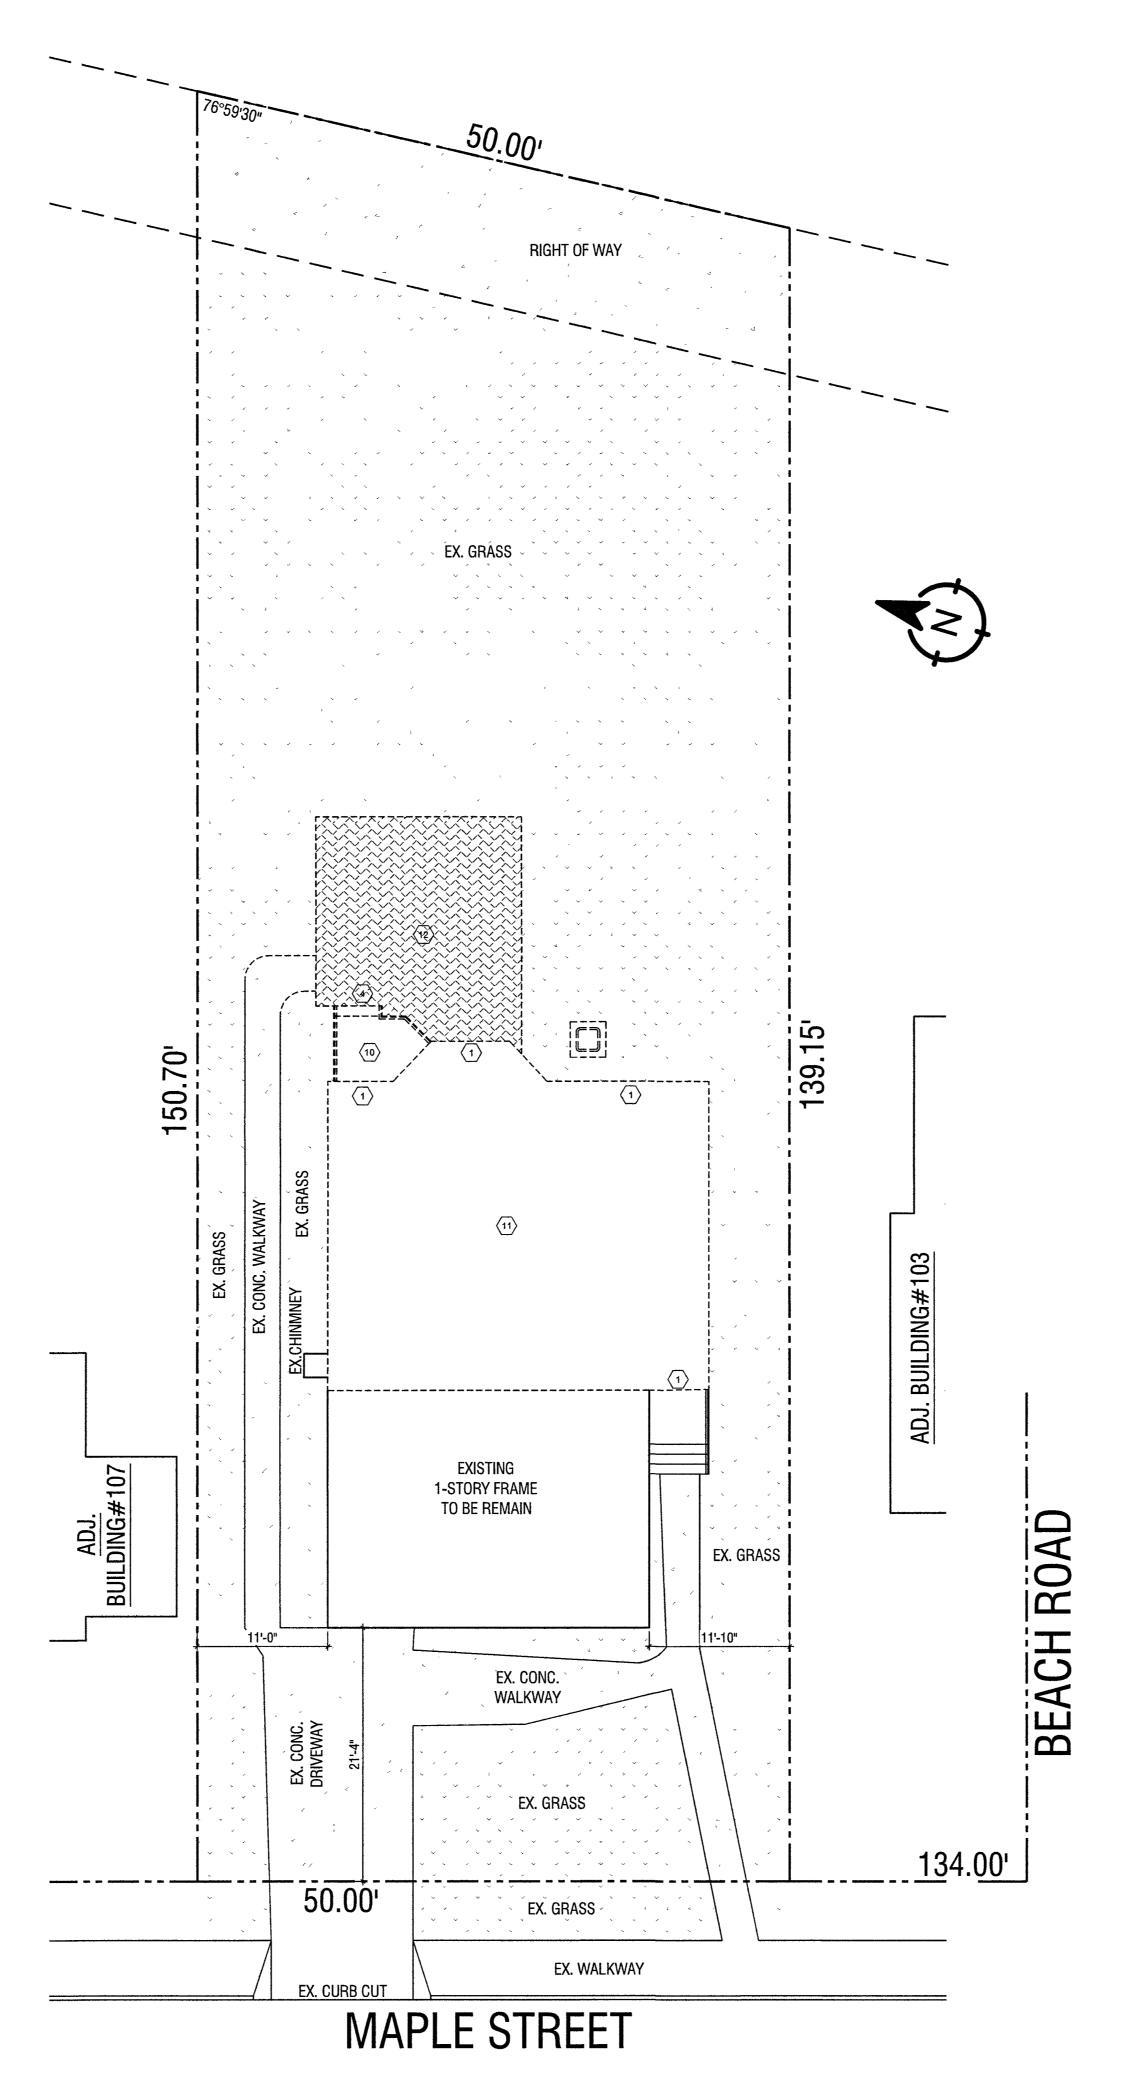

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CLIENT:

REVISION DATE

1 COMMENTS REVISION

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DRAWING TITLE:

SITE EMOLITION PLAN

T NO.:

DM-100.00

PAGE: 3 OF 23

DATE ISSUED: 2/15/2025

DATE CREATED: 01/24/2024

SCALE: AS NOTED

DRAWN BY: LW

CHECKED BY: KY FU

JOB #: 24036

SEAL & SIGNATURE:

OF NEW FU


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FEB 19 2025 RECEIVED

VILLAGE OF GREAT NECK BUILDING DEPARTMENT

DEMO. SITE PLAN

SCALE: 1/8"=1'-0"

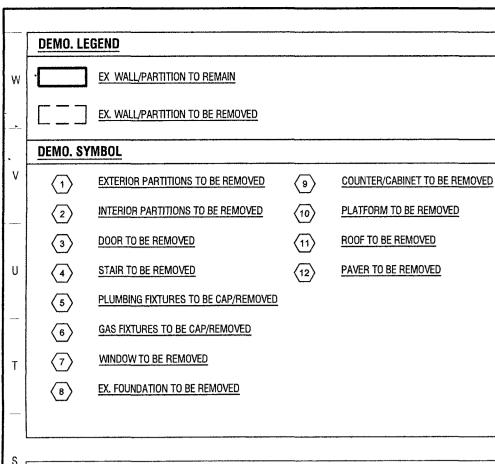

DEMOLITION NOTES

CONTRACTOR SHALL DEMOLISH AND DISPOSE OF DEBRIS AS REQUIRED FOR THE NEW CONSTRUCTION INDICATED ON THE CONSTRUCTION DRAWINGS INCLUDING EXISTING PARTITIONS. DOOR AND BUCK ASSEMBLIES, CEILINGS, TIES, BLACK IRON, SOFFITS, LIGHT BOXES, LIGHT FIXTURES. AIR CONDITIONING CONTROLS AND DUCT WORK (SPECIFICALLY CALLED FOR AS BEING REMOVED) PLUMBING ROUGHING, WALL AND FLOOR ELECTRICAL, TELEPHONE AND SIGNAL OUTLES AND ASSOCIATED CONDUIT. CONDUITS LEFT AFTER CEILING AND WALL DEMOLITION INCLUDING SWITCH BOXES, PLATES, BRIDGES AND ANY OTHER TELEPHONE AND ELECTRICAL WIRING, RESILIENT FLOORING AND BASE, CARPET AND UNDER LAYMENT, AND ANY WORK SHOWN OR IMPLIED IN PROJECT DOCUMENTS THOSE NOT BEING REUSED IN NEW CONSTRUCTION, AND ARE SALVAGEABLE. SHALL BE TURNED OVER TO OWNER UPON REQUEST ALL ITEMS NOT BEING REUSED OR RETURNED TO OWNER AND ALL REBURBISH AND DEBRIS SHALL BE CARTED AWAY. EXISTING WORK TO BE RETAINED SHALL BE ALTERED OR REWORKED AS SHOWN OR IMPLIED IN

DURING THE ENTIRE PERIOD OF DEMOLITON AND CONSTRUCTION ALL EXISTING EXITS, EXIT LIGHTING TO REMAIN, FIRE PROTECTION DEVICES AND FIRE ALARMS SHALL MAINTAINED DO NOT CLOSE OR OBSTRUCT WALKWAYS, PASSAGEWAYS OR STAIRWAYS DO NOT STORE OR PLACE MATERIALS IN PASSAGEWAYS, STAIRS OR WITHIN OTHER MEANS OF EGRESS CONDUCT OPERATIONS WITH MINIMUM TRAFFIC INTERFERENCE

CONTRACTOR SHALL PROVIDE AND MAINTAIN ALL FACILITIES FOR TEMPORARY LIGHT AND POWER WITHIN THE CONSTRUCTION AREA DURING THE ENTIRE BUILDING PERIOD, NECESSARY MATERIALS TRADES REGARDLESS OF SIZE, AND ALL LABOR NEEDED TO KEEP THIS TEMPORARY SYSTEM ENERGIZED DURING THE ENTIRE STANDARD WORKING TIME OF ALL TRADE POWER SHALL BE OBTAINED FROM THE BUILDING DISTRIBUTION SYSTEM ALL MATERIALS AND EQUIPMENT OF THE TEMPORARY SYSTEM SHALL BE REMOVED PROGRESSIVELY AS NO LONGER NEEDED NO OUTAGES OF EXISTING LIGHTING OR POWER CIRCUITS SHALL BE PERMITTED WITHOUT OWNER'S PRIOR CONSENT ALL DEMOLITION AND CUTTING WORK SHALL COMPLY WITH THE RULES AND REGULATIONS OF THE BUILDING, AND ANY WORK REQUIRED DURING OTHER THAN NORMAL WORKING HOURS SHALL BE INCLUDED IN THE PROPOSAL. INSTALL DUSTPROOF PARTITIONS AS PER GENERAL NOTES

CONTRACTOR SHALL INCLUDE IN HIS WORK THE REMOVAL AND REINSTALLATION OF ANY LIGHT FIXTURES, CEILING TILES, GYPSUM BOARD AND/OR PLASTER CEILING. ETC IN THE CEILING OF FLOOR ELECTRICAL /TELEPHONE / SIGNAL WORK, ETC , AND ANY ASSOCIATED WORK INDICATED ON PROJECT DOCUMENTS IF NEW WORK CAN NOT BE INSTALLED DUE TO INTERFERENCE OF EXISTING NORMAL OFFICE HOURS IN OCCUPIED AREAS OR AS DIRECTED BY OWNER / LANDLORD. ANY CEILING TILE DAMAGED DURING THIS WORK SHALL BE REPLACED WITH NEW MATCHING CEILING TILE AND THE CEILING TILE PAINTED TO MATCH CONTIGUOUS AREA WITH NON-BRIDGING PAINT GYPSUM BOARD AND / OR PLASTER CEILING SHALL BE PATCHED AS REQUIRED TO MATCH ADJACENT SURFACE AND PAINTED TO MATCH CONTIGUOUS AREA CONTRACTOR SHALL REMOVE ALL ELECTRICAL AND TELEPHONE OUTLET SWITCHES, CONDUITS, ETC

IN PARTITIONS INDICATED FOR DEMOLITION BEFORE STARTING ANY WORK RELATING TO EXISTING UTILITIES (ELECTRICAL, WASTE, WATER, HEAT, ETC) THAT WILL TEMPORARY DISCONTINUE OR DISRUPT SERVICE TO THE EXISTING BUILDING, NOTIFY THE LANDLORD 72 HOURS IN ADVANCE AND OBTAIN THE APPROVAL IN WRITING BEFORE

CONTRACTOR SHALL ARRANGE AND PAY FOR THE DISCONNECTING, REMOVING AND CAPPING UTILITY SERVICES WITHIN AREA OF DEMOLITION. DISCONNECT AND CAP AT RISER. NOTIFY THE PLACE MARKERS IN INDICATED LOCATION OF DISCONNECTED SERVICES. IDENTIFY SERVICE LINES AND CAPPING LOCATIONS ON PROJECT RECORD DOCUMENTS

PROCEEDING WITH THIS PHASE OF THE WORK

PROVIDE AND MAINTAIN TEMPORARY PROTECTION OF THE EXISTING STRUCTURE DESIGNATED TO REMAIN WHERE DEMOLITION, REMOVAL AND NEW WORK IS BEING DONE, CONNECTION MADE, MATERIALS HANDLED OR EQUIPMENT REMOVED

IF REMOVAL OR REROUTING OF ANY ITEMS PENETRATING EXISTING FIRE RATED PARTITIONS (PIPES, DUCTWORK, ETC.) IS REQUIRED, THE CONTRACTOR SHALL PATCH EXISTING PARTITION AS REQUIRED TO MAINTAIN EXISTING FIRE RATING

BE RESPONSIBLE FOR ANY DAMAGE TO THE EXISTING STRUCTURE OR CONTENT DUE TO INSUFFICIENCY OF PROTECTION PROVIDED. PROVIDE ADEQUATE FIRE PROTECTION IN ACCORDANCE WITH LOCAL FIRE DEPARTMENT

REQUIREMENTS. CONTRACTOR SHALL PROVIDE FLOOR CUT-OUT (CHOPPING OR CORE DRILLING) AND PATCHING

REQUIRED FOR THE INSTALLATION OF ALL WORK CONTRACTOR SHALL SURVEY ALL EXISTING FINISHED SURFACES INCLUDING CORNER BEADS, STOPS, ETC, FOR CHIPS, CRACKS, HOLES OR OTHER DEFECTS CAUSING AN APPEARANCE OTHER THAN A

FIRST-CLASS FINISHED INSTALLATION. DEFECTIVE SURFACES SHALL BE REPAIRED, OR IF BEYOND REPAIR, THE CONTRACTOR SHALL REMOVE AND INSTALL NEW SURFACES ANY OTHER DAMAGED SURFACES SHALL BE REPAIRED TO THE SATISFACTION OF ARCHITECT /

CONTRACTOR SHALL INSPECT ALL EXISTING WALL, FLOOR SURFACE, ETC. AND WHERE SURFACES TO REMAIN DO NOT ALIGN AS A RESULT OF DEMOLITION, SHALL PATCH OR INSTALL FURRING TO PROVIDE FOR PERFECTLY SMOOTH, FLUSH, ALIGNED SURFACES CONTRACTOR SHALL FLASH PATCH ALL FLOOR SURFACES TO RECEIVE FINISHED MATERIALS

INDICATED IN PROJECT DOCUMENTS INCLUDING FLOOR MATERIALS BEING SUPPLIED AND INSTALLED BY OWNER'S CONTRACTORS DEMOLISH IN AN ORDERLY AND CAREFUL MANNER AS REQUIRED TO ACCOMMODATED NEW WORK, AND PROTECT EXISTING SUPPORTING STRUCTURAL MEMBERS

UNLESS OTHERWISE INDICATED, THE INTENT IS THAT EXISTING TELEPHONE / SIGNAL AND ELECTRICAL OUTLETS SHALL BE RETAINED IN ALL "EXISTING PARTITIONS TO REMAIN" IF DEMOLITION RESULTS IN DEACTIVATION OF EXISTING CONTIGUOUS ELECTRICAL OUTLETS INSIDE OR OUTSIDE THE PROJECT AREA, THE CONTRACTOR SHALL RECIRCUIT THESE FOR REACTIVATION UNLESS OTHERWISE NOTED, ALL EXISTING FLOOR OUTLETS SHALL BE CAPPED. ANY EXISTING WORK INTERFERING WITH NEW WORK SHOWN IN PROJECT DOCUMENTS SHALL BE

REMOVED, REWORKED AND/OR RELOCATED (TO ARCHITECT'S SATISFACTION) TO CONFORM WITHIN THE PROJECT AREA ALL EXPOSED WIRING, METAL MOLDING, PIPING, PLUMBING FIXTURES, ROUGHING AND OTHER APPUTENANCES NOT SHOWN ON PROJECT DOCUMENTS TO REMAIN SHALL BE REMOVED AND CARTED AWAY BY THE GENERAL CONTRACTOR OR STORED AS DIRECTED. ALL EXISTING WALL COVERING, BASE PANELING, MOLDINGS, ETC. (EXCEPT WORK SPECIFICALLY CALLED FOR AS BEING RETAINED) AND LOOSE PAINT OR PLASTER SHALL BE REMOVED AND SPACKLED OR PLASTER PATCHED TO RECEIVE NEW WALL TREATMENT

ANY UNEVENNESS IN PARTITIONS TO REMAIN SHALL BE SANDED OR CHIPPED AWAY AND SURFACES PATCHED OR SPACKLED TO INSURE A PERFECTLY SMOOTH SURFACE. ARCHITECT / OWNER SHALL APPROVE SURFACE PRIOR TO THE APPLICATION OF FINISH WALL TREATMENT THE CONTRACTOR SHALL DO ALL CUTTING, FITTING AND PATCHING OF HIS WORK THAT MAY BE REQUIRED TO MAKE SEVERAL PARTS FIT TOGETHER PROPERLY AND SHALL NOT ENDANGER ANY

WORK BY CUTTING, EXCAVATING OR OTHERWISE ALTERING THE WORK. 28. THE CONTRACTOR SHALL COORDINATE ALL CUTTING AND PATCHING FOR SERVICE AS CALLED FOR ON MECHANICAL, ELECTRICAL AND PLUMBING DRAWINGS AND SHALL PROVIDE AND INSTALL ALL WALL AND / OR CEILING ACCESS DOORS AS REQUIRED.

29 REPAIR ALL DEMOLITION PERFORMED IN EXCESS OF THAT REQUIRED AT NO COST TO THE OWNER 30. DO NOT INTERFERE WITH THE USE OF ADJACENT AREAS MAINTAIN FREE AND SAFE PASSAGE TO AND


31. CEASE OPERATIONS AND NOTIFY THE ARCHITECT / ENGINEER AND LANDLORD IMMEDIATELY, IF SAFETY OF STRUCTURE APPEARES TO BE ENDANGERED TAKE PRECAUTIONS TO PROPERLY SUPPORT STRUCTURE DO NOT RESUME OPERATION UNTIL SAFETY IS RESTORED. 32 REMOVE DEMOLISHED MATERIALS, TOOLS AND EQUIOMENTS, ETC. FROM THE SITE UPON

COMPLETION OF WORK REMOVE HAZARDOUS MATERIALS AND DIPOSE OF BY SAFE MEANS SO AS NOT TO ENDANGER HEALTH OF WORKERS OR PUBLIC. COMPLY WITH ALL RULES AND REGULATIONS OF GOVERNMENT AUTHORITIES HAVING JURISDICTION OVER HAZARDOUS AND NON-HAZARDOUS DEMOLISHED MATERIALS ELEVATOR SERVICE COSTS TO BE INCLUDED IN THE CONTRACT PRICE LEAVE SITE IN A CONDITION ACCEPTED TO THE ARCHITECT / OWNER AREA TO BE BROOM CLEAN 33 CONTRACTOR SHALL PROVIDE METAL LATH AND PLASTER OVER ALL NEW CONDUIT CHASES IN


ALL EXISTING AREAS TO REMAIN AND EXISTING AREAS AFFECTED BY DEMOLITION OR NEW CONSTRUCTION WORK SHOWN ON DRAWINGS SHALL BE PATCHED AS REQUIRED TO MATCH IMMEDIATE ADJACENT AREAS IN CONSTRUCTION, MATERIALS, FIRE RATING, FINISH AND COLOR, UNLESS OTHERWISE NOTED CONTRACTOR SHALL CAP AND FLUSH OFF ALL PROJECTING PLUMBING, FLOOR ELECTRICAL AND

TELEPHONE OUTLET AND OTHER PROJECTING ITEMS BEING ABANDONED BEHIND FINISH SURFACES, PATCHING SURFACES TO MATCH ADJACENT AREAS AFTER DEMOLITION AND PRIOR TO ANY FABRICATION OR INSTALLATION, CONTRACTOR SHALL PROVIDE LEVEL (BENCH) MARKS ON ALL COLUMNS (OR ABOUT 25' APART), THESE MARKS SHALL BE

ESTABLISHED OFF THE HIGHEST POINT OF FLOOR FINISH SURFACE AND SHALL BE USED BY ALL TRADES FOR THEIR INSTALLATION. DURING DEMOLITION AND CONSTRUCTION, EXISTING FIRE AND SMOKE DETECTION SYSTEMS WITHIN PROJECT AREAS ARE TO BE REMAIN OPERATION

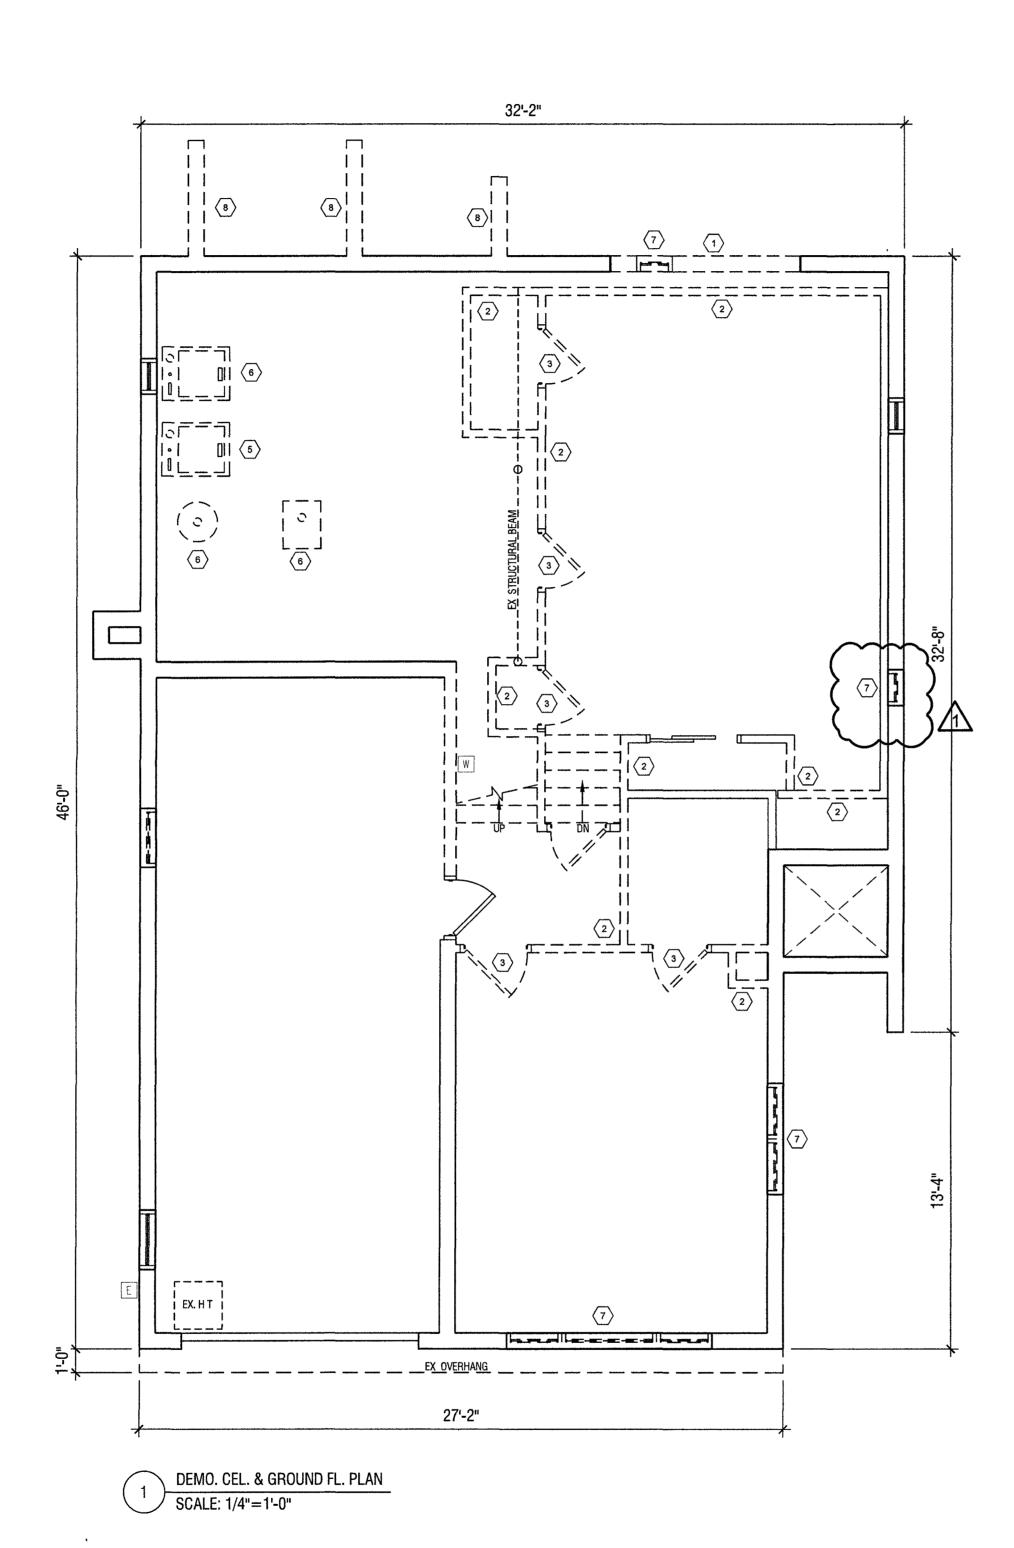

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PLANS

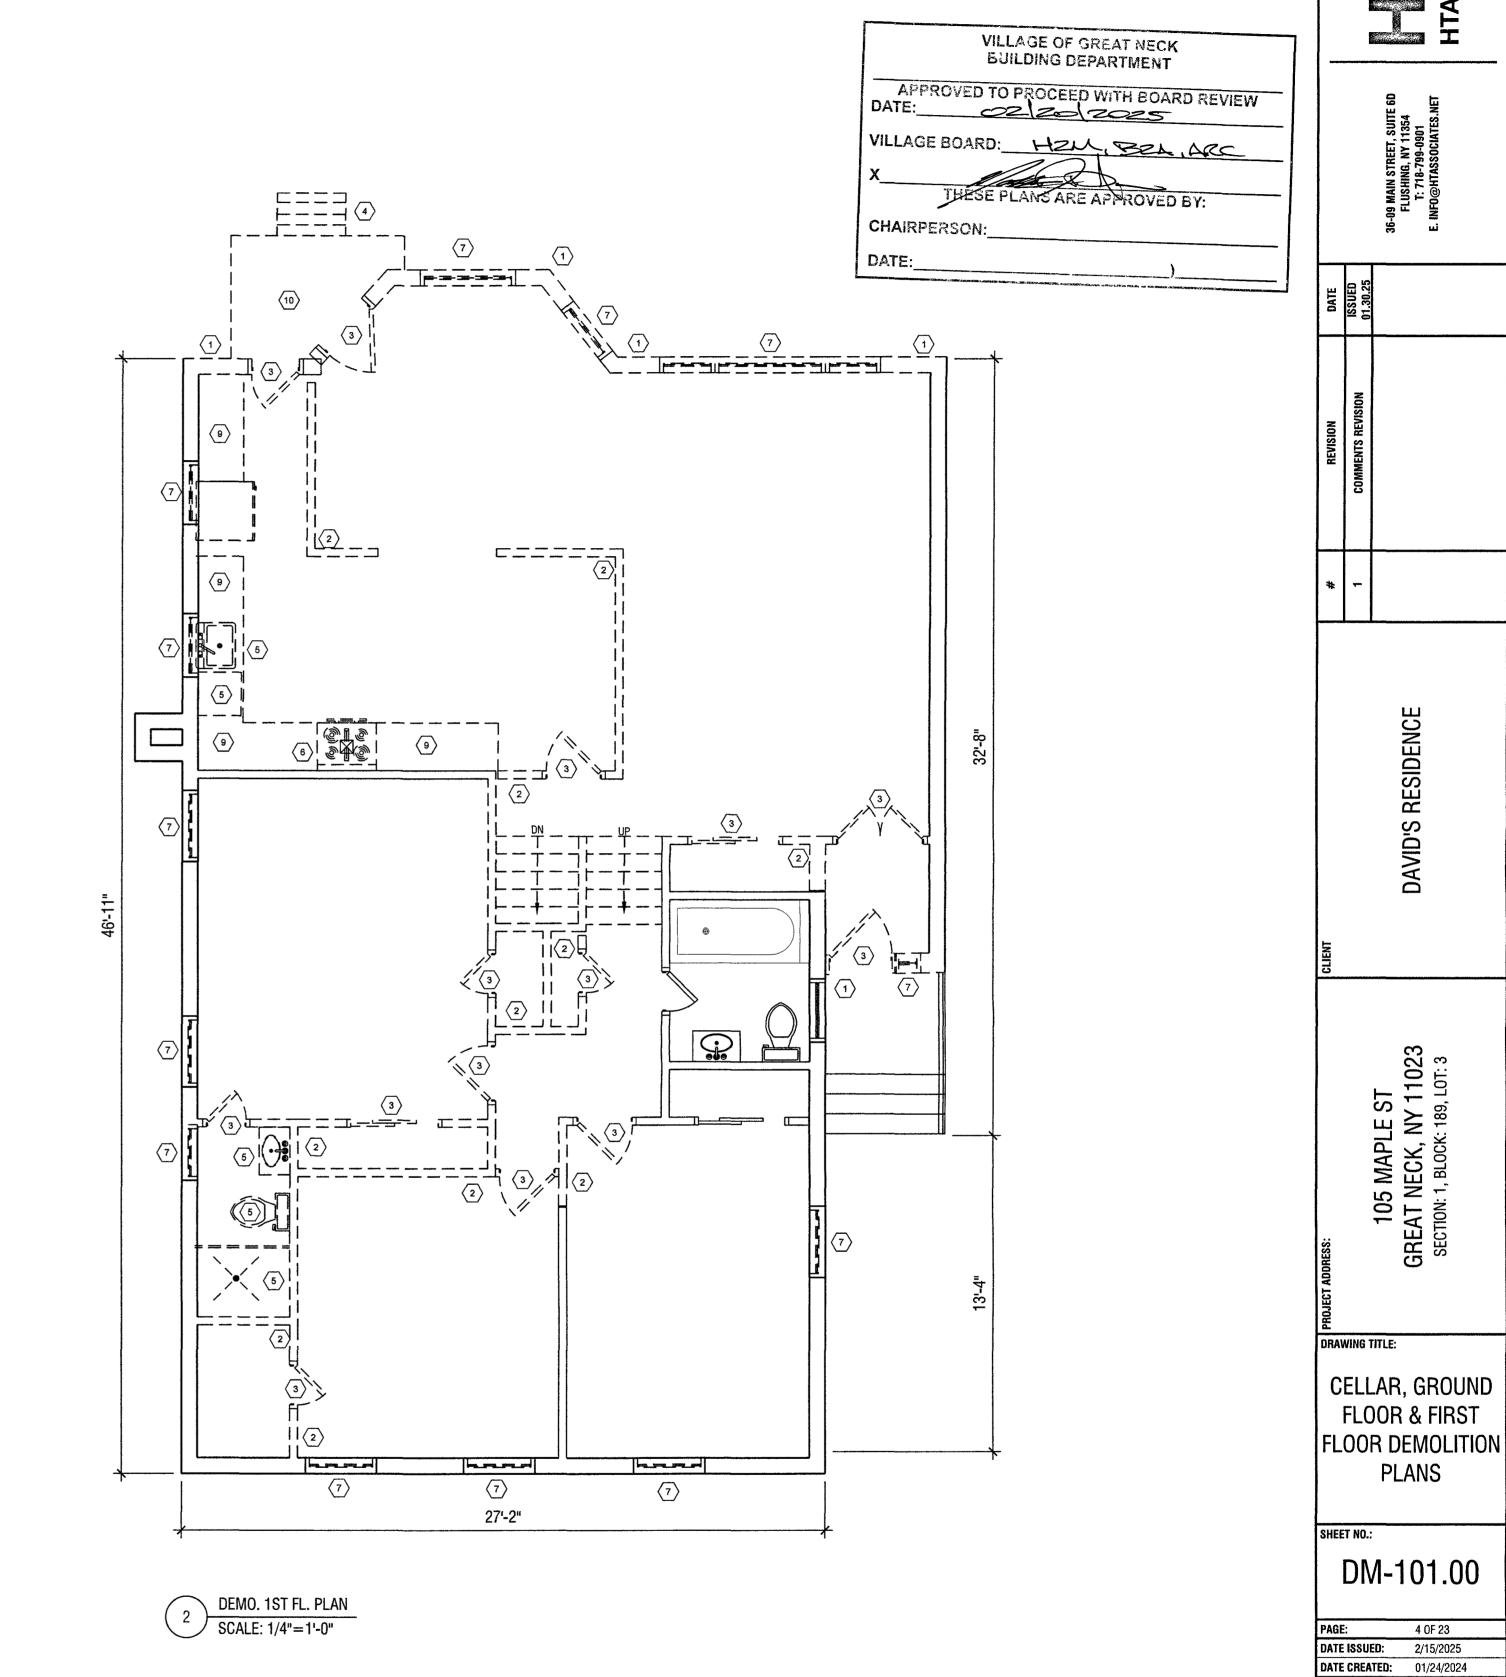4 OF 23

AS NOTED

LW

KY FU

24036

DRAWN BY:

JOB #:

CHECKED BY:

SEAL & SIGNATURE:

DEMO, LEGEND
EX WALL/PARTITION TO REMAIN
EX WALL/PARTITION TO BE REMOVED
DEMO. SYMBOL
1 EXTERIOR PARTITIONS TO BE REMOVED 9 COUNTER/CABINET TO BE F
2 INTERIOR PARTITIONS TO BE REMOVED (10) PLATFORM TO BE REMOVED
DOOR TO BE REMOVED (11) ROOF TO BE REMOVED
STAIR TO BE REMOVED 12 PAVER TO BE REMOVED
-
5 PLUMBING FIXTURES TO BE CAP/REMOVED
GAS FIXTURES TO BE CAP/REMOVED
(7) WINDOW TO BE REMOVED
EX. FOUNDATION TO BE REMOVED
8 EX. FOUNDATION TO BE REMOVED
DEMOLITION NOTES
DEMOLITION NOTES
1 CONTRACTOR SHALL DEMOLISH AND DISPOSE OF DEBRIS AS REQUIRED FOR THE NEW

CONTRACTOR SHALL DEMOLISH AND DISPOSE OF DEBRIS AS REQUIRED FOR THE NEW CONSTRUCTION INDICATED ON THE CONSTRUCTION DRAWINGS INCLUDING EXISTING PARTITIONS, DOOR AND BUCK ASSEMBLIES, CEILINGS, TIES, BLACK IRON, SOFFITS, LIGHT BOXES, LIGHT FIXTURES, AIR CONDITIONING CONTROLS AND DUCT WORK (SPECIFICALLY CALLED FOR AS BEING REMOVED), PLUMBING ROUGHING, WALL AND FLOOR ELECTRICAL, TELEPHONE AND SIGNAL OUTLES AND ASSOCIATED CONDUIT, CONDUITS LEFT AFTER CEILING AND WALL DEMOLITION INCLUDING SWITCH BOXES, PLATES, BRIDGES AND ANY OTHER TELEPHONE AND ELECTRICAL WIRING, RESILIENT FLOORING AND BASE, CARPET AND UNDER LAYMENT, AND ANY WORK SHOWN OR IMPLIED IN PROJECT DOCUMENTS THOSE NOT BEING REUSED IN NEW CONSTRUCTION, AND ARE SALVAGEABLE, SHALL BE TURNED OVER TO OWNER UPON REQUEST ALL ITEMS NOT BEING REUSED OR RETURNED TO OWNER AND ALL REBURBISH AND DEBRIS SHALL BE CARTED AWAY

EXISTING WORK TO BE RETAINED SHALL BE ALTERED OR REWORKED AS SHOWN OR IMPLIED IN PROJECT DOCUMENTS

PROJECT DOCUMENTS

DURING THE ENTIRE PERIOD OF DEMOLITON AND CONSTRUCTION ALL EXISTING EXITS, EXIT LIGHTING TO REMAIN, FIRE PROTECTION DEVICES AND FIRE ALARMS SHALL MAINTAINED. DO NOT CLOSE OR OBSTRUCT WALKWAYS, PASSAGEWAYS OR STAIRWAYS. DO NOT STORE OR PLACE MATERIALS IN PASSAGEWAYS, STAIRS OR WITHIN OTHER MEANS OF EGRESS CONDUCT OPERATIONS WITH MINIMUM TRAFFIC INTERFERENCE.

CONTRACTOR SHALL PROVIDE AND MAINTAIN ALL FACILITIES FOR TEMPORARY LIGHT AND POWER WITHIN THE CONSTRUCTION AREA DURING THE ENTIRE BUILDING PERIOD, NECESSARY MATERIALS AND LABOR TO MAKE POWER CONNECTIONS FOR MACHINE, PORTABLE TOOLS, ETC USED BY OTHER TRADES REGARDLESS OF SIZE, AND ALL LABOR NEEDED TO KEEP THIS TEMPORARY SYSTEM ENERGIZED DURING THE ENTIRE STANDARD WORKING TIME OF ALL TRADE POWER SHALL BE OBTAINED FROM THE BUILDING DISTRIBUTION SYSTEM ALL MATERIALS AND EQUIPMENT OF THE TEMPORARY SYSTEM SHALL BE REMOVED PROGRESSIVELY AS NO LONGER NEEDED. NO OUTAGES OF EXISTING LIGHTING OR POWER CIRCUITS SHALL BE PERMITTED WITHOUT OWNER'S PRIOR CONSENT.

ALL DEMOLITION AND CUTTING WORK SHALL COMPLY WITH THE RULES AND REGULATIONS OF THE BUILDING, AND ANY WORK REQUIRED DURING OTHER THAN NORMAL WORKING HOURS SHALL BE INCLUDED IN THE PROPOSAL INSTALL DUSTPROOF PARTITIONS AS PER GENERAL NOTES

CONTRACTOR SHALL INCLUDE IN HIS WORK THE REMOVAL AND REINSTALLATION OF ANY LIGHT FIXTURES, CEILING TILES, GYPSUM BOARD AND/OR PLASTER CEILING, ETC. IN THE CEILING OF FLOOR BELOW AS REQUIRED FOR REMOVAL OF EXISTING AND INSTALLATION OF ANY PLUMBING, ELECTRICAL /TELEPHONE / SIGNAL WORK, ETC , AND ANY ASSOCIATED WORK INDICATED ON PROJECT DOCUMENTS IF NEW WORK CAN NOT BE INSTALLED DUE TO INTERFERENCE OF EXISTING WORK, EXISTING WORK SHALL BE RELOCATED. THIS WORK SHALL BE DONE DURING OTHER THAN NORMAL OFFICE HOURS IN OCCUPIED AREAS OR AS DIRECTED BY OWNER / LANDLORD. ANY CEILING TILE DAMAGED DURING THIS WORK SHALL BE REPLACED WITH NEW MATCHING CEILING TILE AND THE CEILING TILE PAINTED TO MATCH CONTIGUOUS AREA WITH NON-BRIDGING PAINT GYPSUM BOARD AND / OR PLASTER CEILING SHALL BE PATCHED AS REQUIRED TO MATCH ADJACENT SURFACE AND PAINTED TO MATCH CONTIGUOUS AREA

IN PARTITIONS INDICATED FOR DEMOLITION

BEFORE STARTING ANY WORK RELATING TO EXISTING UTILITIES (ELECTRICAL, WASTE, WATER, HEAT, ETC.) THAT WILL TEMPORARY DISCONTINUE OR DISRUPT SERVICE TO THE EXISTING BUILDING, NOTIFY THE LANDLORD 72 HOURS IN ADVANCE AND OBTAIN THE APPROVAL IN WRITING BEFORE PROCEEDING WITH THIS PHASE OF THE WORK

CONTRACTOR SHALL ARRANGE AND PAY FOR THE DISCONNECTING, REMOVING AND CAPPING

UTILITY SERVICES WITHIN AREA OF DEMOLITION DISCONNECT AND CAP AT RISER NOTIFY THE LANDLORD IN ADVANCE AND OBTAIN APPROVAL BEFORE STARTING THIS WORK

11 PLACE MARKERS IN INDICATED LOCATION OF DISCONNECTED SERVICES IDENTIFY SERVICE LINES AND CAPPING LOCATIONS ON PROJECT RECORD DOCUMENTS.

12 PROVIDE AND MAINTAIN TEMPORARY PROTECTION OF THE EXISTING STRUCTURE DESIGNATED TO REMAIN WHERE DEMOLITION, REMOVAL AND NEW WORK IS BEING DONE, CONNECTION MADE, MATERIALS HANDLED OR EQUIPMENT REMOVED

MATERIALS HANDLED OR EQUIPMENT REMOVED

13 IF REMOVAL OR REROUTING OF ANY ITEMS PENETRATING EXISTING FIRE RATED PARTITIONS (PIPES, DUCTWORK, ETC.) IS REQUIRED, THE CONTRACTOR SHALL PATCH EXISTING PARTITION AS REQUIRED TO MAINTAIN EXISTING FIRE RATING

14. BE RESPONSIBLE FOR ANY DAMAGE TO THE EXISTING STRUCTURE OR CONTENT DUE TO INSUFFICIENCY OF PROTECTION PROVIDED.

15. PROVIDE ADEQUATE FIRE PROTECTION IN ACCORDANCE WITH LOCAL FIRE DEPARTMENT

15. PROVIDE ADEQUATE HRE PROTECTION IN ACCURDANCE WITH LOCAL HRE DEPARTMENT REQUIREMENTS.

16. CONTRACTOR SHALL PROVIDE FLOOR CUT-OUT (CHOPPING OR CORE DRILLING) AND PATCHING REQUIRED FOR THE INSTALLATION OF ALL WORK.

17 CONTRACTOR SHALL SURVEY ALL EXISTING FINISHED SURFACES INCLUDING CORNER BEADS, STOPS, ETC FOR CHIPS, CRACKS, HOLES OR OTHER DEFECTS CAUSING AN APPEARANCE OTHER THAN A FIRST-CLASS FINISHED INSTALLATION DEFECTIVE SURFACES SHALL BE REPAIRED, OR IF BEYOND REPAIR, THE CONTRACTOR SHALL REMOVE AND INSTALL NEW SURFACES
 18. ANY OTHER DAMAGED SURFACES SHALL BE REPAIRED TO THE SATISFACTION OF ARCHITECT / OWNER.
 19. CONTRACTOR SHALL INSPECT ALL EXISTING WALL, FLOOR SURFACE, ETC AND WHERE SURFACES

9. CONTRACTOR SHALL INSPECT ALL EXISTING WALL, FLOOR SURFACE, ETC. AND WHERE SURFACES
TO REMAIN DO NOT ALIGN AS A RESULT OF DEMOLITION, SHALL PATCH OR INSTALL FURRING TO
PROVIDE FOR PERFECTLY SMOOTH, FLUSH, ALIGNED SURFACES

CONTRACTOR SHALL FLASH PATCH ALL FLOOR SURFACES TO RECEIVE FINISHED MATERIALS
INDICATED IN PROJECT DOCUMENTS INCLUDING FLOOR MATERIALS BEING SUPPLIED AND INSTALLED
BY OWNER'S CONTRACTORS

DEMOLISH IN AN ORDERLY AND CAREFUL MANNER AS REQUIRED TO ACCOMMODATED NEW WORK, AND PROTECT EXISTING SUPPORTING STRUCTURAL MEMBERS.

UNLESS OTHERWISE INDICATED, THE INTENT IS THAT EXISTING TELEPHONE / SIGNAL AND ELECTRICAL OUTLETS SHALL BE RETAINED IN ALL "EXISTING PARTITIONS TO REMAIN". IF DEMOLITION RESULTS IN DEACTIVATION OF EXISTING CONTIGUOUS ELECTRICAL OUTLETS INSIDE OR OUTSIDE THE

PROJECT AREA, THE CONTRACTOR SHALL RECIRCUIT THESE FOR REACTIVATION UNLESS OTHERWISE NOTED, ALL EXISTING FLOOR OUTLETS SHALL BE CAPPED ANY EXISTING WORK INTERFERING WITH NEW WORK SHOWN IN PROJECT DOCUMENTS SHALL BE REMOVED, REWORKED AND/OR RELOCATED (TO ARCHITECT'S SATISFACTION) TO CONFORM. WITHIN THE PROJECT AREA ALL EXPOSED WIRING, METAL MOLDING, PIPING, PLUMBING FIXTURES, ROUGHING AND OTHER APPUTENANCES NOT SHOWN ON PROJECT DOCUMENTS TO REMAIN SHALL BE REMOVED AND CARTED AWAY BY THE GENERAL CONTRACTOR OR STORED AS DIRECTED ALL EXISTING WALL COVERING, BASE PANELING, MOLDINGS, ETC. (EXCEPT WORK SPECIFICALLY

CALLED FOR AS BEING RETAINED) AND LOOSE PAINT OR PLASTER SHALL BE REMOVED AND SPACKLED OR PLASTER PATCHED TO RECEIVE NEW WALL TREATMENT ANY UNEVENNESS IN PARTITIONS TO REMAIN SHALL BE SANDED OR CHIPPED AWAY AND SURFACES PATCHED OR SPACKLED TO INSURE A PERFECTLY SMOOTH SURFACE ARCHITECT / OWNER SHALL APPROVE SURFACE PRIOR TO THE APPLICATION OF FINISH WALL TREATMENT.

THE CONTRACTOR SHALL DO ALL CUTTING, FITTING AND PATCHING OF HIS WORK THAT MAY BE REQUIRED TO MAKE SEVERAL PARTS FIT TOGETHER PROPERLY AND SHALL NOT ENDANGER ANY WORK BY CUTTING. EXCAVATING OR OTHERWISE ALTERING THE WORK.

THE CONTRACTOR SHALL COORDINATE ALL CUTTING AND PATCHING FOR SERVICE AS CALLED FOR ON MECHANICAL, ELECTRICAL AND PLUMBING DRAWINGS AND SHALL PROVIDE AND INSTALL ALL WALL AND / OR CEILING ACCESS DOORS AS REQUIRED REPAIR ALL DEMOLITION PERFORMED IN EXCESS OF THAT REQUIRED AT NO COST TO THE OWNER

29. REPAIR ALL DEMOLITION PERFORMED IN EXCESS OF THAT REQUIRED AT NO COST TO THE OWNER
 30. DO NOT INTERFERE WITH THE USE OF ADJACENT AREAS MAINTAIN FREE AND SAFE PASSAGE TO AND FROM

CEASE OPERATIONS AND NOTIFY THE ARCHITECT / ENGINEER AND LANDLORD IMMEDIATELY, IF SAFETY OF STRUCTURE APPEARES TO BE ENDANGERED TAKE PRECAUTIONS TO PROPERLY SUPPORT STRUCTURE. DO NOT RESUME OPERATION UNTIL SAFETY IS RESTORED.
 REMOVE DEMOLISHED MATERIALS, TOOLS AND EQUIOMENTS, ETC. FROM THE SITE UPON COMPLETION OF WORK REMOVE HAZARDOUS MATERIALS AND DIPOSE OF BY SAFE MEANS SO AS NOT TO ENDANGER HEALTH OF WORKERS OR PUBLIC. COMPLY WITH ALL RULES AND REGULATIONS OF GOVERNMENT AUTHORITIES HAVING JURISDICTION OVER HAZARDOUS AND NON-HAZARDOUS DEMOLISHED MATERIALS. ELEVATOR SERVICE COSTS TO BE INCLUDED IN THE CONTRACT PRICE LEAVE SITE IN A CONDITION ACCEPTED TO THE ARCHITECT / OWNER AREA TO BE BROOM CLEAN
 CONTRACTOR SHALL PROVIDE METAL LATH AND PLASTER OVER ALL NEW CONDUIT CHASES IN

MASONRY PARTITIONS

4. ALL EXISTING AREAS TO REMAIN AND EXISTING AREAS AFFECTED BY DEMOLITION OR NEW CONSTRUCTION WORK SHOWN ON DRAWINGS SHALL BE PATCHED AS REQUIRED TO MATCH IMMEDIATE ADJACENT AREAS IN CONSTRUCTION, MATERIALS, FIRE RATING, FINISH AND COLOR, UNLESS OTHERWISE NOTED.

5 CONTRACTOR SHALL CAP AND FLUSH OFF ALL PROJECTING PLUMBING, FLOOR ELECTRICAL AND TELEPHONE OUTLET AND OTHER PROJECTING ITEMS BEING ABANDONED BEHIND FINISH SURFACES, PATCHING SURFACES TO MATCH ADJACENT AREAS

6. AFTER DEMOLITION AND PRIOR TO ANY FABRICATION OR INSTALLATION, CONTRACTOR SHALL

PROVIDE LEVEL (BENCH) MARKS ON ALL COLUMNS (OR ABOUT 25' APART), THESE MARKS SHALL BE ESTABLISHED OFF THE HIGHEST POINT OF FLOOR FINISH SURFACE AND SHALL BE USED BY ALL TRADES FOR THEIR INSTALLATION

DURING DEMOLITION AND CONSTRUCTION, EXISTING FIRE AND SMOKE DETECTION SYSTEMS WITHIN

PROJECT AREAS ARE TO BE REMAIN OPERATION

27'-2"


DEMO. ROOF PLAN
SCALE: 1/4"=1'-0"


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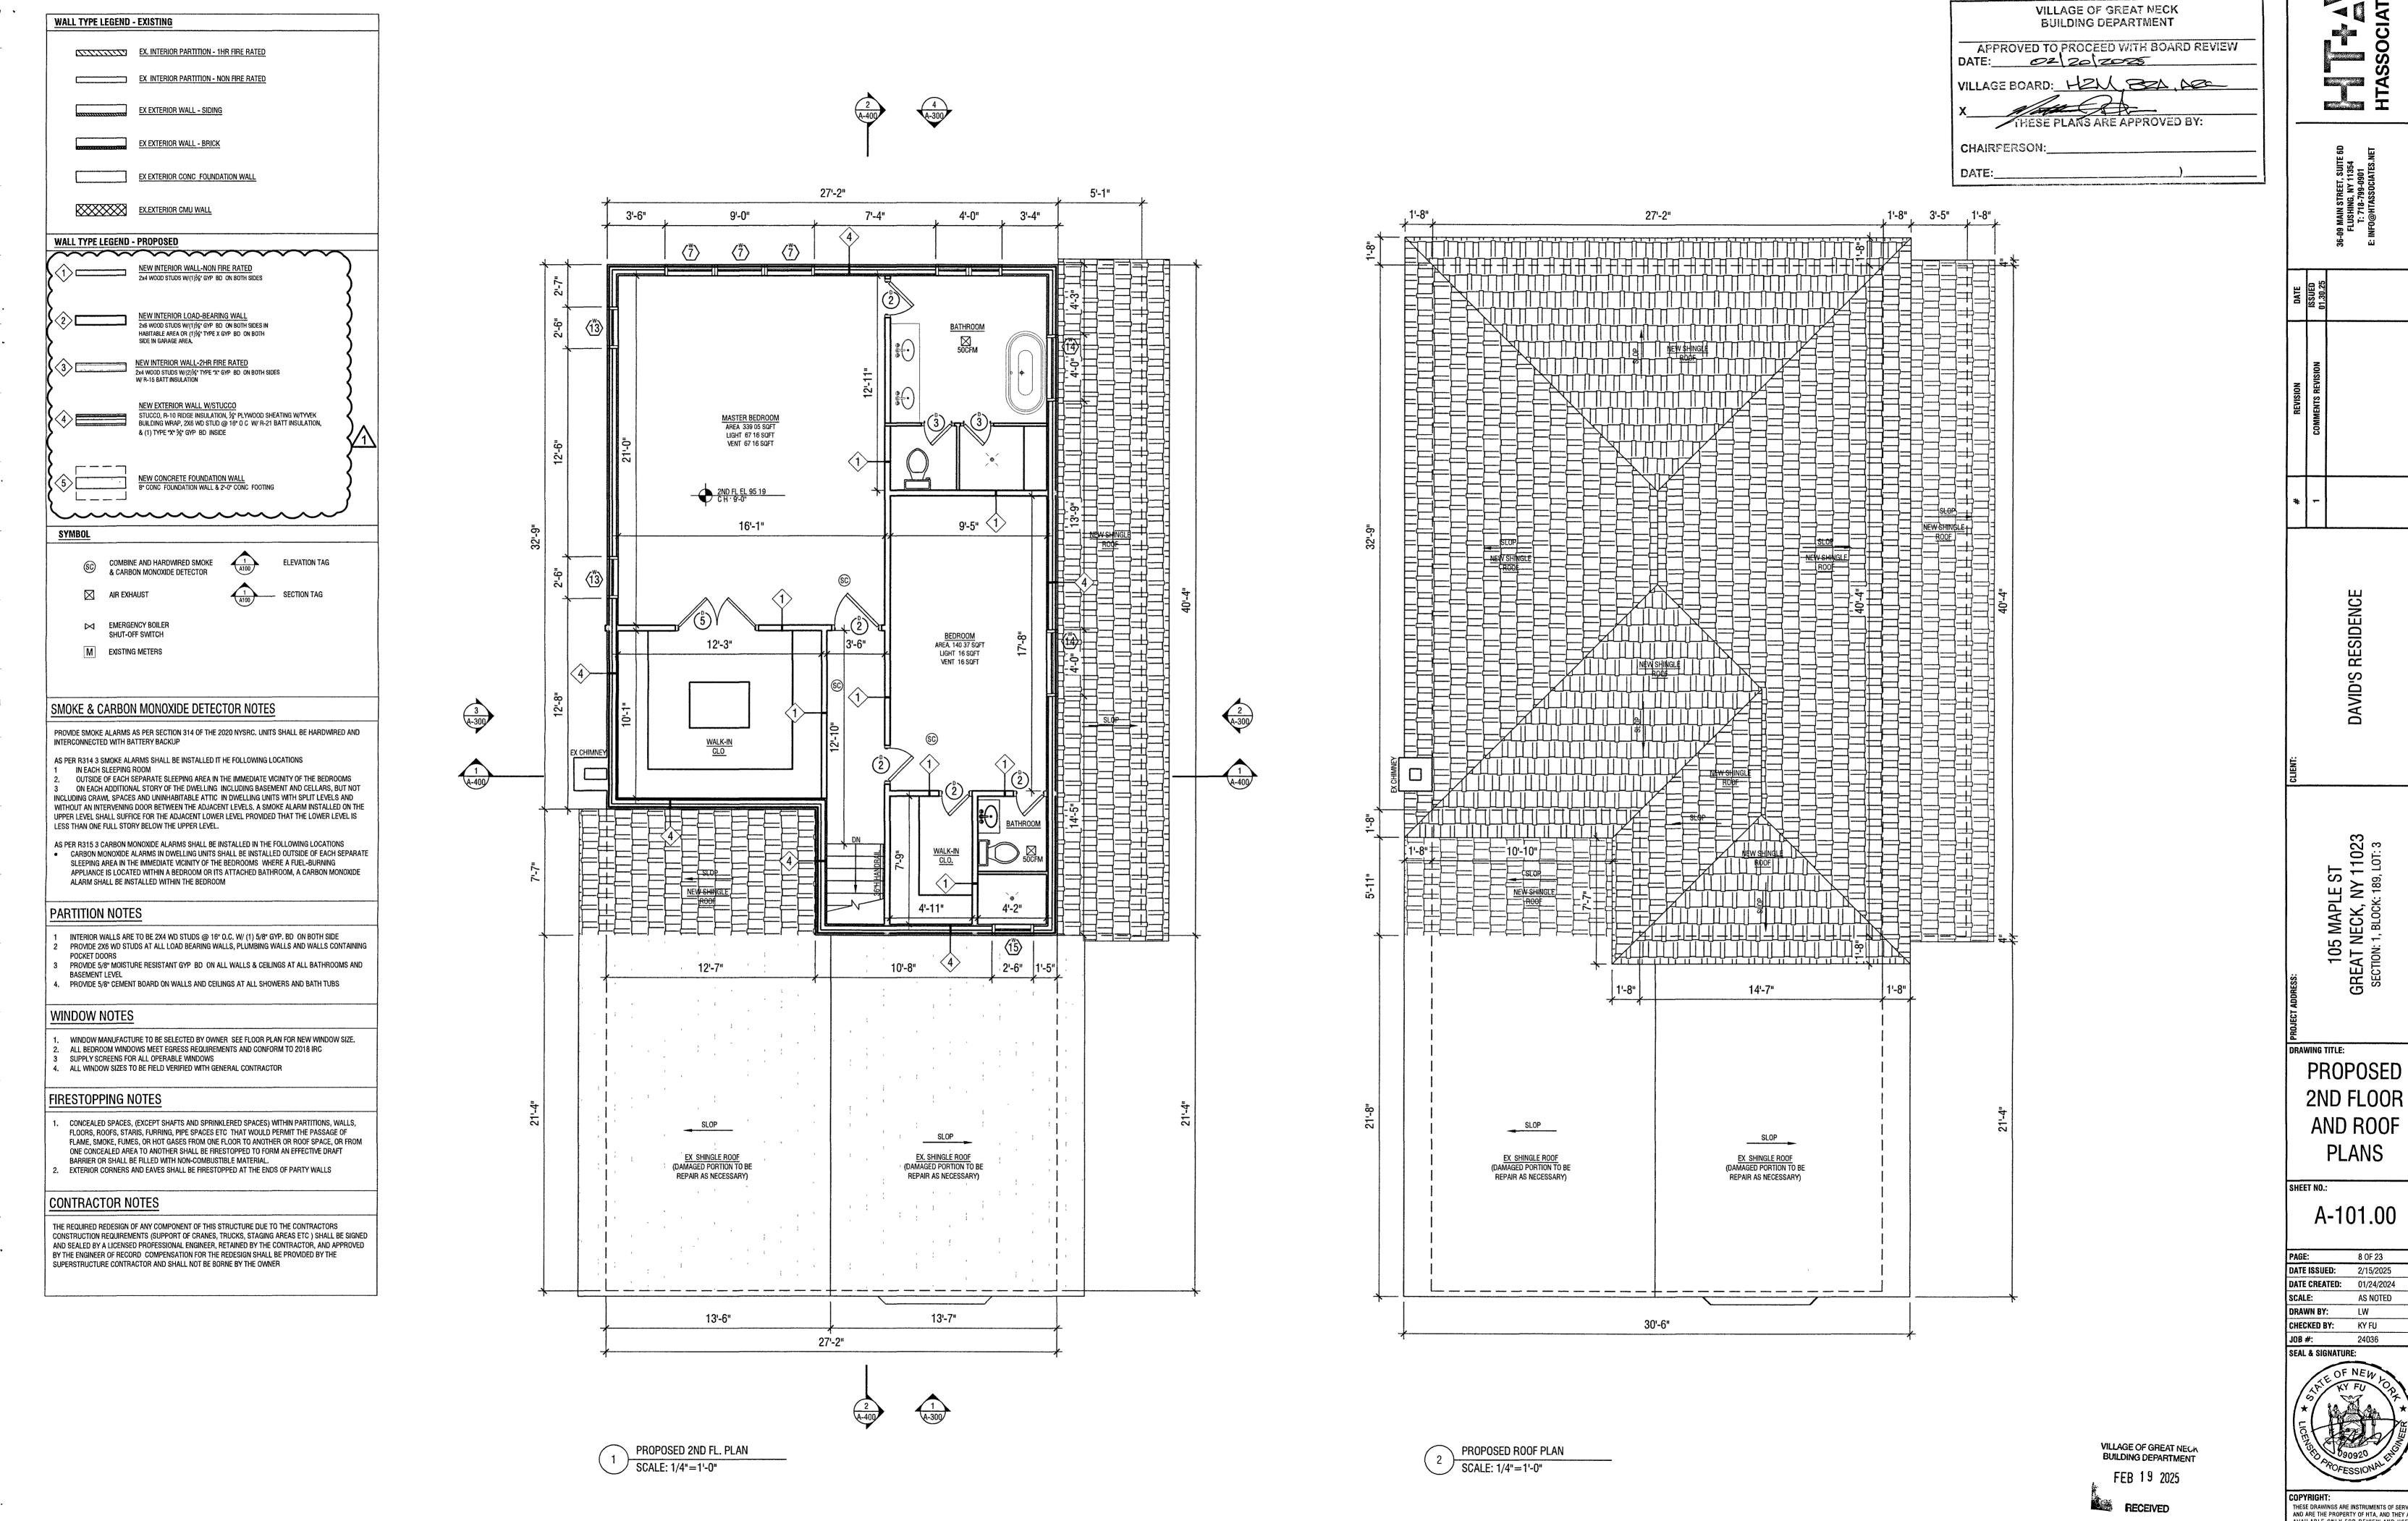
ROOF PLAN DM-102.00 5 OF 23 **DATE ISSUED:** 2/15/2025 DATE CREATED: 01/24/2024 SCALE: AS NOTED DRAWN BY: LW CHECKED BY: KY FU 24036 SEAL & SIGNATURE:

VILLAGE OF GREAT NECK BUILDING DEPARTMENT FEB 19 2025

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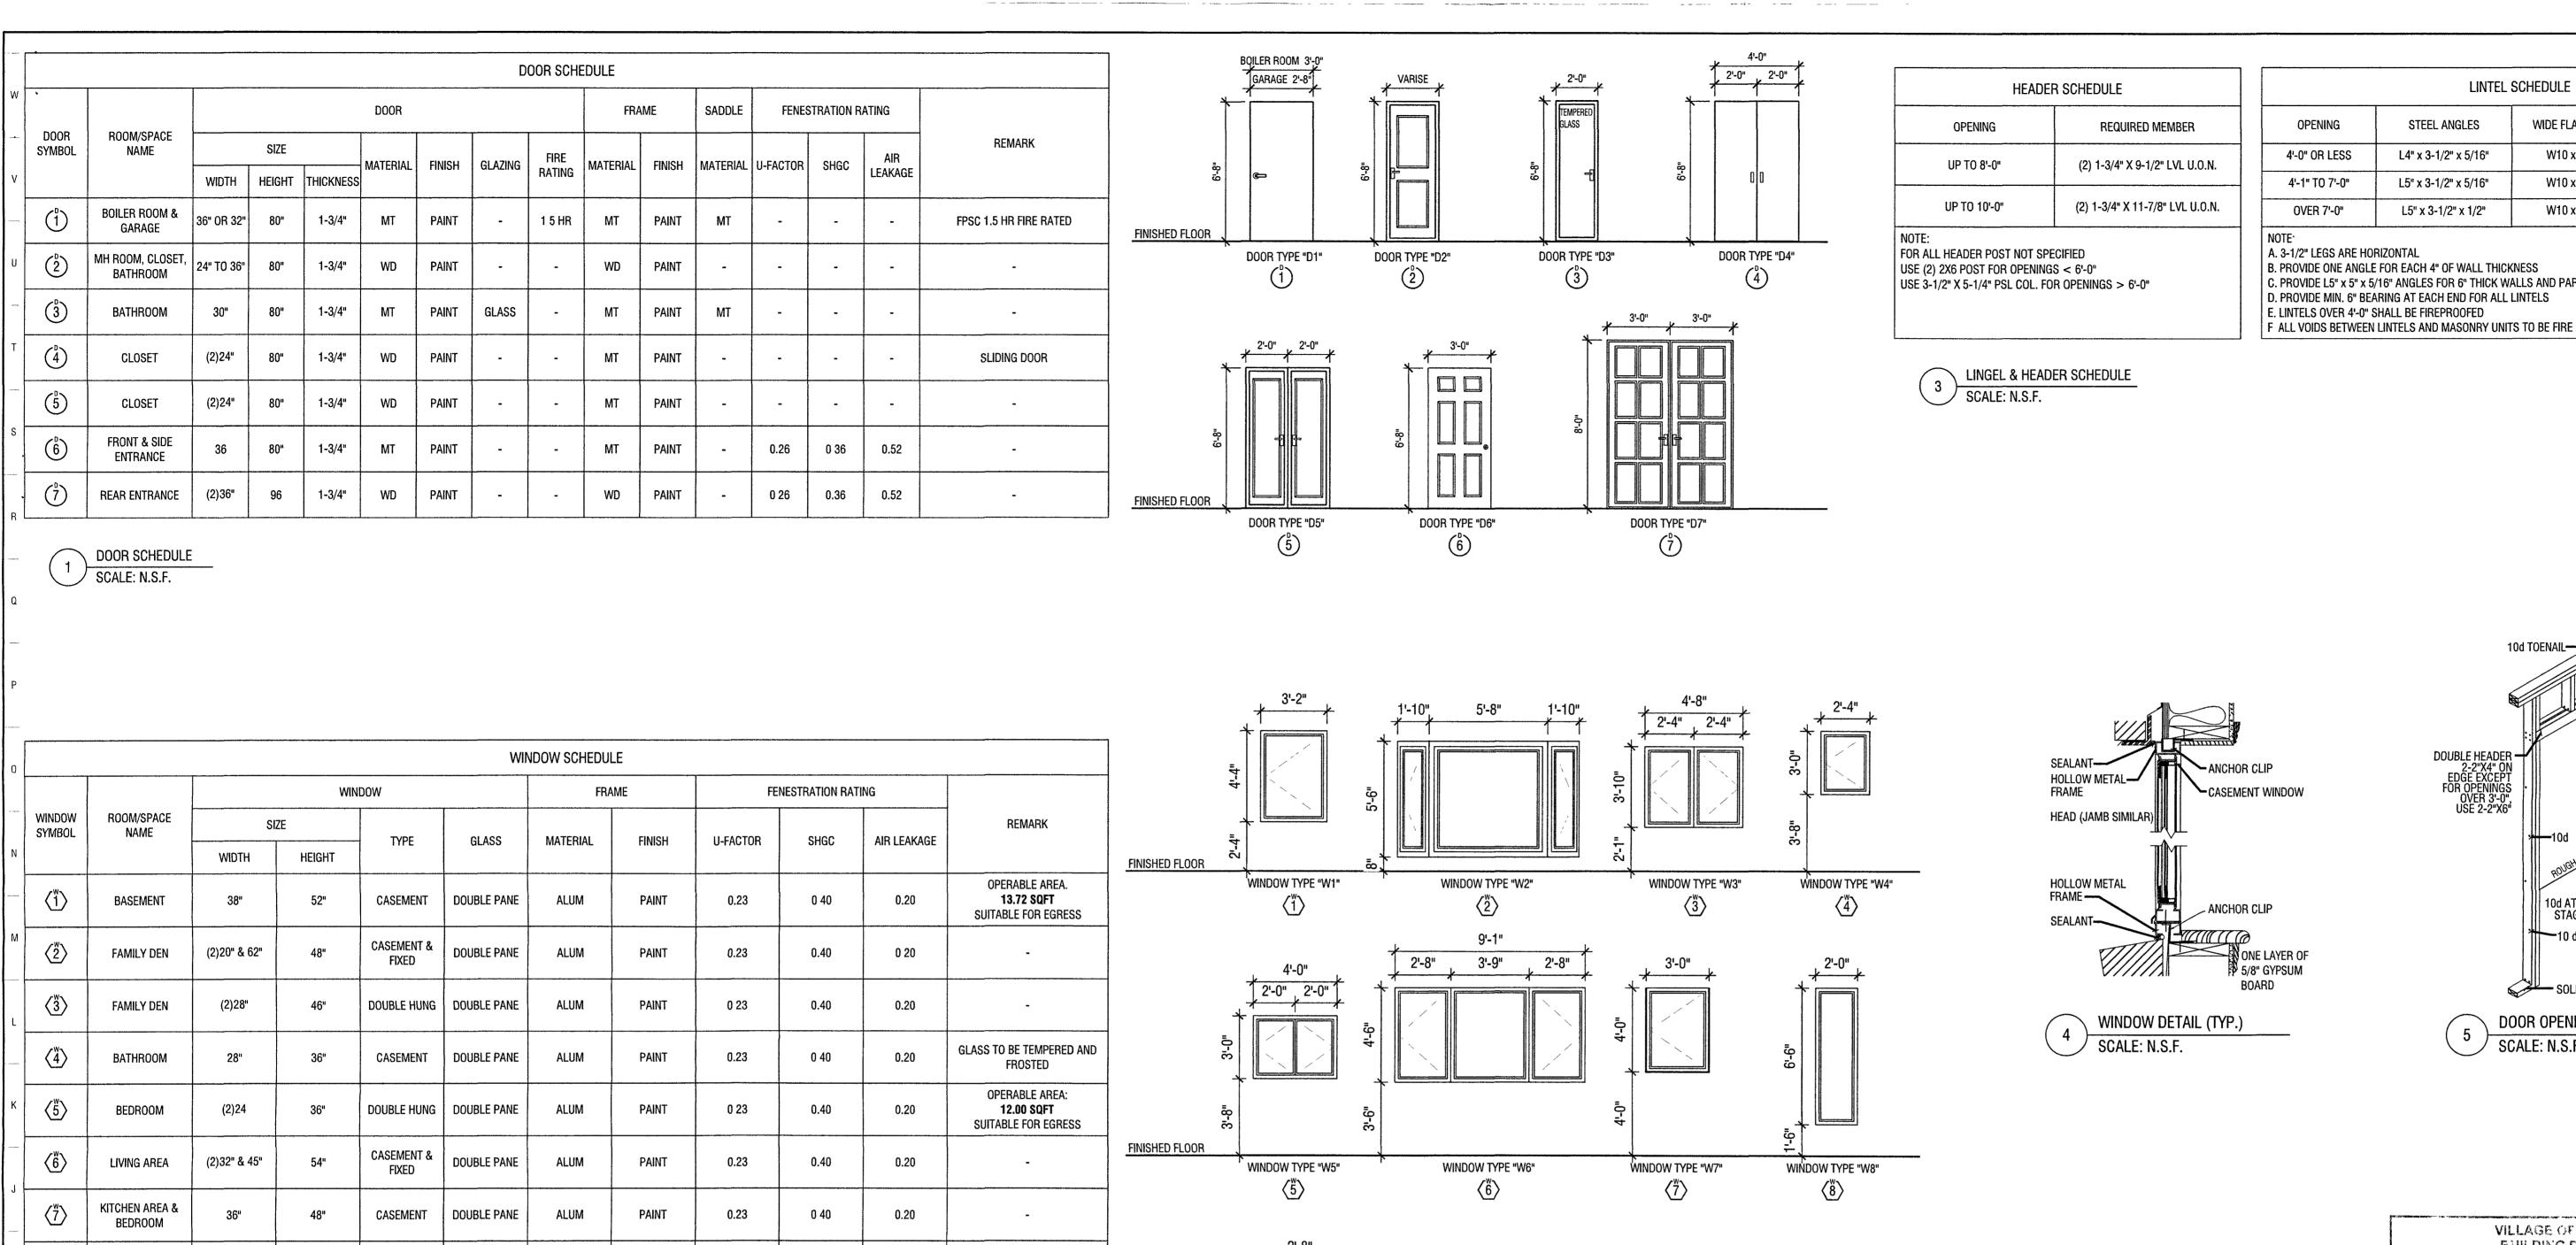


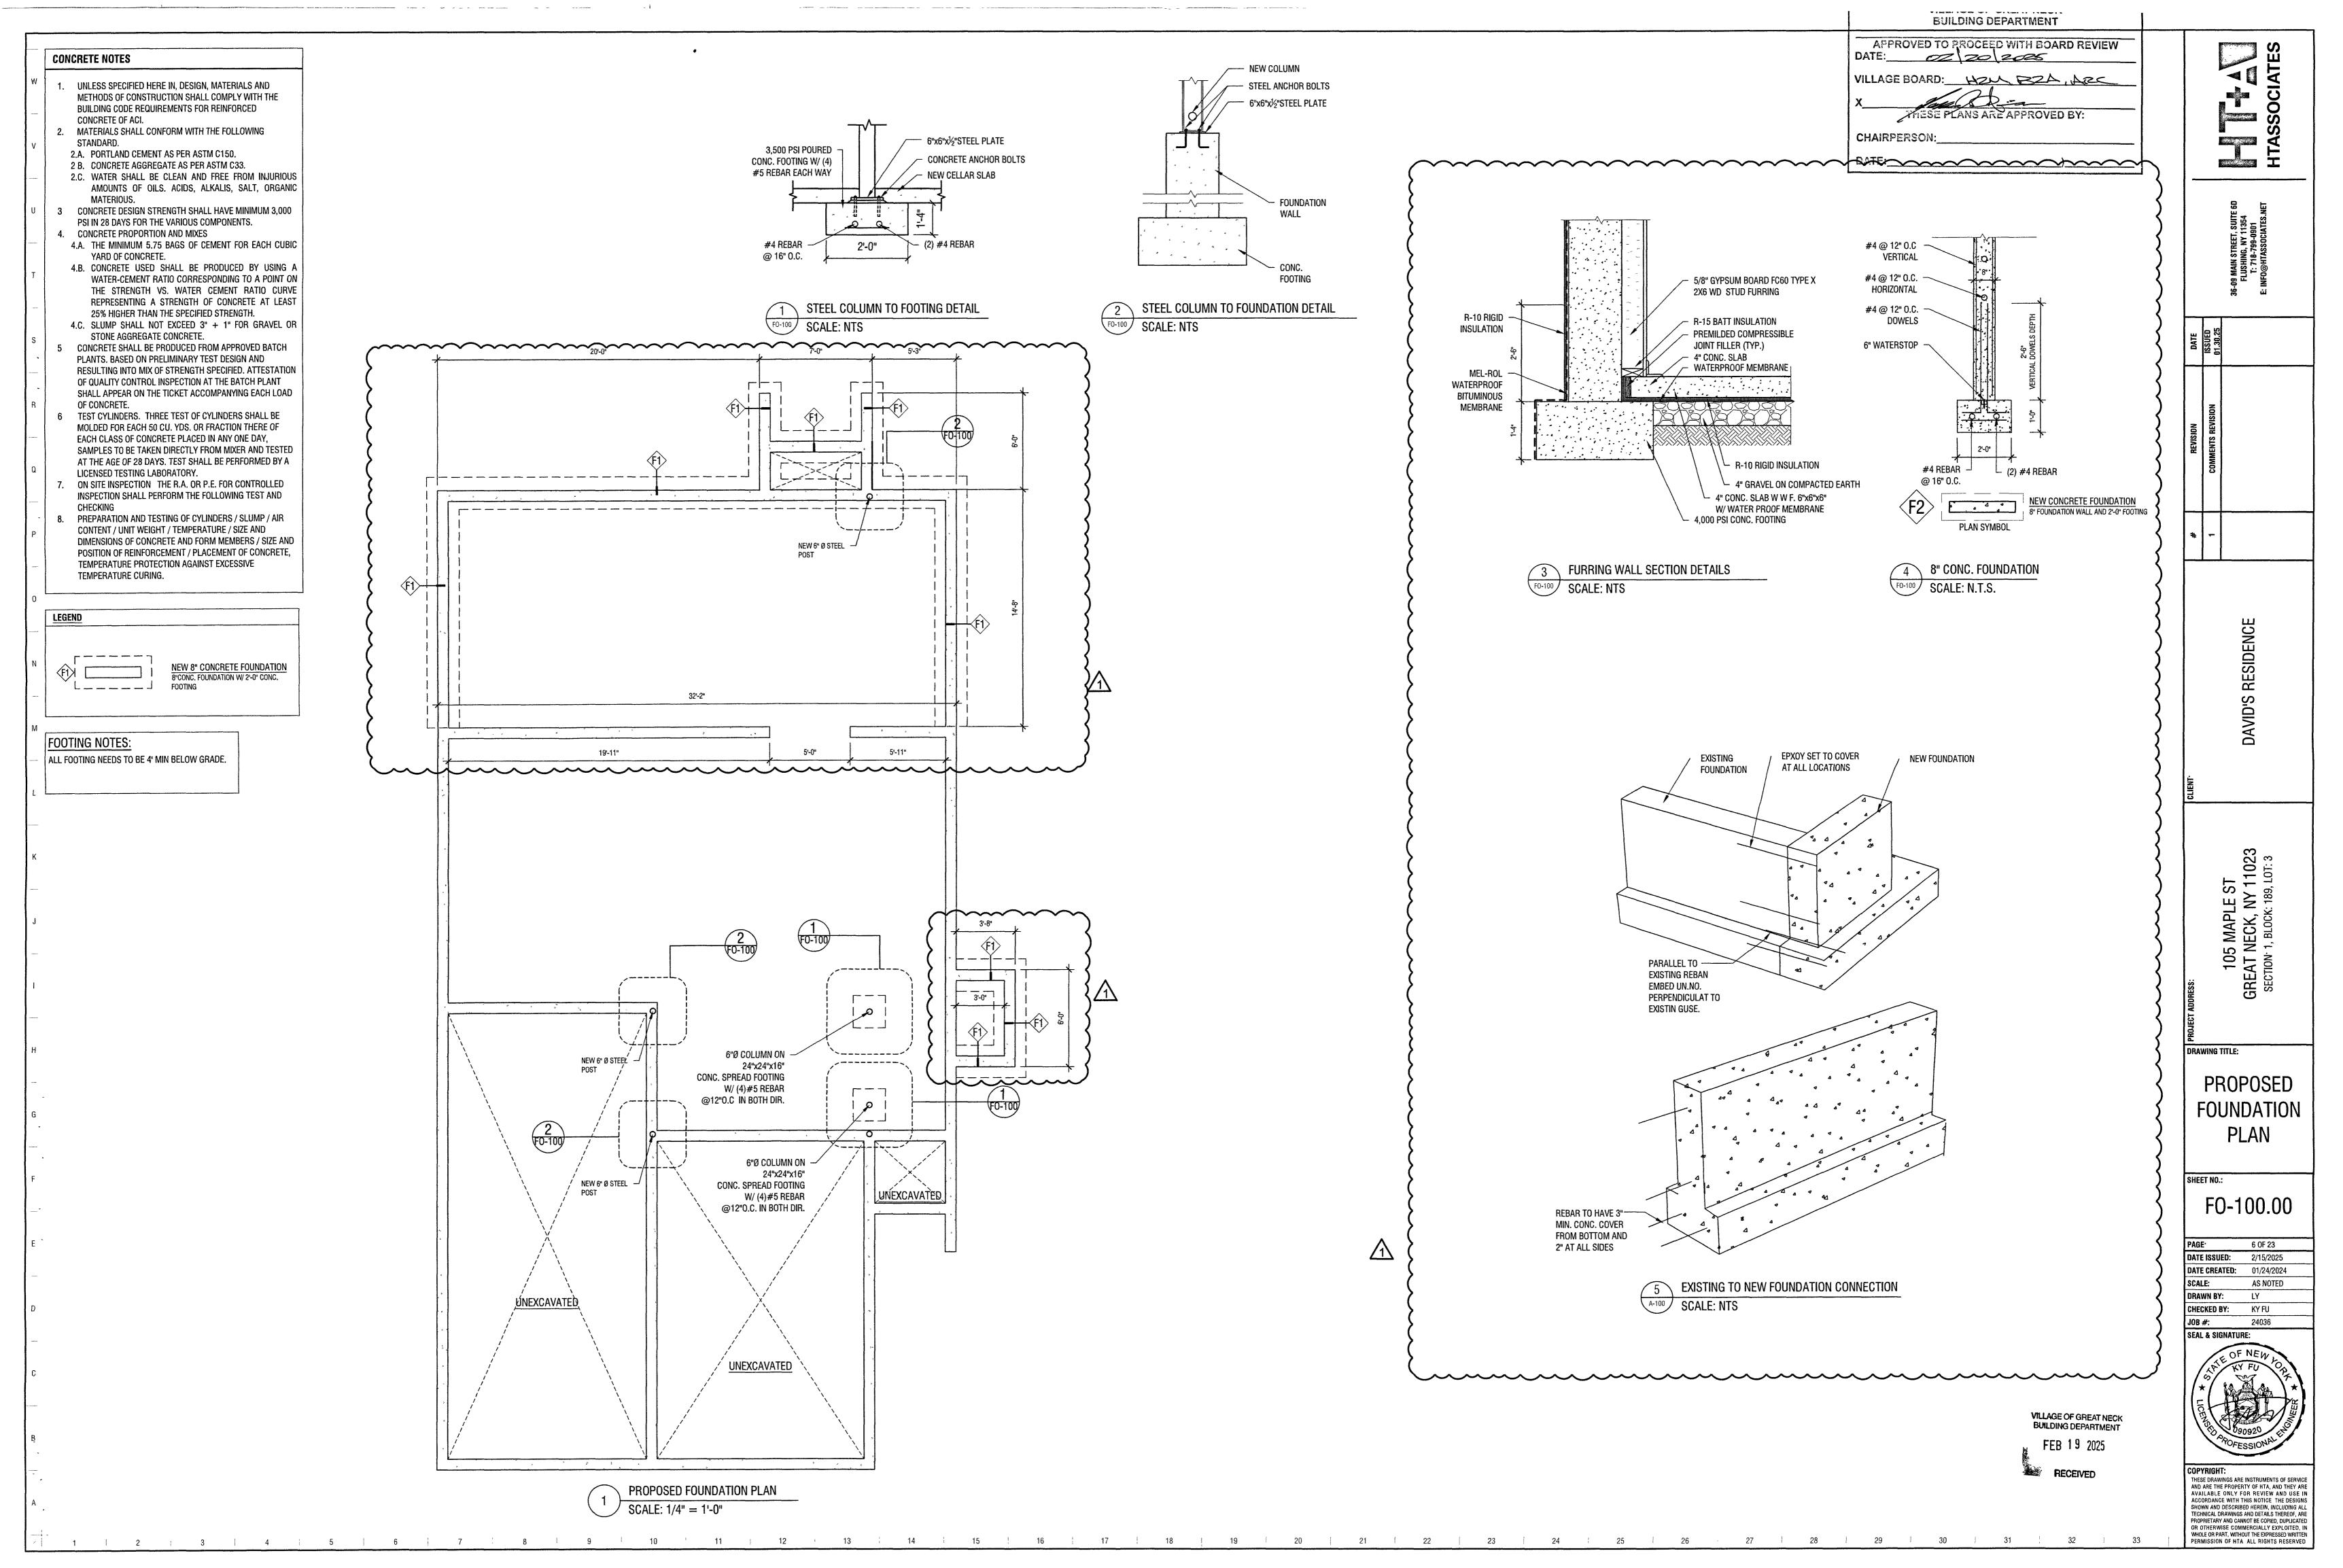

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GLASS TO BE TEMPERED AND
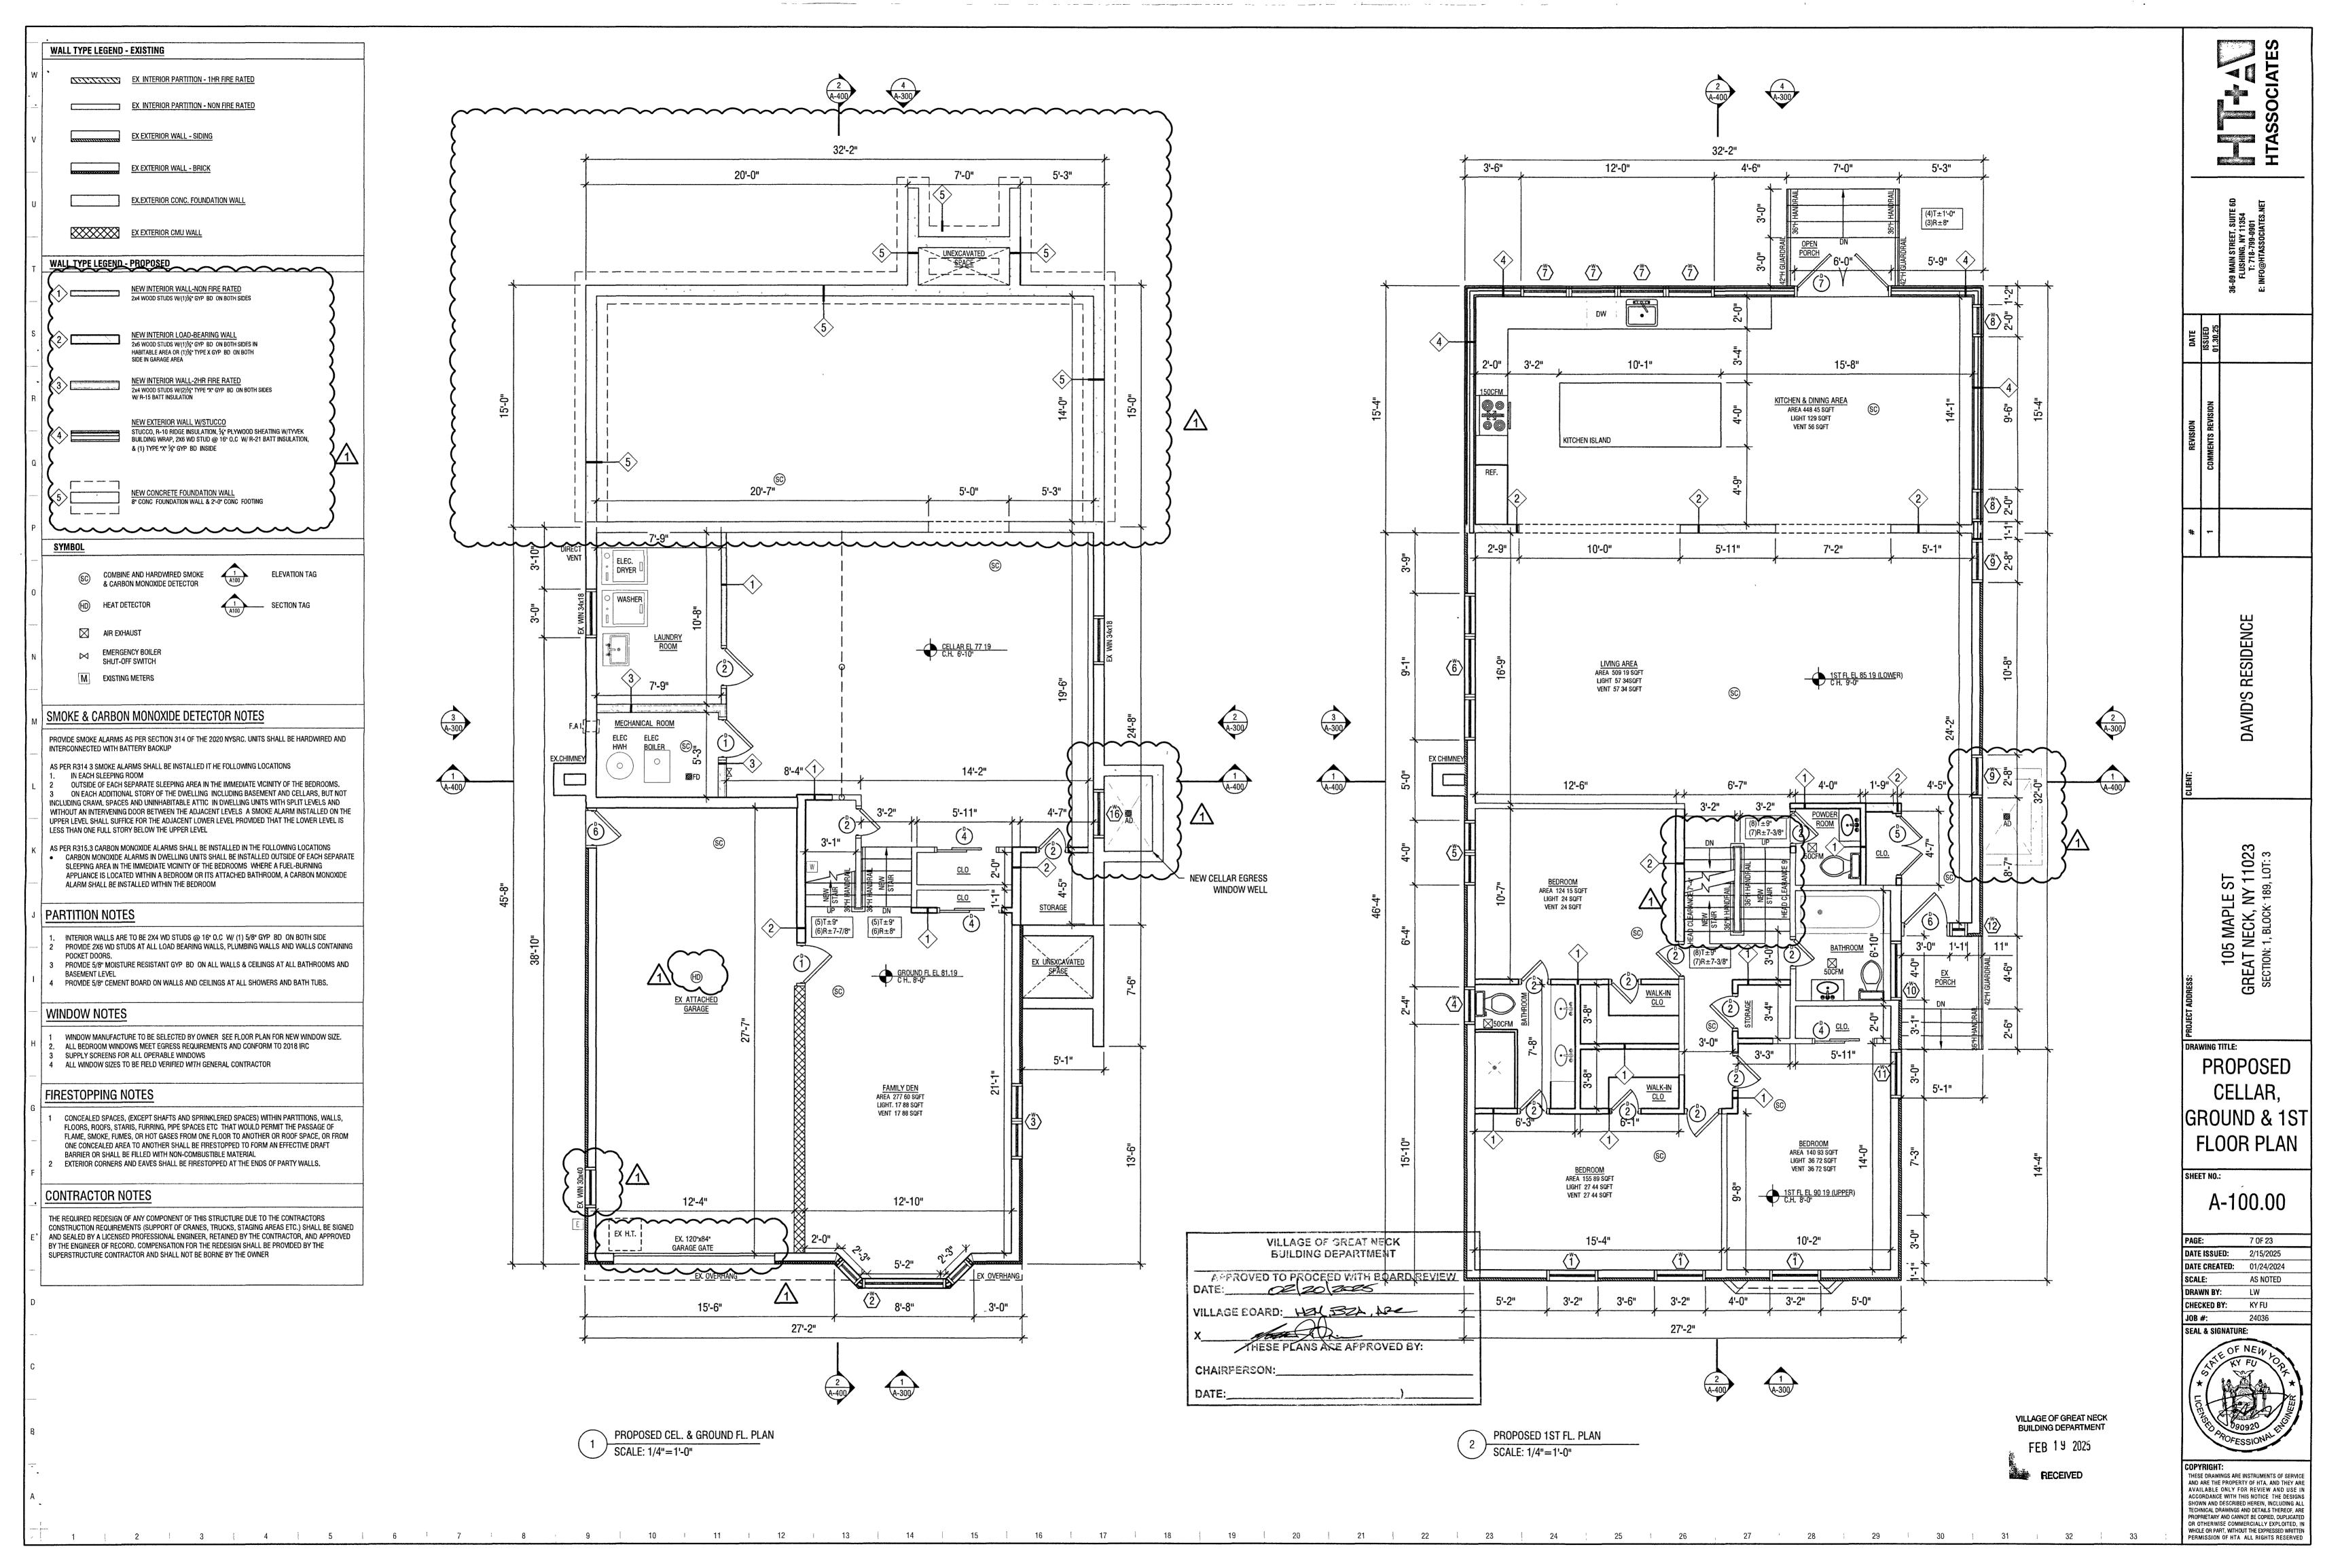
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EGRESS WINDOW

FINISHED FLOOR

WINDOW TYPE "W9"

WINDOW TYPE "W13"

 $\left\langle \overset{\text{w}}{13}\right\rangle$

WINDOW TYPE "W10"

WINDOW TYPE "W14"

 $\langle 14 \rangle$

1 | 2 | 3 | 4 | 5 | 6 | 7 | 8 | 9 | 10 | 11 | 12 | 13 | 14 | 15 | 16 | 17 | 18 | 19 | 20 | 21 | 22 | 23 | 24 | 25 | 26 | 27 | 28 | 29 | 30 | 31 | 32 | 33

WINDOW TYPE "W11"

 $\langle 11 \rangle$

WINDOW TYPE "W15"

(15)

WINDOW TYPE "W12"

 $\langle 1^{\text{W}}_{2} \rangle$

WINDOW TYPE "W16"

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24"

32"

44"

36"

24"

30"

(2)24"

24"

36"

DINING AREA

LIVING AREA

BATHROOM

BEDROOM

PORCH

BEDROOM

BEDROOM

CELLAR

WINDOW SCHEDULE

2 SCALE: N.S.F.

 $\left\langle 1^{\text{W}}_{3}\right\rangle$

 $\langle 1^{\text{W}}_{4} \rangle$

78"

48"

22"

46"

78"

48"

48"

FIXED

CASEMENT

AWNING

CASEMENT

FIXED

CASEMENT

CASEMENT

CASEMENT

CASEMENT

DOUBLE PANE

DOUBLE PANE

ALUM

ALUM

ALUM

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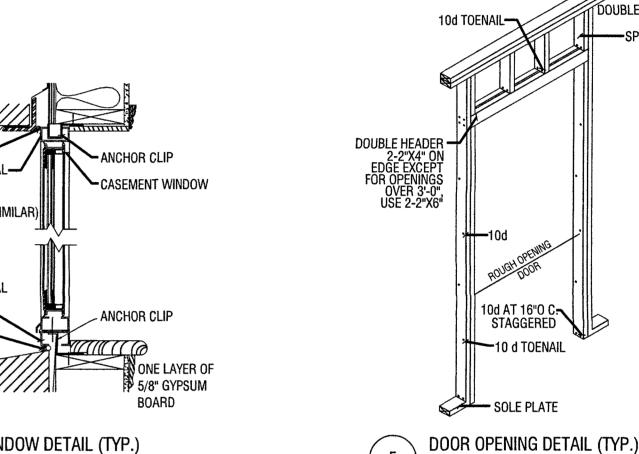
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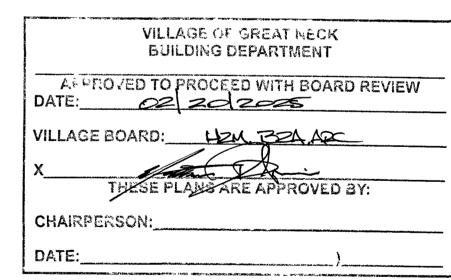
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LINTEL SCHEDULE								
OPENING	STEEL ANGLES	WIDE FLANGE BEAM	REMARKS					
4'-0" OR LESS	L4" x 3-1/2" x 5/16"	W10 x 15 MIN.	DOUBLE LINTELS FOR MASONRY WALLS WITH					
4'-1" TO 7'-0"	L5" x 3-1/2" x 5/16"	W10 x 17 MIN.	FACE BRICK AND					
OVER 7'-0"	L5" x 3-1/2" x 1/2"	W10 x 19 MIN.	BACK-UP CONCRETE BLOCK WALLS					

B. PROVIDE ONE ANGLE FOR EACH 4" OF WALL THICKNESS C. PROVIDE L5" x 5" x 5/16" ANGLES FOR 6" THICK WALLS AND PARTITIONS D. PROVIDE MIN. 6" BEARING AT EACH END FOR ALL LINTELS F ALL VOIDS BETWEEN LINTELS AND MASONRY UNITS TO BE FIRE PROOF GOUT FILLED





VILLAGE OF GREAT NECK BUILDING DEPARTMENT FEB 19 2025 RECEIVED

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DRAWN BY:

CHECKED BY:

DAVID'S

105 MAPLE ST GREAT NECK, NY 11023 SECTION: 1, BLOCK: 189, LOT: 3

DOOR AND

WINDOW

SCHEDULE

A-200.00

DATE ISSUED: 2/15/2025


DATE CREATED: 01/24/2024

9 OF 23

AS NOTED

LW

DRAWING TITLE:

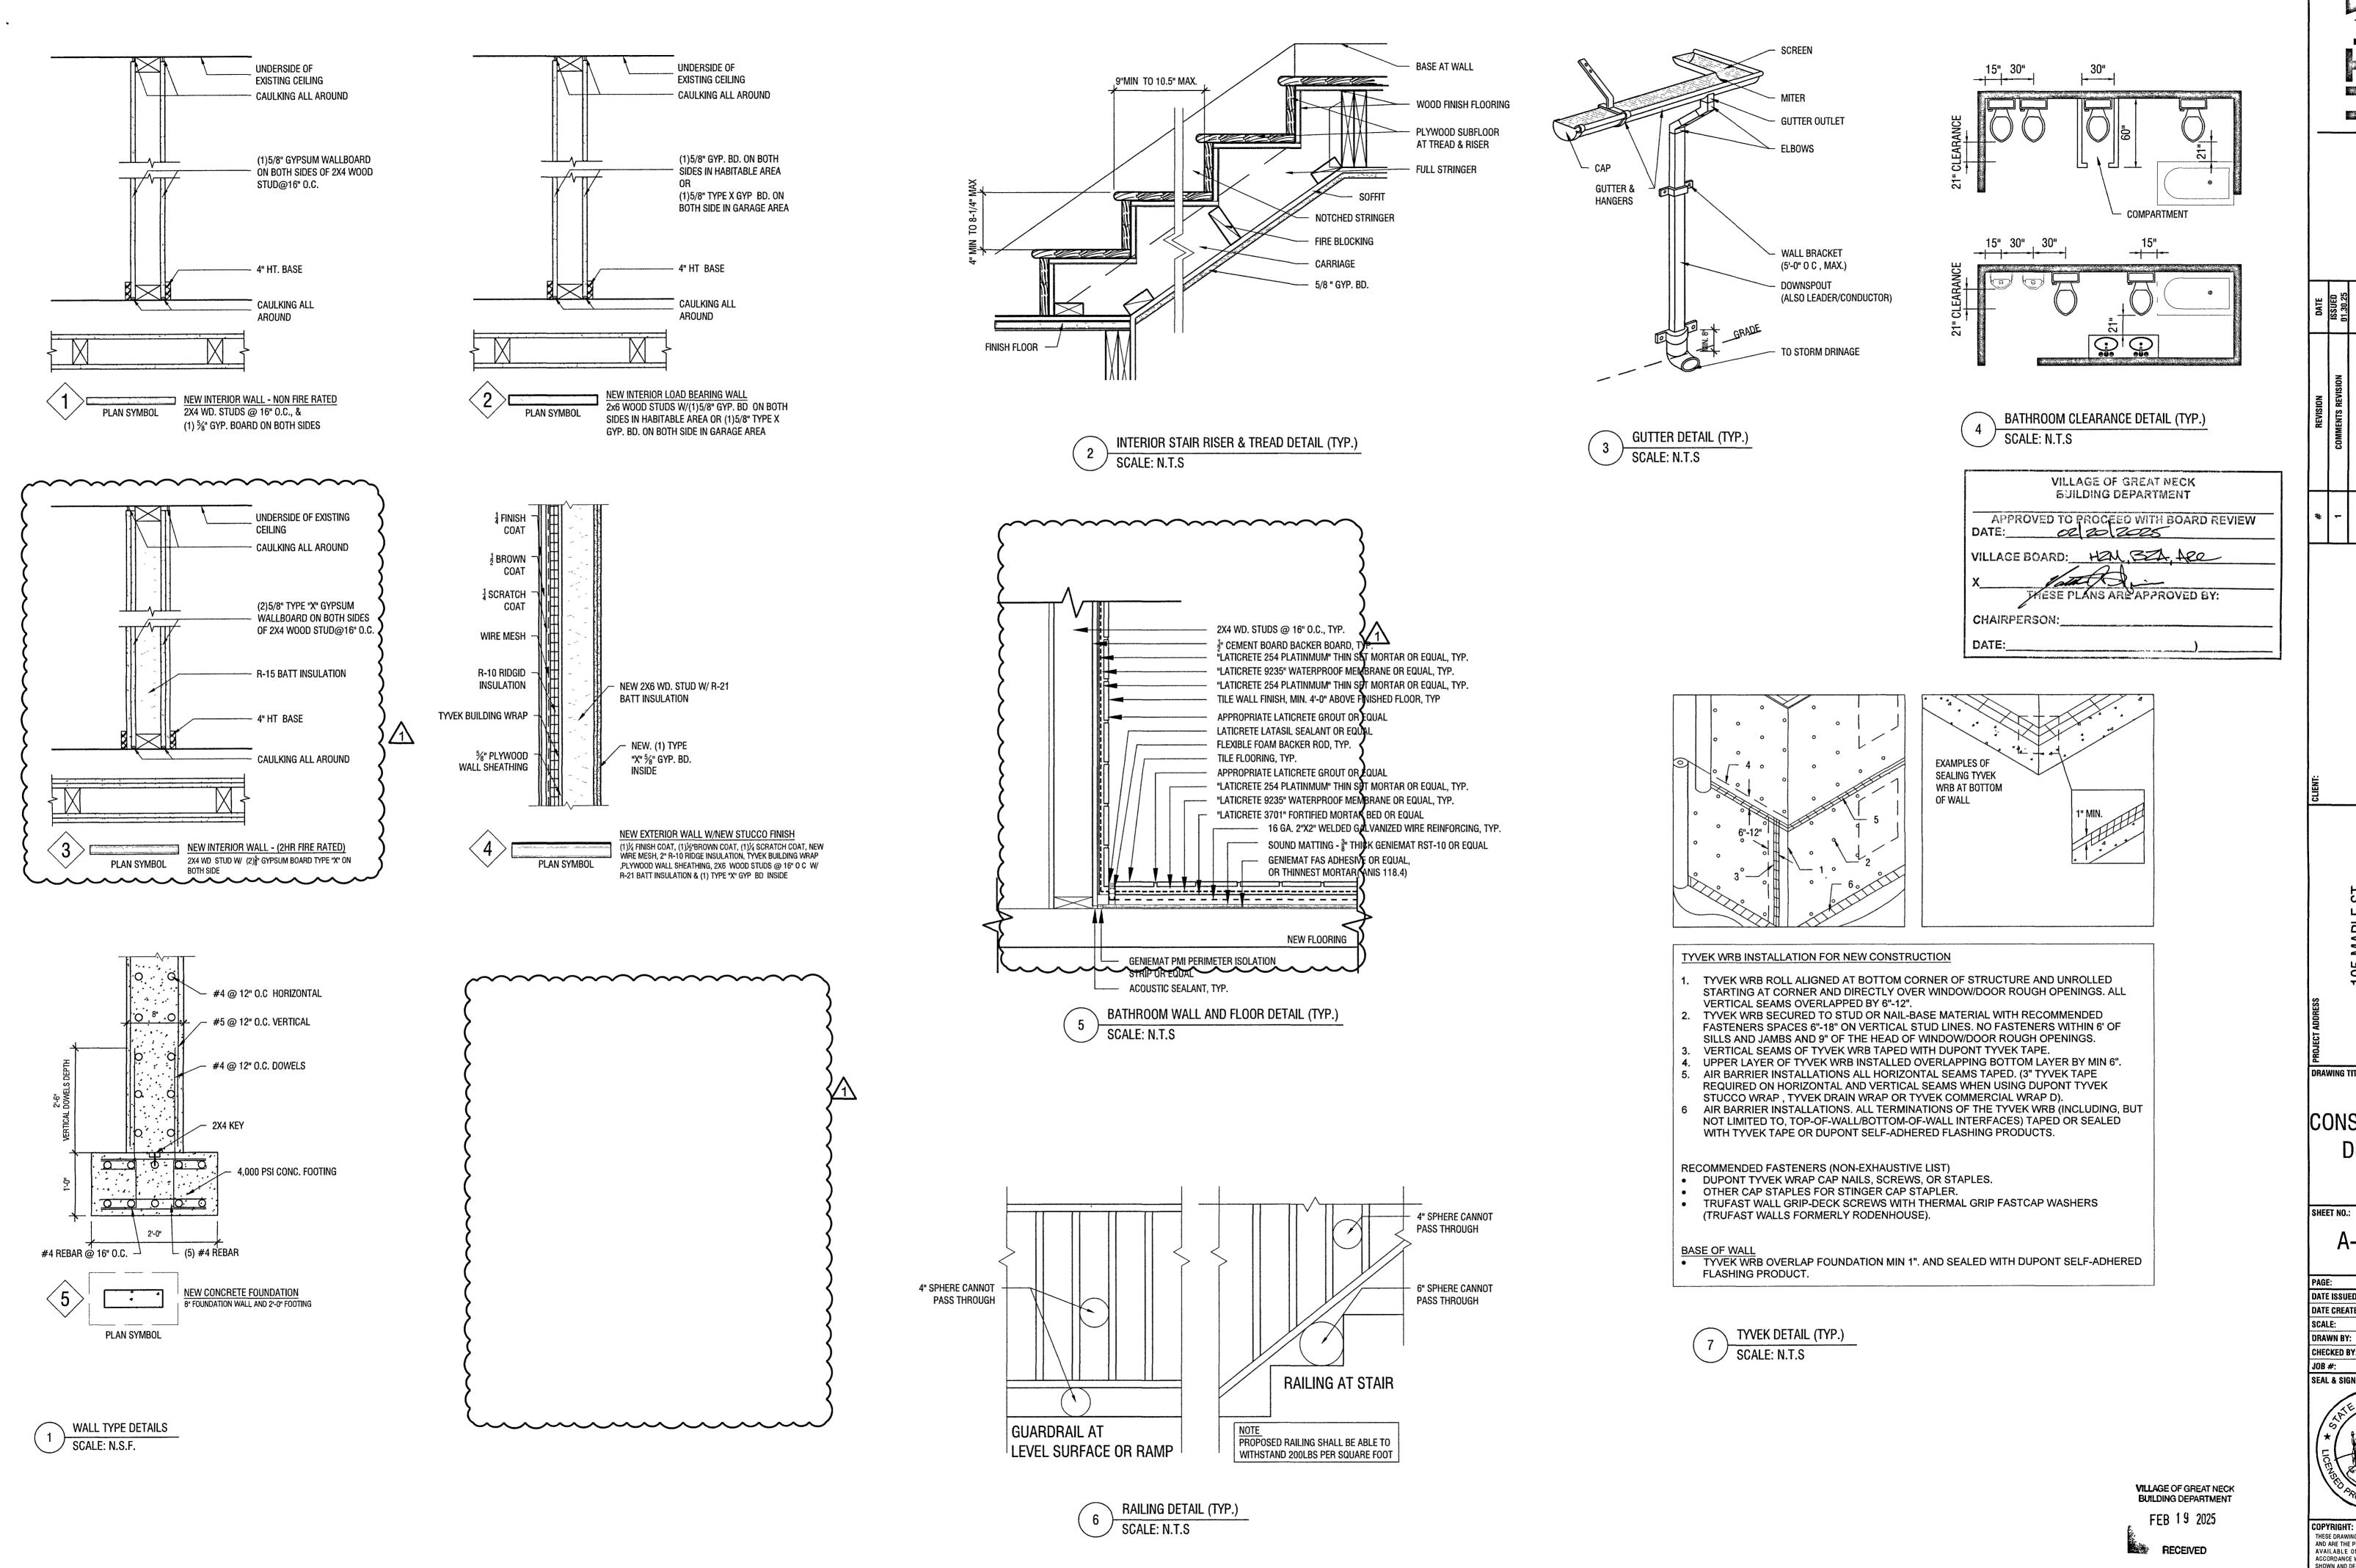

1 2 3 4 5 6 7 8 9 10 11 12 13 14 15 22 23 24 25 26 27 28 29 30 131 32 133

HTASSOCIATE

COSHING, NT 11334
T: 718-799-0901
O@HTASSOCIATES.NET

36-09 MAI FLUSI FLUSI F: 7 E: INFO@

REVISION

1 COMMENTS REVISION

DAVID'S RESIDENCE

105 MAPLE ST GREAT NECK, NY 11023 SECTION: 1, BLOCK: 189, LOT. 3

5

DRAWING TITLE:

CONSTRUCTION DETAILS

A-201.00

PAGE: 10 OF 23

DATE ISSUED: 2/15/2025

DATE CREATED: 01/24/2024

SCALE: AS NOTED

 DATE CREATED:
 01/24/202

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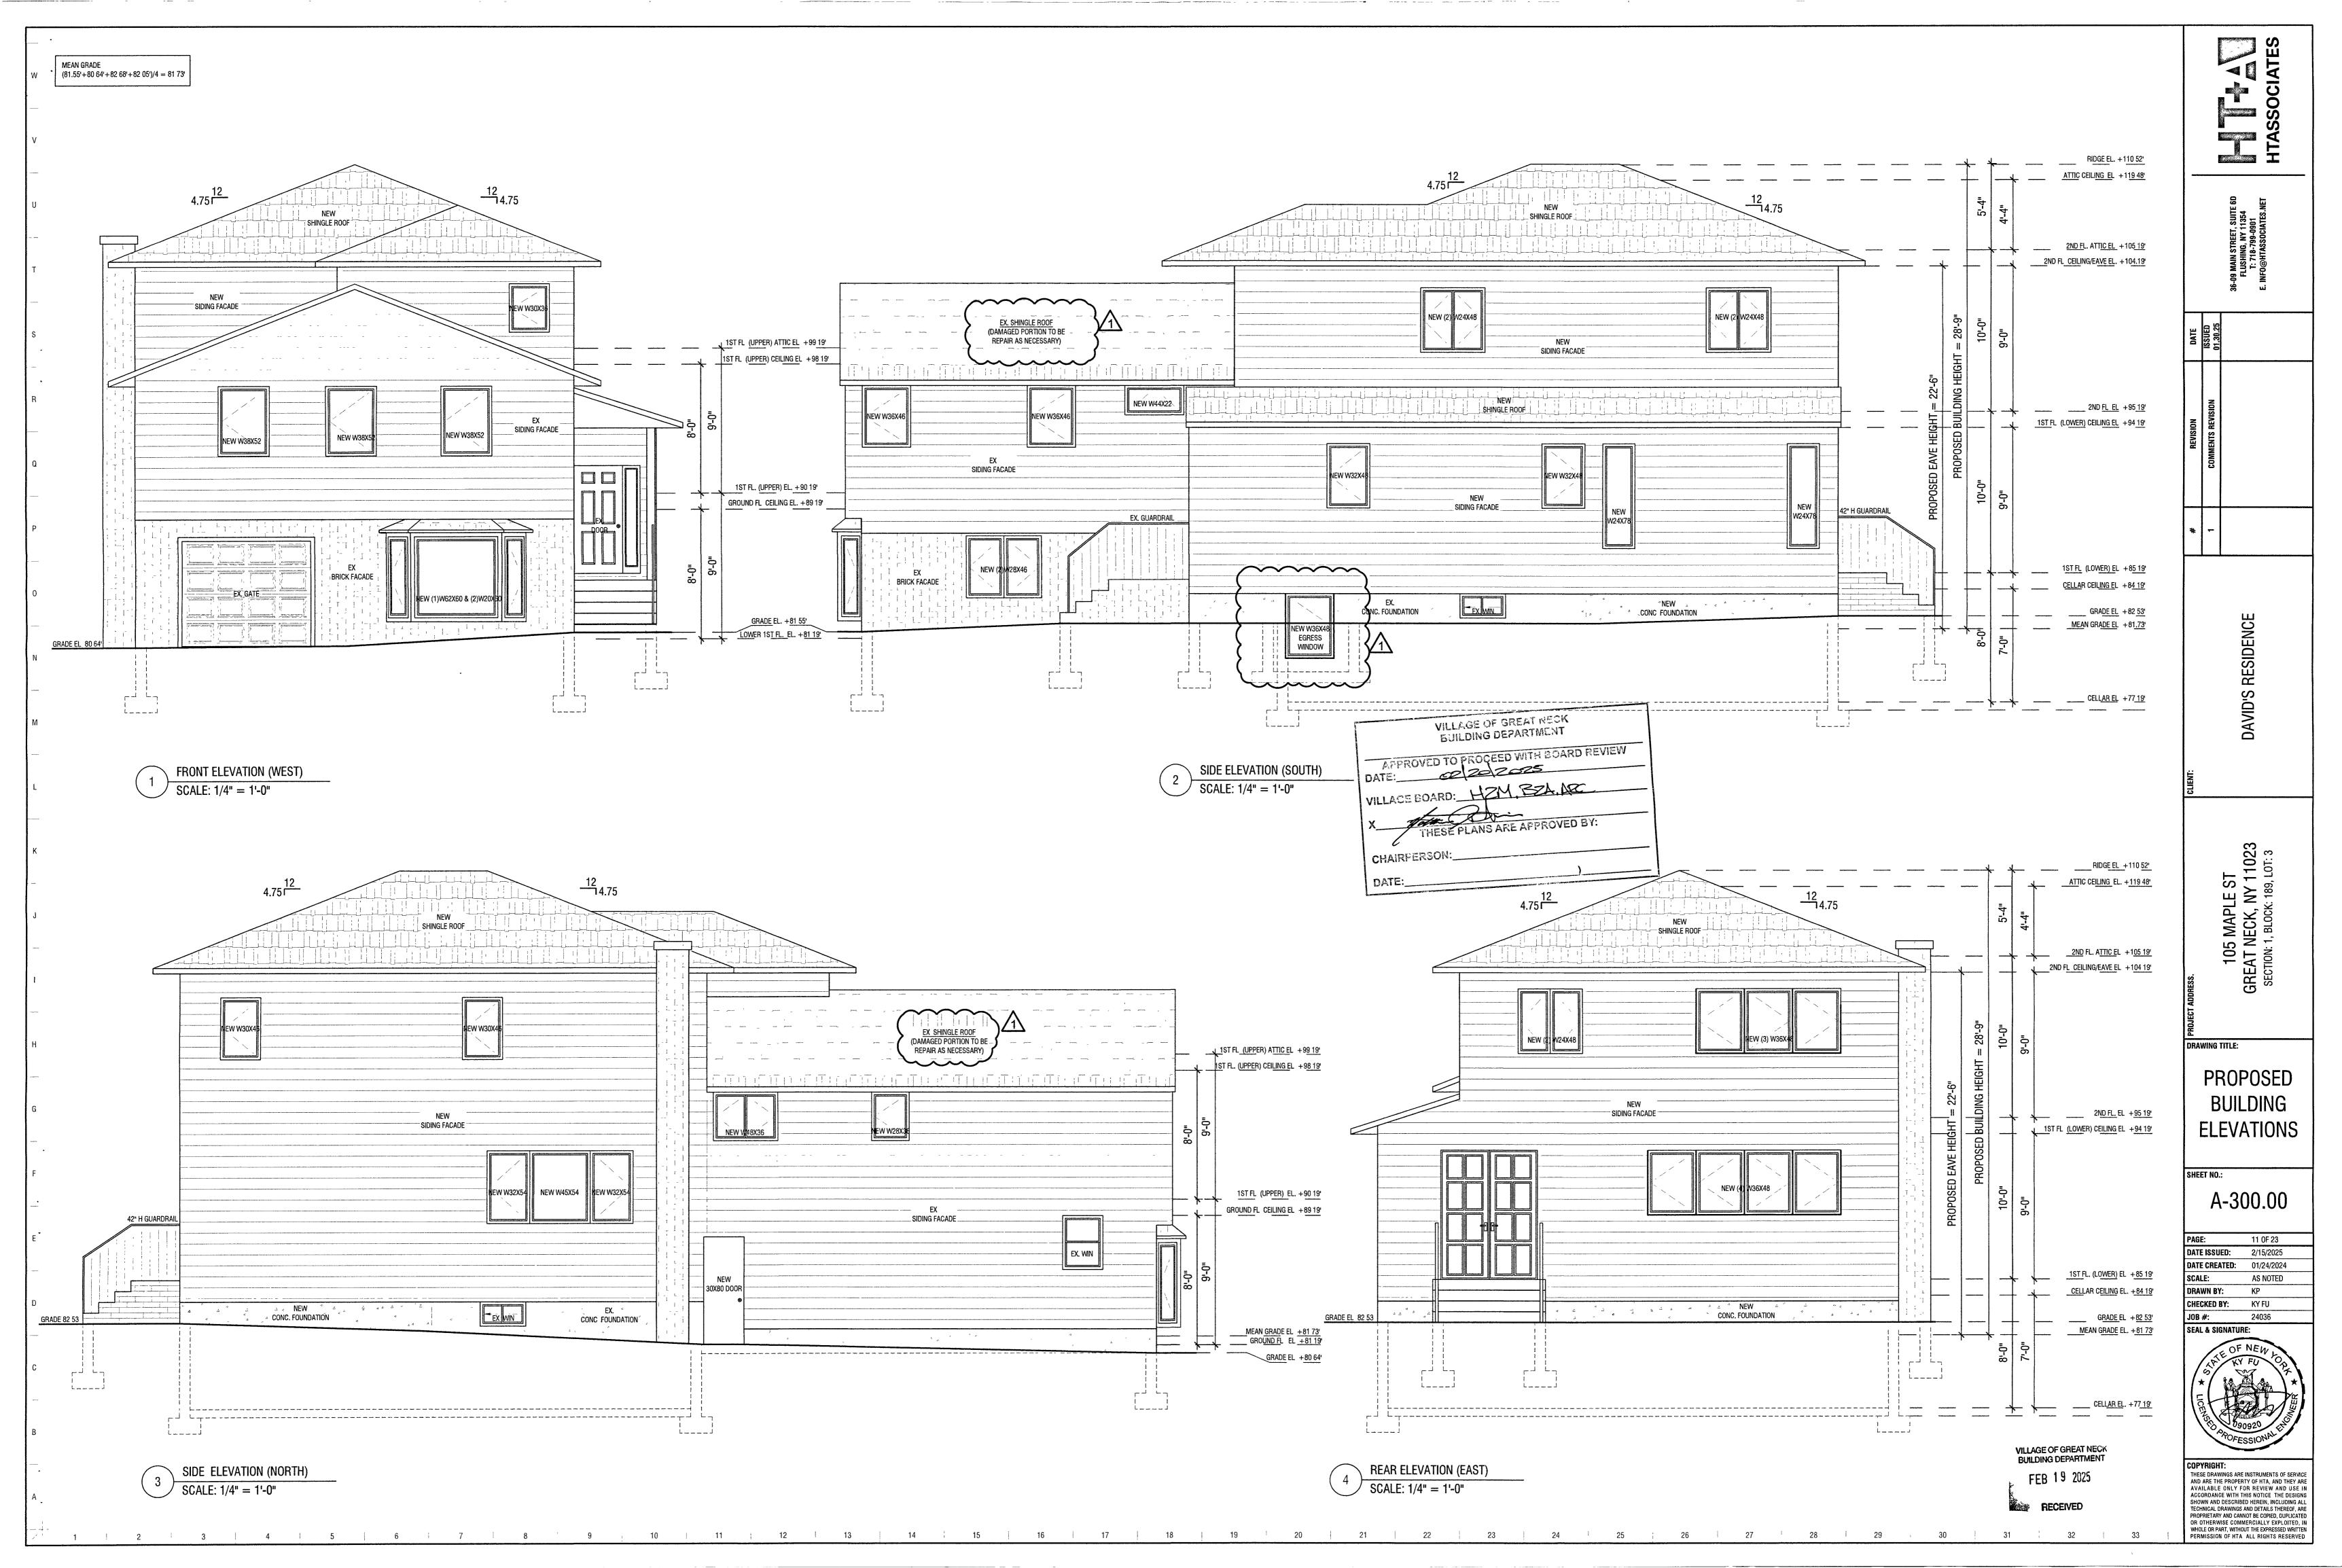
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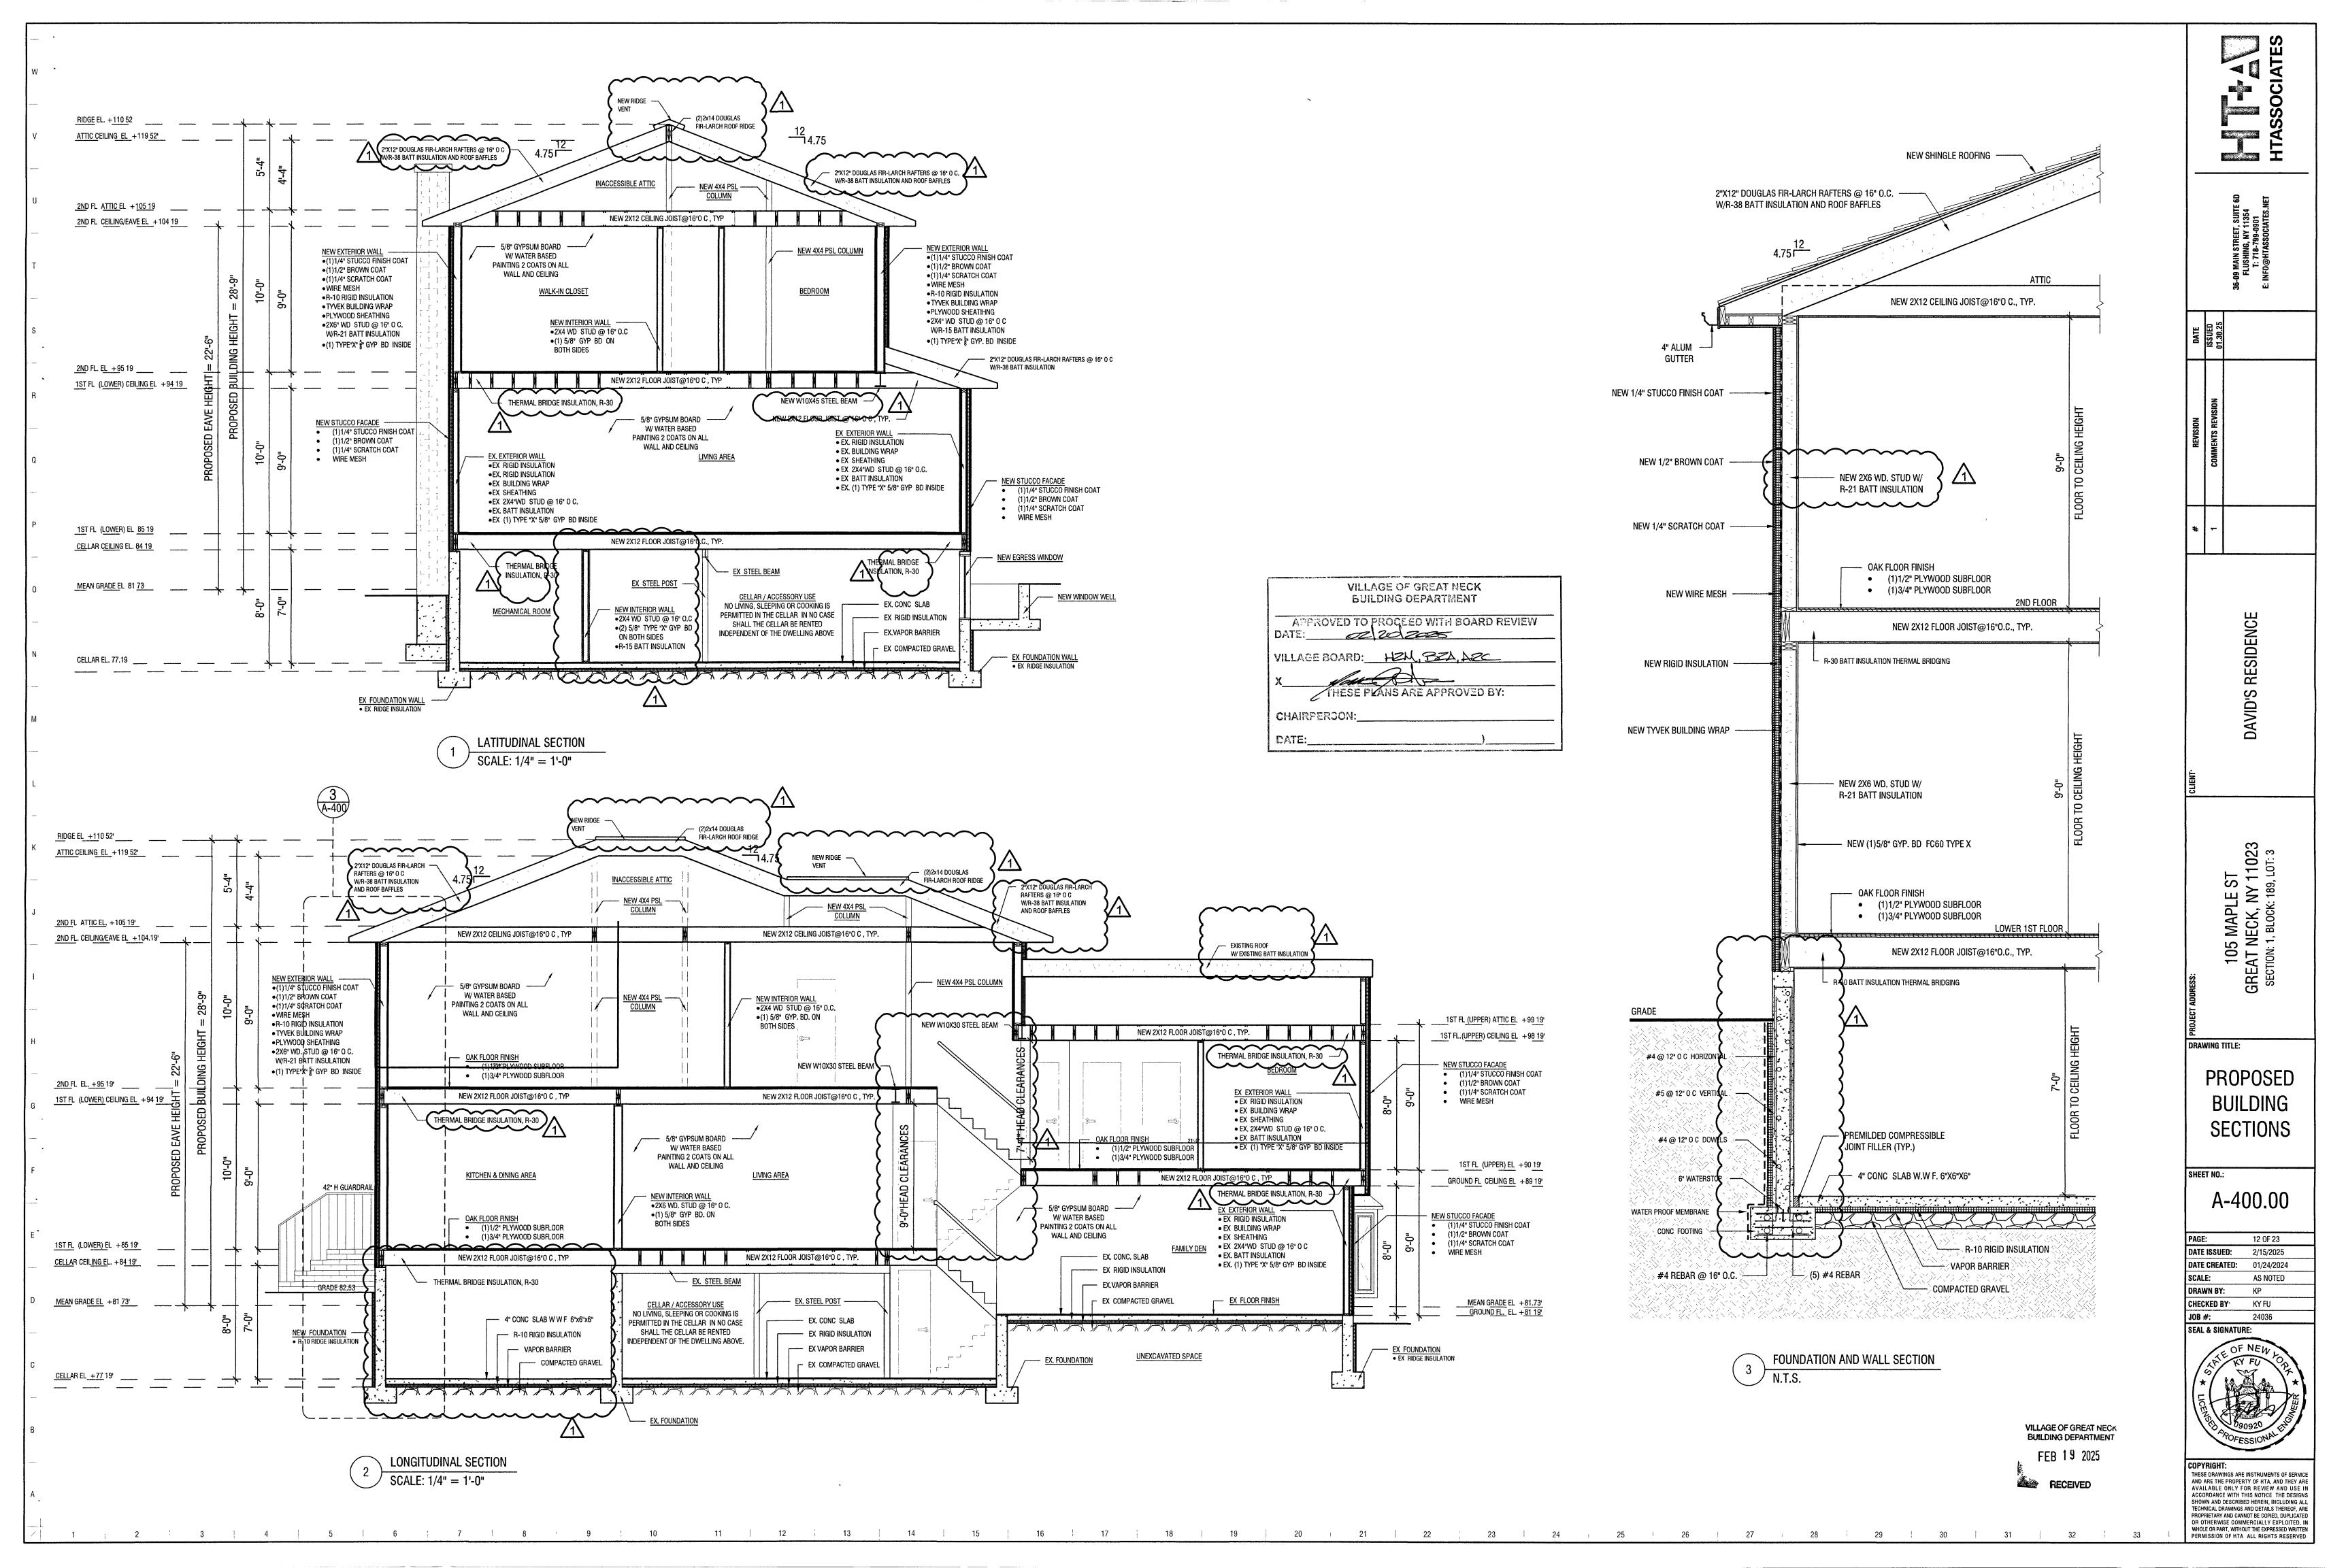
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- 1	•				· · · · · · · · · · · · · · · · · · ·								_
	LEGEND						LIGHTING	G FIXTURE	SCHEDU	LE			
,		LED GIMBAL DOWNLIGHTING MODULE	TYPE	MOUNT	BULB TYPE	LAMP	INPUT WATTAGE	LUMEN	QUANTITY	TOTAL WATTAGE	EFFICACY	VOLTAGE	
		LED WALL MOUNT EXTERIOR LIGHT	0	CEILING MOUNT DOWNLIGHT	LITHONIA LIGHTING, 4 INCH LED BULB	LED	10 5W	810	9	94 5	85 00%	120	
	\$1	SINGLE POLE SWITHCH	0	CEILING MOUNT DOWNLIGHT	LITHONIA LIGHTING, 4 INCH LED BULB	LED	10 5W	810	3	31 5	85 0%	120	
	\$2	THREE-WAY POLE SWITCH	0	CEILING MOUNT DOWNLIGHT	LITHONIA LIGHTING, 4 INCH LED BULB	LED	10 5W	810	21	220 5	85 0%	120	
	\$4	FOUR-WAY POLE SWITCH	0	CEILING MOUNT DOWNLIGHT	LITHONIA LIGHTING, 4 INCH LED BULB	LED	10.5W	810	10	1050	85.0%	120	
		WIRING CONCEALED IN WALL/CEILING		LED WALL MOUNT EXTERIOR LIGHT	KICHLER LIGHTING, G4 BI-PIN LED BULB	LED	20W	810	4	80 0	85 0%	120	
	•	ELECTRIC OUTLET	······································										
	₹	ELECTRIC OUTLET(GFCI)											

ELECTRICAL NOTES

- 1 ALL ELECTRICAL WORK SHALL CONFORM TO THE REQUIREMENTS OF THE 2018 NATIONAL ELECTRICAL CODE(NFPA70) AND THE 2018 INTERNATIONAL RESIDENTIAL CODES.
- ALL WORK TO BE PERFORMED BY A LICENSED ELECTRICIAN 3 PROVIDE GROUND-FAULT AND ARC-FAULT CIRCUIT INTERRUPTER PROTECTIONS IN ACCORDANCE
- W/ SECTION E3902 OF THE 2015 IRC 4. GENERAL USE RECEPTACLE PLACEMENT SHALL BE IN ACCORDANCE W/ SECTION 3901 2 OF THE
- 2018 IRC> NO POINT MEASURED HORIZONTALLY ALONG THE WALL SHALL BE MORE THAN 6" FROM A RECEPTACLE, 2' FOR KITCHEN COUNTERTOP RECEPTACLES.
- PROVIDE AT LEAST ONE WALL SWITCH CONTROLLED LIGHTING FIXTURE ON THE EXTERIOR SIDE OF EACH EGRESS DOOR IN ACCORDANCE WITH SECTION E393 3 OF THE 2018 IRC.
- 6. 100% OF ALL LAMPS IN PERMANENTLY INSTALLED FIXTURES MUST BE HIGH EFFICIENCY
- ELECTRICAL CONTRACTOR TO PROVIDE 400 AMP SERVICE TO HOSE. 8 ALL INSTALLATIONS MUST BE GROUNDED.
- 9 ALL RECESSED LIGHT FIXTURES TO BE TYPE IC RATED
- 10 ALL EXTERIOR USE FIXTURES & RECEPTACLES TO BE WEATHERPROOF 11 ELECTRICIAN IS RESPONSIBLE FOR ALL ELECTRICAL INSPECTIONS AND FOR PROVIDING UL
- CERTIFICATE UPON COMPLETION 12. LIGHTING & ELECTRICAL OUTLET PLAN IS A PRELIMINARY LAYOUT. FINAL SELECTION AND LOCATION OF ALL ELECTRICAL LIGHT FIXTURES TO BE BY OWNER G C & ELECTRICAL CONTRACTOR TO CONFIRM THE EXACT LOCATION AND MOUNTING OF THE LIGHTING FIXTURES PRIOR TO

SMOKE & CARBON MONOXIDE DETECTOR NOTES

- PROVIDE SMOKE ALARMS AS PER SECTION 314 OF THE 2018 IRC UNITS SHALL BE HARDWIRED AND INTERCONNECTED WITH BATTERY BACKUP.
- AS PER R314 3 SMOKE ALARMS SHALL BE INSTALLED IT HE FOLLOWING LOCATIONS IN EACH SLEEPING ROOM.
- OUTSIDE OF EACH SEPARATE SLEEPING AREA IN THE IMMEDIATE VICINITY OF THE BEDROOMS ON EACH ADDITIONAL STORY OF THE DWELLING. INCLUDING BASEMENT AND CELLARS, BUT NOT INCLUDING CRAWL SPACES AND UNINHABITABLE ATTIC IN DWELLING UNITS WITH SPLIT LEVELS AND WITHOUT AN INTERVENING DOOR BETWEEN THE ADJACENT LEVELS A SMOKE ALARM INSTALLED ON THE UPPER LEVEL SHALL SUFFICE FOR THE ADJACENT LOWER LEVEL PROVIDED THAT THE LOWER LEVEL IS LESS THAN ONE FULL STORY BELOW THE UPPER LEVEL.
- AS PER R315.3 CARBON MONOXIDE ALARMS SHALL BE INSTALLED IN THE FOLLOWING LOCATIONS CARBON MONOXIDE ALARMS IN DWELLING UNITS SHALL BE INSTALLED OUTSIDE OF EACH SEPARATE SLEEPING AREA IN THE IMMEDIATE VICINITY OF THE BEDROOMS. WHERE A FUEL-BURNING APPLIANCE IS LOCATED WITHIN A BEDROOM OR ITS ATTACHED BATHROOM, A CARBON MONOXIDE ALARM SHALL BE INSTALLED WITHIN THE BEDROOM.

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The state of the s

LOCATION

CELLAR

GROUND FL

1ST FL

2ND FL.

0.S P.

2ND FL. LIGHTING PLAN

VILLAGE OF GREAT NECK **BUILDING DEPARTMENT** AFFROVED TO PROCEED WITH BOARD REVIEW DATE: 02/20/205 VILLAGE BOARD: HZM, BOA, ARC

VILLAGE OF GREAT NECK BUILDING DEPARTMENT

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PROPOSED

LIGHTING

PLANS

E-101.00

DATE ISSUED: 2/15/2025 **DATE CREATED:** 01/24/2024

DRAWN BY:

14 OF 23

AS NOTED

FEB 19 2025

												_
LEGEND				** ************************************		LIGHTING	FIXTURE	SCHEDU				_
· ©	LED GIMBAL DOWNLIGHTING MODULE	TYPE	MOUNT	BULB TYPE	LAMP	INPUT WATTAGE	LUMEN	QUANTITY	TOTAL WATTAGE	EFFICACY	VOLTAGE	_
	LED WALL MOUNT EXTERIOR LIGHT	0	CEILING MOUNT DOWNLIGHT	LITHONIA LIGHTING, 4 INCH LED BULB	LED	10 5W	810	9	94 5	85 00%	120	_
\$,	SINGLE POLE SWITHCH	0	CEILING MOUNT DOWNLIGHT	LITHONIA LIGHTING, 4 INCH LED BULB	LED	10 5W	810	3	31.5	85 0%	120	_
\$2	THREE-WAY POLE SWITCH	0	CEILING MOUNT DOWNLIGHT	LITHONIA LIGHTING, 4 INCH LED BULB	LED	10 5W	810	21	220 5	85 0%	120	
\$4	FOUR-WAY POLE SWITCH	0	CEILING MOUNT DOWNLIGHT	LITHONIA LIGHTING, 4 INCH LED BULB	LED	10 5W	810	10	1050	85 0%	120	
	WIRING CONCEALED IN WALL/CEILING	<u>xtx</u>	LED WALL MOUNT EXTERIOR LIGHT	KICHLER LIGHTING, G4 BI-PIN LED BULB	LED	20W	810	4	80.0	85 0%	120	
 	ELECTRIC OUTLET						· · · · · · · · · · · · · · · · · · ·					
₩	ELECTRIC OUTLET(GFCI)			\sim	~~	~	~~	~~	~~	~~	~~	•

s ELECTRICAL NOTES

- ALL ELECTRICAL WORK SHALL CONFORM TO THE REQUIREMENTS OF THE 2018 NATIONAL
- ELECTRICAL CODE(NFPA70) AND THE 2018 INTERNATIONAL RESIDENTIAL CODES
 2. ALL WORK TO BE PERFORMED BY A LICENSED ELECTRICIAN
- 3. PROVIDE GROUND-FAULT AND ARC-FAULT CIRCUIT INTERRUPTER PROTECTIONS IN ACCORDANCE W/ SECTION E3902 OF THE 2015 IRC
- 4 GENERAL USE RECEPTACLE PLACEMENT SHALL BE IN ACCORDANCE W/ SECTION 3901.2 OF THE 2018 IRC> NO POINT MEASURED HORIZONTALLY ALONG THE WALL SHALL BE MORE THAN 6"
- FROM A RECEPTACLE, 2' FOR KITCHEN COUNTERTOP RECEPTACLES

 PROVIDE AT LEAST ONE WALL SWITCH CONTROLLED LIGHTING FIXTURE ON THE EXTERIOR SIDE OF EACH EGRESS DOOR IN ACCORDANCE WITH SECTION E393.3 OF THE 2018 IRC.
- EACH EGRESS DOOR IN ACCORDANCE WITH SECTION E393.3 OF THE 2018 IRC.

 100% OF ALL LAMPS IN PERMANENTLY INSTALLED FIXTURES MUST BE HIGH EFFICIENCY.

 ELECTRICAL CONTRACTOR TO PROVIDE 400 AMP SERVICE TO HOSE
- 8 ALL INSTALLATIONS MUST BE GROUNDED
 9 ALL RECESSED LIGHT FIXTURES TO BE TYPE IC RATED.
- 10 ALL EXTERIOR USE FIXTURES & RECEPTACLES TO BE WEATHERPROOF.
- ELECTRICIAN IS RESPONSIBLE FOR ALL ELECTRICAL INSPECTIONS AND FOR PROVIDING UL CERTIFICATE UPON COMPLETION.
- 12. LIGHTING & ELECTRICAL OUTLET PLAN IS A PRELIMINARY LAYOUT FINAL SELECTION AND LOCATION OF ALL ELECTRICAL LIGHT FIXTURES TO BE BY OWNER. G C & ELECTRICAL CONTRACTOR TO CONFIRM THE EXACT LOCATION AND MOUNTING OF THE LIGHTING FIXTURES PRIOR TO ROUGH-IN

SMOKE & CARBON MONOXIDE DETECTOR NOTES

PROVIDE SMOKE ALARMS AS PER SECTION 314 OF THE 2018 IRC UNITS SHALL BE HARDWIRED AND INTERCONNECTED WITH BATTERY BACKUP

- AS PER R314.3 SMOKE ALARMS SHALL BE INSTALLED IT HE FOLLOWING LOCATIONS
 1 IN EACH SLEEPING ROOM.
- OUTSIDE OF EACH SEPARATE SLEEPING AREA IN THE IMMEDIATE VICINITY OF THE BEDROOMS.

 ON EACH ADDITIONAL STORY OF THE DWELLING INCLUDING BASEMENT AND CELLARS, BUT NOT INCLUDING CRAWL SPACES AND UNINHABITABLE ATTIC IN DWELLING UNITS WITH SPLIT LEVELS AND WITHOUT AN INTERVENING DOOR BETWEEN THE ADJACENT LEVELS. A SMOKE ALARM INSTALLED ON THE UPPER LEVEL SHALL SUFFICE FOR THE ADJACENT LOWER LEVEL PROVIDED THAT THE LOWER LEVEL IS LESS THAN ONE FULL STORY BELOW THE UPPER LEVEL
- AS PER R315 3 CARBON MONOXIDE ALARMS SHALL BE INSTALLED IN THE FOLLOWING LOCATIONS

 CARBON MONOXIDE ALARMS IN DWELLING UNITS SHALL BE INSTALLED OUTSIDE OF EACH SEPARATE SLEEPING AREA IN THE IMMEDIATE VICINITY OF THE BEDROOMS. WHERE A FUEL-BURNING APPLIANCE IS LOCATED WITHIN A BEDROOM OR ITS ATTACHED BATHROOM, A CARBON MONOXIDE ALARM SHALL BE INSTALLED WITHIN THE BEDROOM.

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	© 51			\$\text{\$\sigma}\$	
****	SC TO FIRST FLOOP		\$2 DN \$1	\$1	AD AD AD AD AD AD AD AD AD ADDRESS OF THE PARTY OF THE PA
				THE SECOND ALL SECTION OF THE SECTIO	

CEL. & GROUND FL.LIGHTING PLAN

SCALE: 1/4" = 1'-0"

LOCATION


CELLAR

GROUND FL

1ST FL.

2ND FL

0 S P.

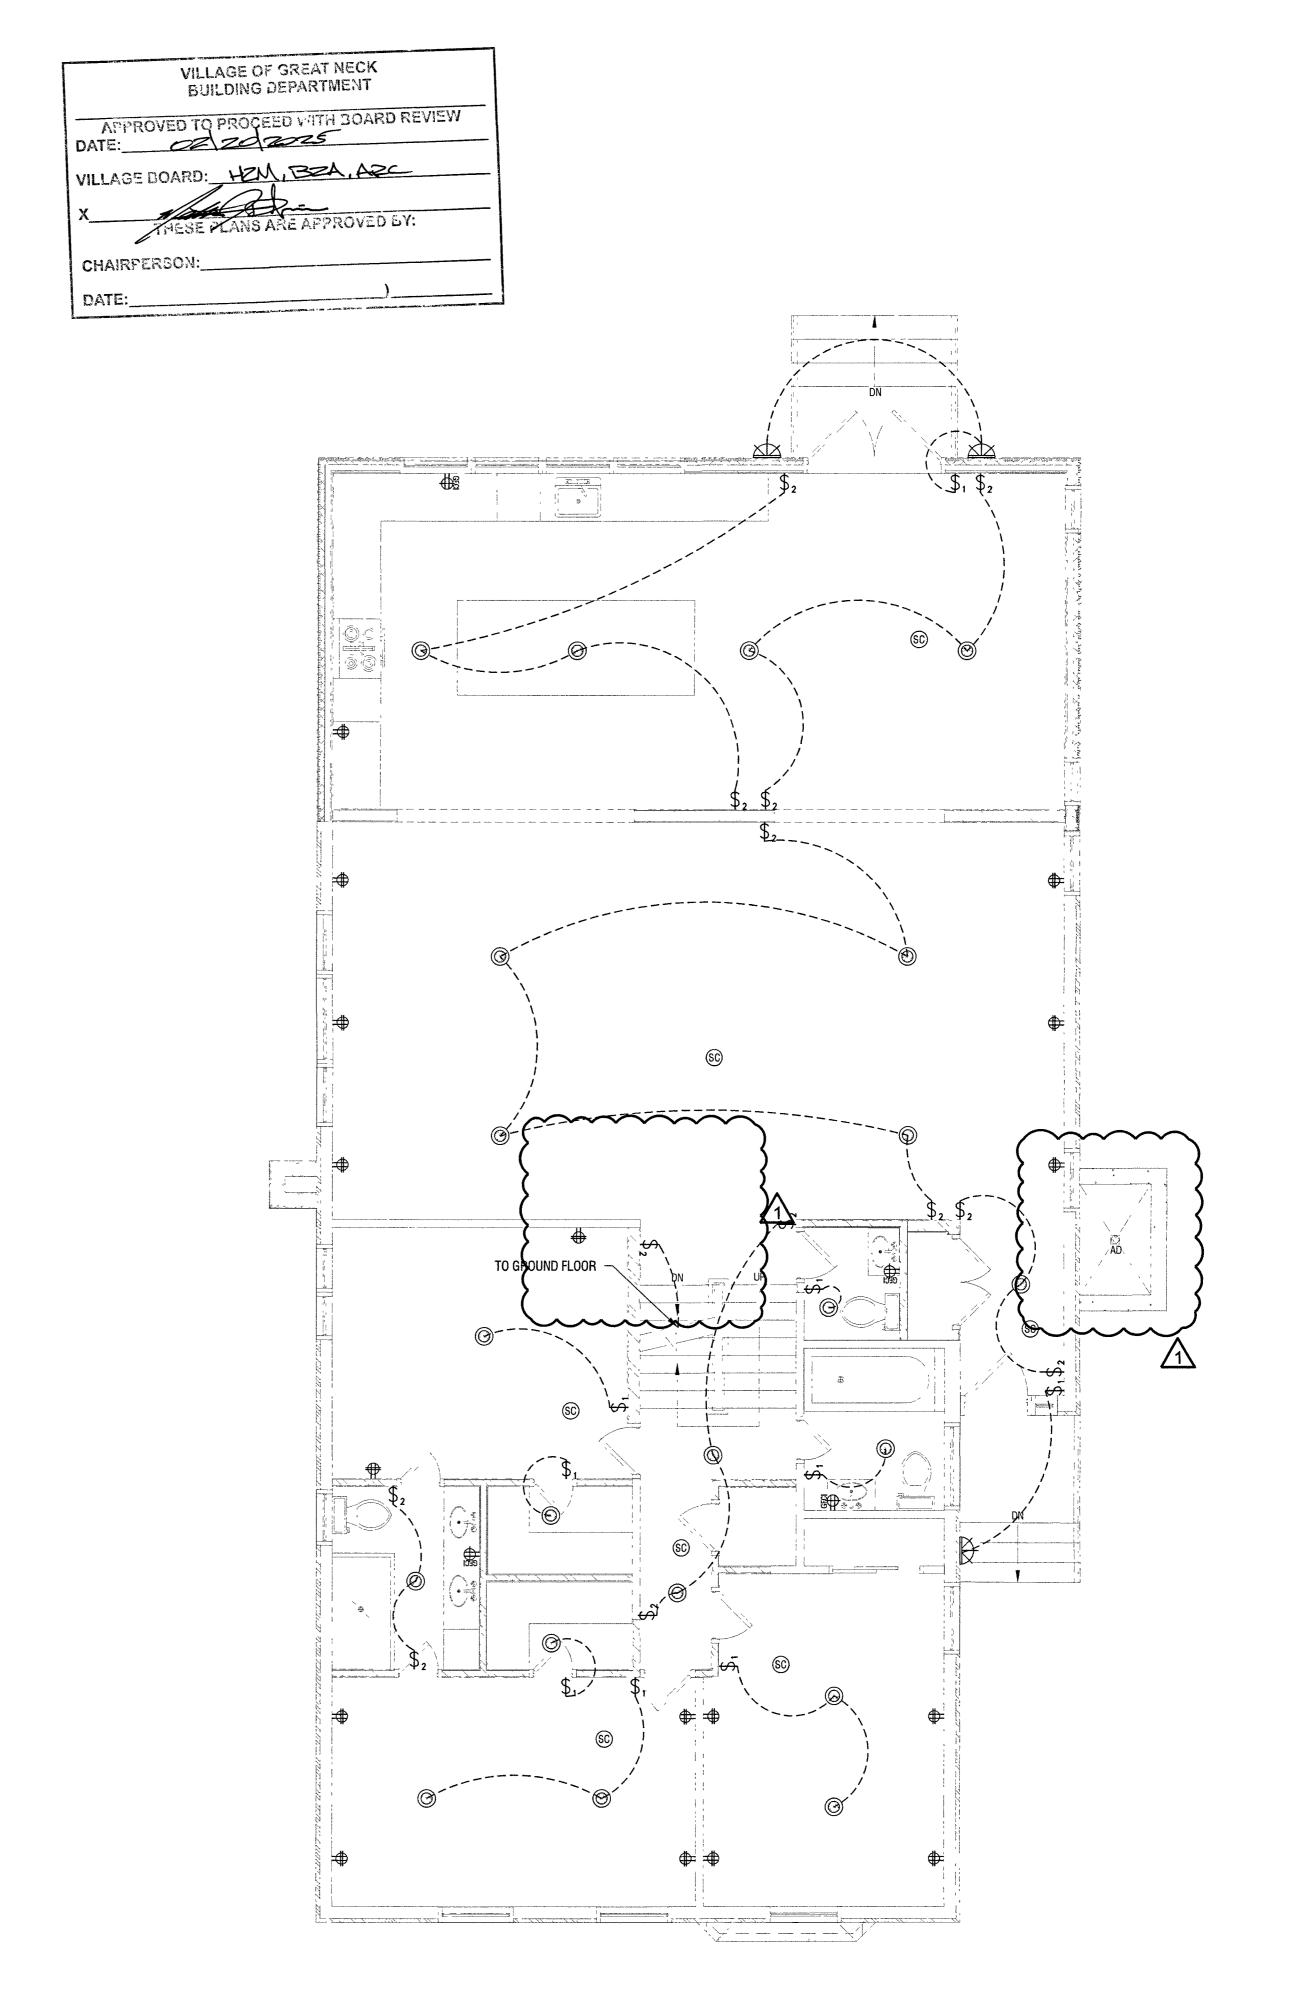

2 SCALE: 1/4" = 1'-0"

VILLAGE OF GREAT NECK BUILDING DEPARTMENT FEB 19 2023 HTASSOCIATE

3b-09 MAIN STREET, SUITE BD FLUSHING, NY 11354 T: 718-799-0901 E: INFO@HTASSOCIATES.NET

1 COMMENTS REVISION ISSUED 01.30.25

DAVID'S RESIDENCE

105 MAPLE ST GREAT NECK, NY 11023 SECTION: 1, BLOCK: 189, LOT: 3

PROPOSED LIGHTING PLANS

E-100.00

PAGE: 13 0F 23

DATE ISSUED: 2/15/2025

DATE CREATED: 01/24/2024

SCALE: AS NOTED

DRAWN BY: LW

CHECKED BY: KY FU

JOB #: 24036


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OF NEW YORK


KY FU OR


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T	INSULATION SCHEDULE									
and the second	PIPING SYSTEM TYPES	FLUID TEMPERATU RE RANGE °F	RUN OUTS UP TO 1"	1-1/4" TO 2"	2-1/2" TO 4"	5" TO 6"	8" OR LARGER			
S	DOMESTIC COLD WATER	40°F	1/2"	1/2"	1/2"	1/2"	1/2"			
	DOMESTIC HOT WATER	105°F	1/2"	1"	1-1/2"	1-1/2"	1-1/2"			
,	(INSULATION THICKNESS IN INCHES FOR PIPE SIZE)									



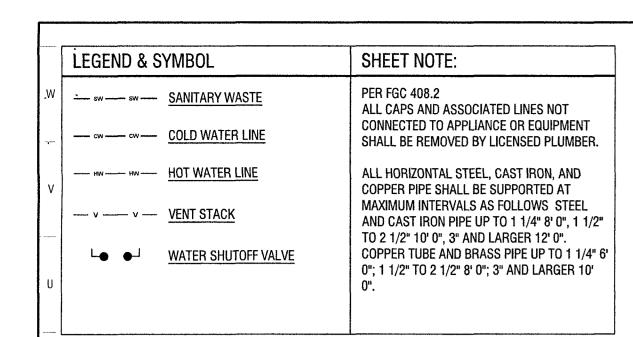

VILLAGE OF GREAT NECK
BUILDING DEPARTMENT

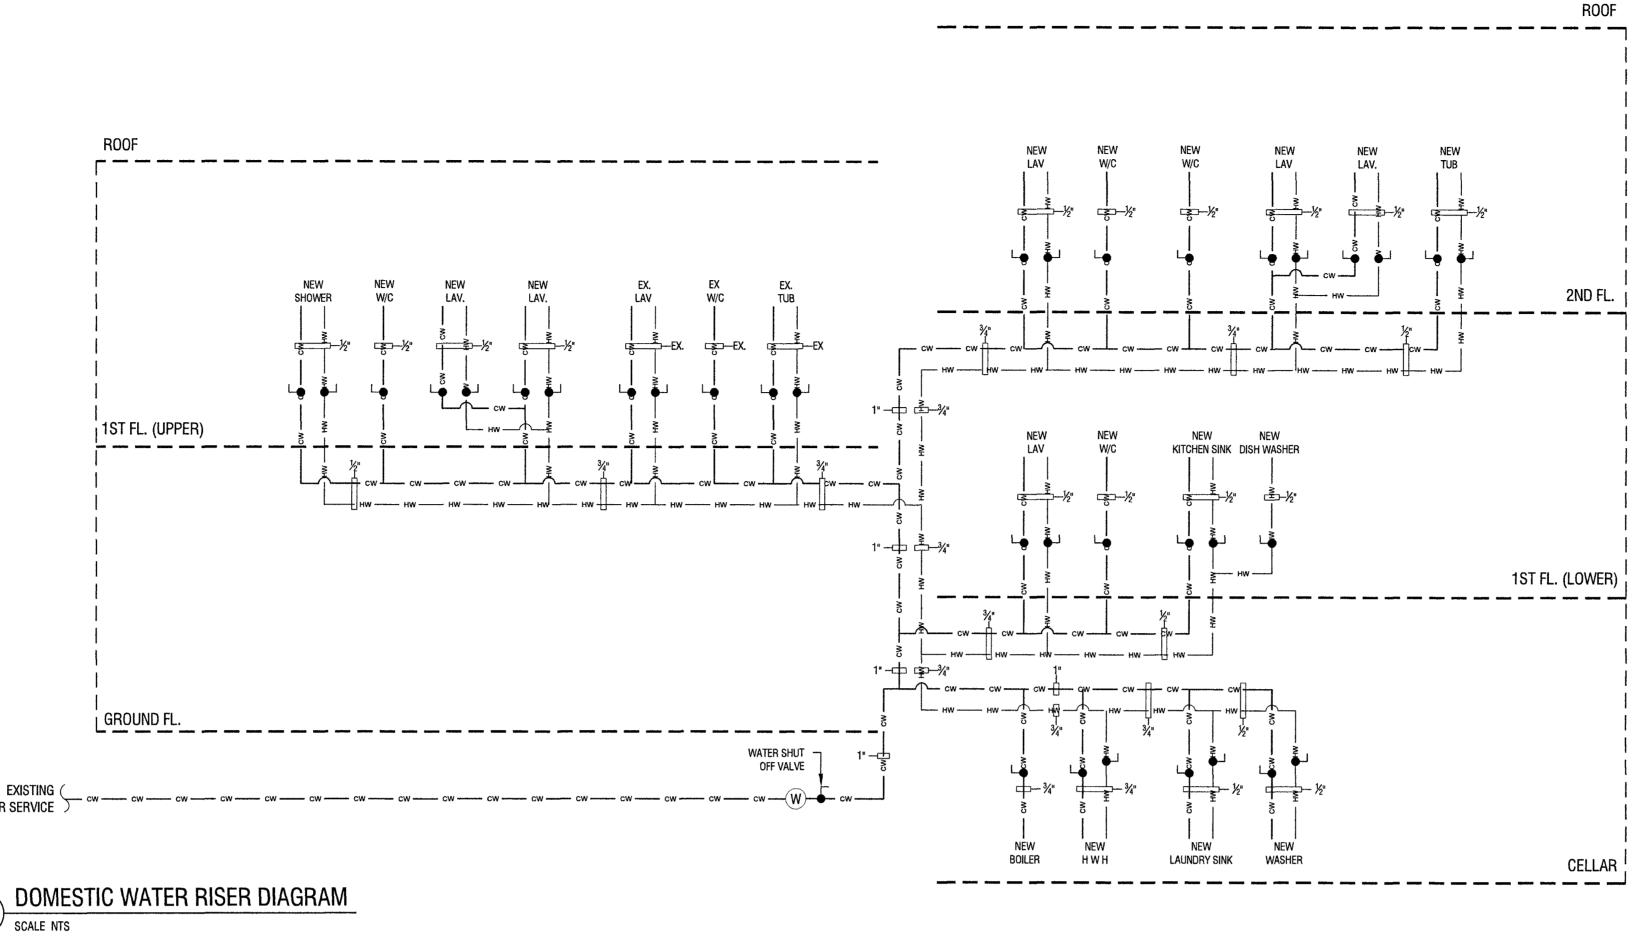AFPROVED TO PROCEED WITH BOARD REVIEW
DATE:

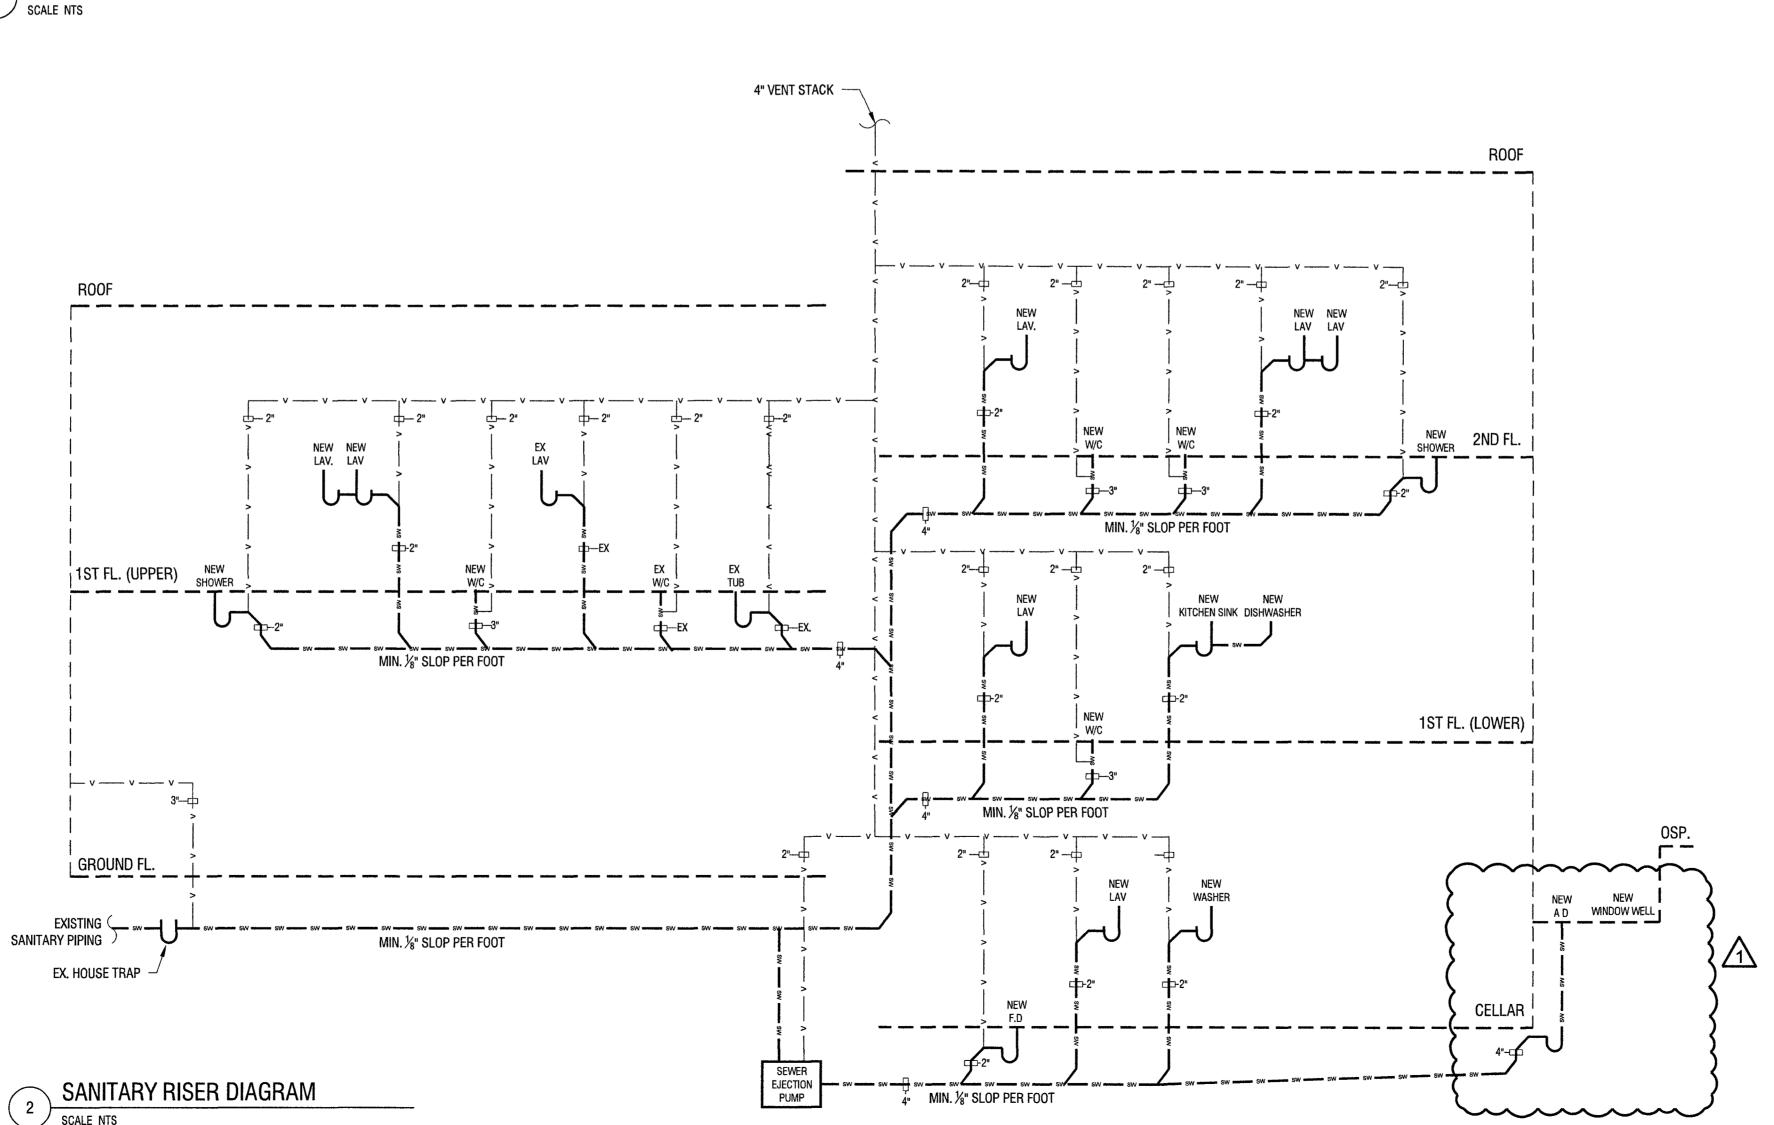VILLAGE BOARD:

X

XHESE FLANS ARE APPROVED BY:

CHAIRPERSON:

DATE:

GREAT NECK, NY 11023

DAVID'S RESIDENCE

PROPOSED
PLUMBING
RISER

PL-100.00

PAGE: 15 OF 23

DATE ISSUED: 2/15/2025

DATE CREATED: 01/24/2024

SCALE: AS NOTED

DRAWN BY: KP


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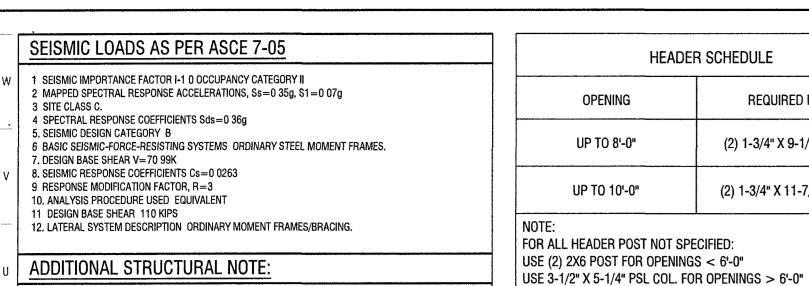
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VILLAGE OF GREAT NECK BUILDING DEPARTMENT FEB 19 2025






ACCULATION OF CLOTHER ALMOTE.
ADDITIONAL STRUCTURAL NOTE:
ADDITIONAL UTITOOTOTIAL NOTE.

ALL EXISTING STRUCTURE ELEMENTS WILL BE VERIFIED AFTER DEMOLITION PHASE 2 PRESSURE TRADED WOOD WILL BE PROVIDED FOR THE RE-MODIFY WOOD DECK

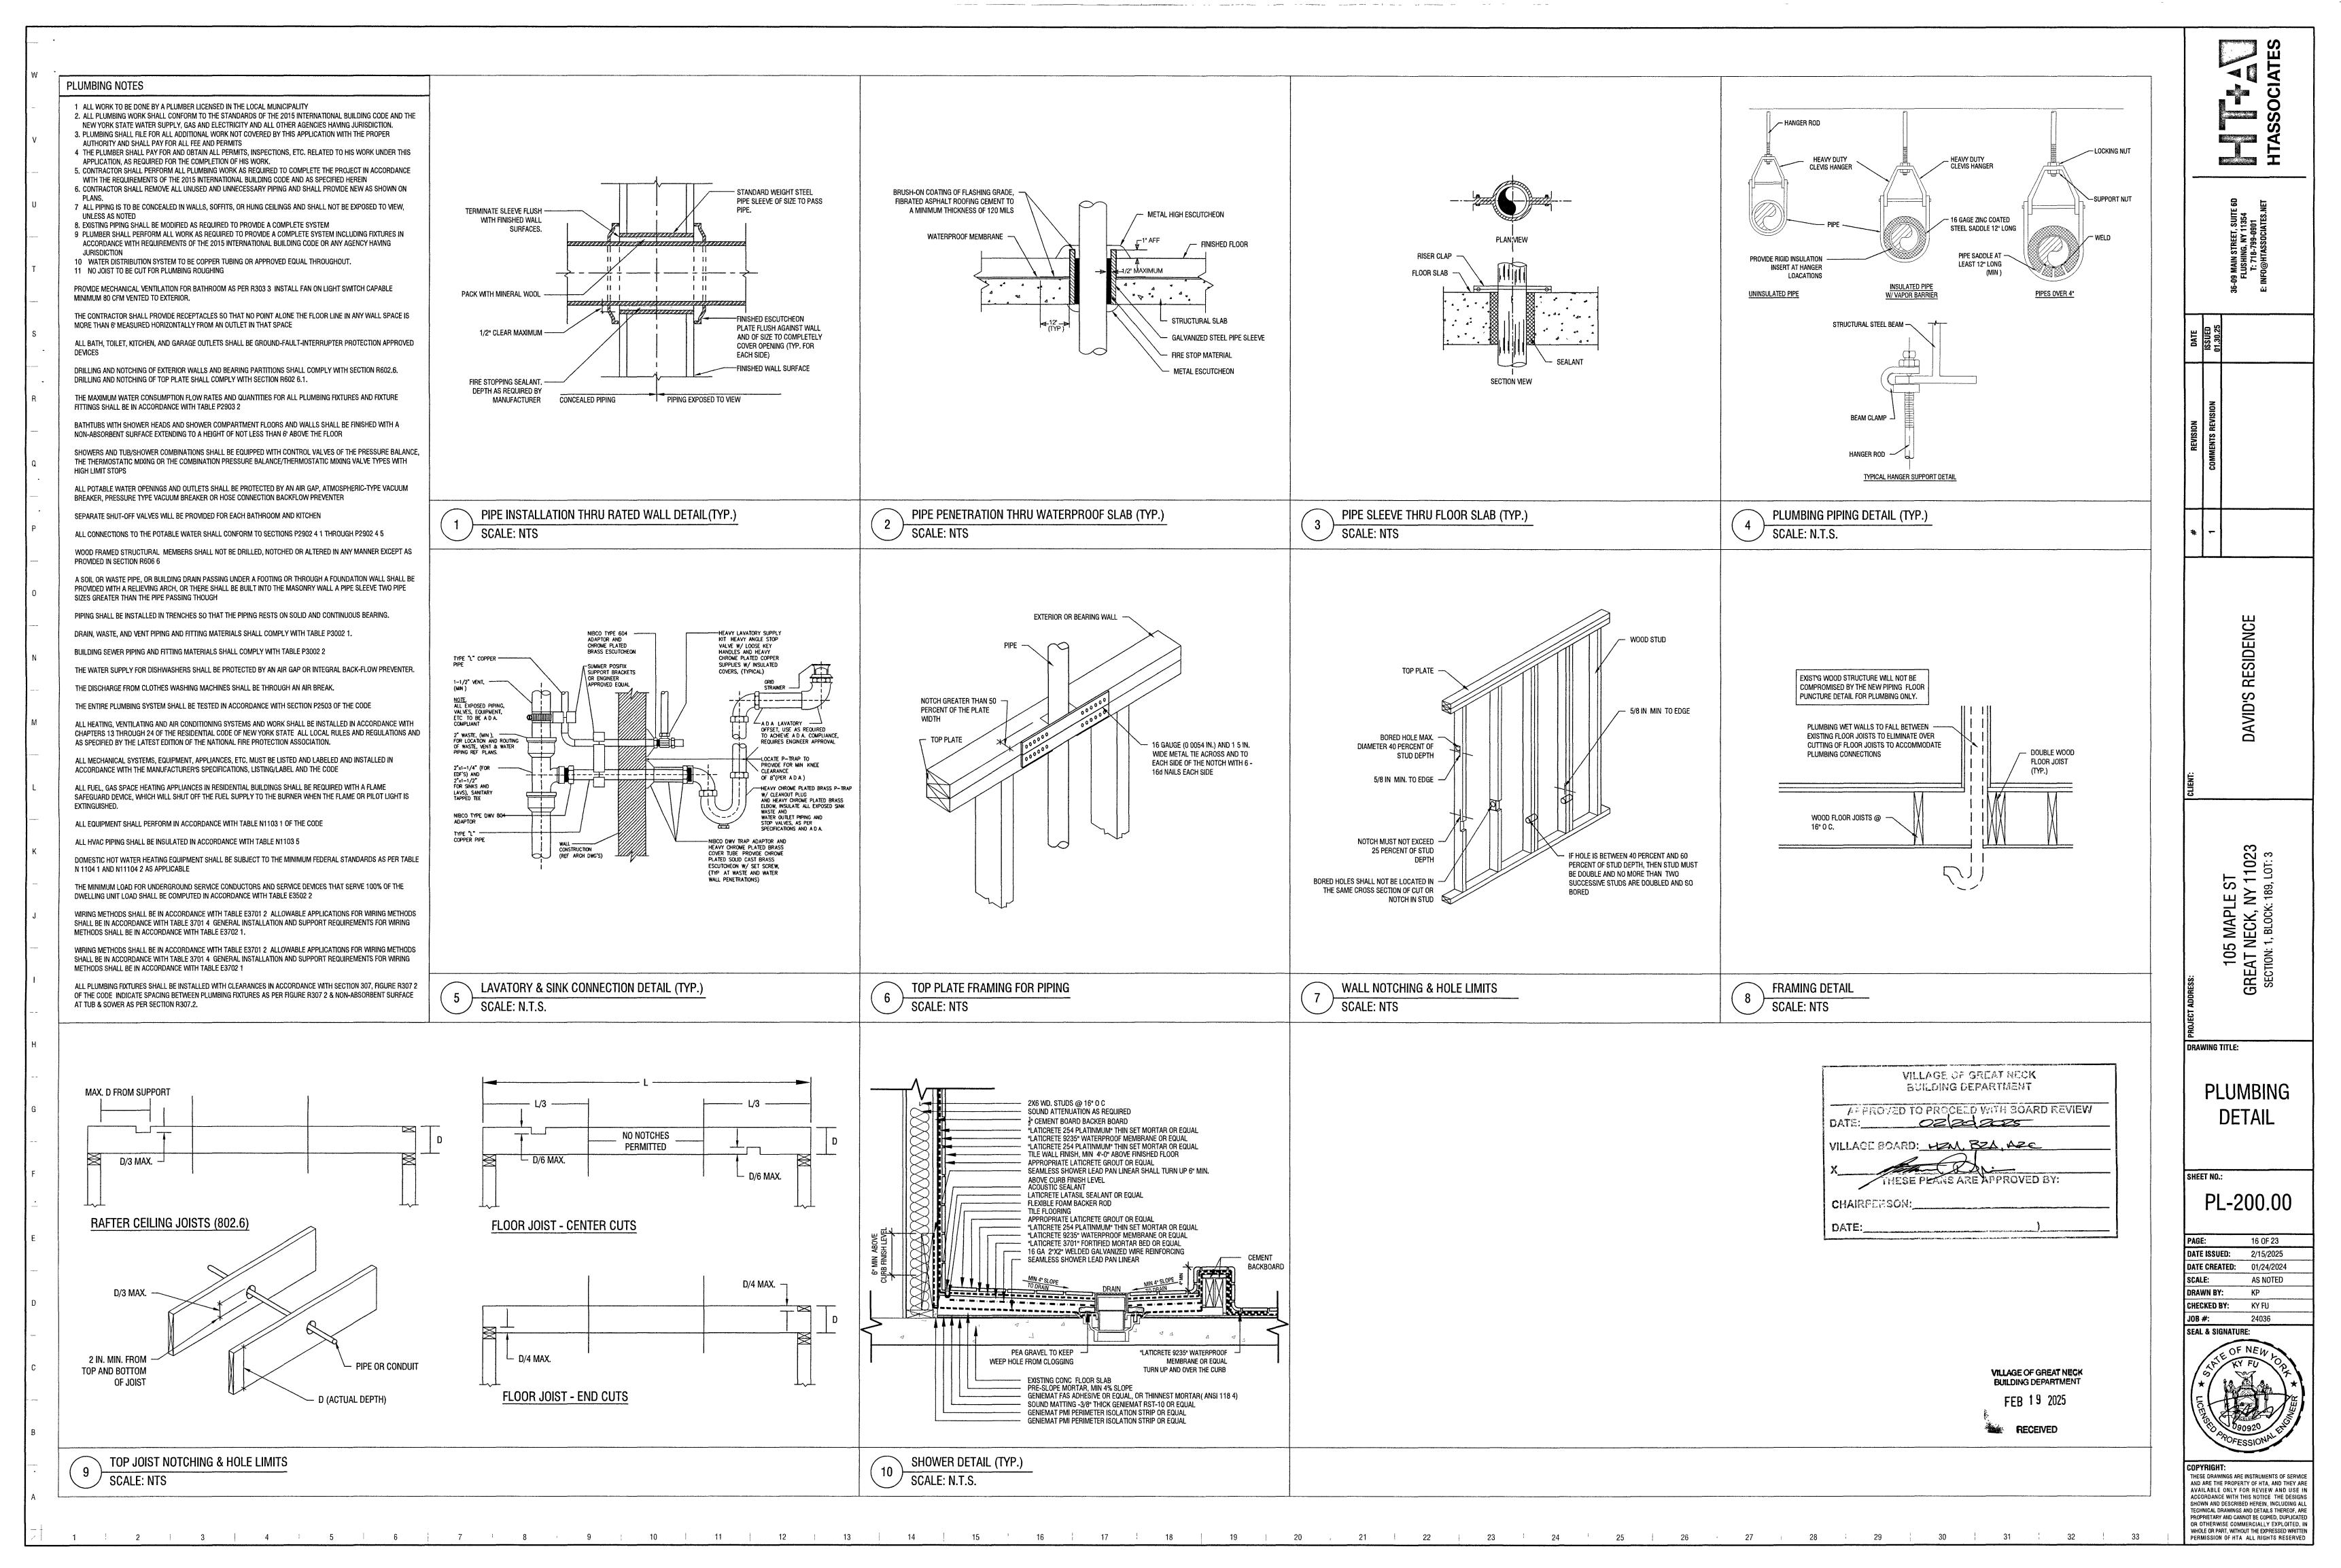Ţ	LINTEL SCHEDULE											
	OPENING	STEEL ANGLES	WIDE FLANGE BEAM	REMARKS								
S	4'-0" OR LESS	L4" x 3-1/2" x 5/16"	W10 x 15 MIN.	DOUBLE LINTELS FOR MASONRY								
	4'-1" TO 7'-0"	L5" x 3-1/2" x 5/16"	W10 x 17 MIN.	WALLS WITH FACE BRICK AND BACK-UP								
R	OVER 7'-0"	L5" x 3-1/2" x 1/2"	W10 x 19 MIN.	CONCRETE BLOCK WALLS								
	NOTE:											


A. 3-1/2" LEGS ARE HORIZONTAL B. PROVIDE ONE ANGLE FOR EACH 4" OF WALL THICKNESS C. PROVIDE L5" x 5" x 5/16" ANGLES FOR 6" THICK WALLS AND PARTITIONS D. PROVIDE MIN. 6" BEARING AT EACH END FOR ALL LINTELS

E. LINTELS OVER 4'-0" SHALL BE FIREPROOFED F. ALL VOIDS BETWEEN LINTELS AND MASONRY UNITS TO BE FIRE PROOF GOUT FILLED

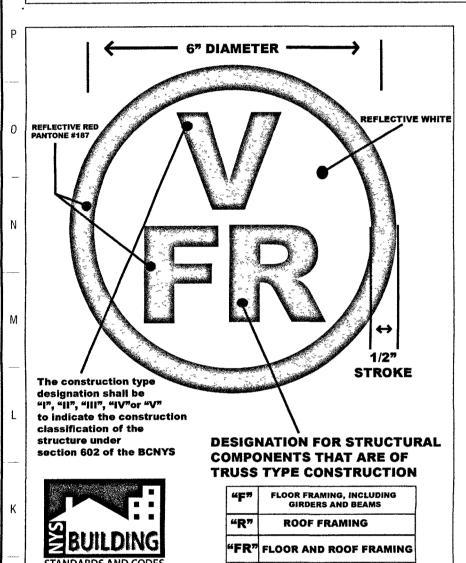

HEADE	ER SCHEDULE			FLANGE SCHEDULE		
OPENING	REQUIRED MEMBER	FLANGE BEAM	LBS/FT	DEPTH	FLANGE WIDTH	WEB THICKNESS
UP TO 8'-0"	(2) 1-3/4" X 9-1/2" LVL U.O.N.	W10 X 30	30	10.47	5.810	0.300
UP TO 10'-0"	(2) 1-3/4" X 11-7/8" LVL U.O N.	W10 X 45	45	10.1	8.020	0.350


STRUCTURAL LEGEND NEW 2X12 FLOOR JOISTS @ 16" 0 C. FIRE BLOCKING PERPENDICULAR @ 8' MAX. W/ 5/8" PLY WD

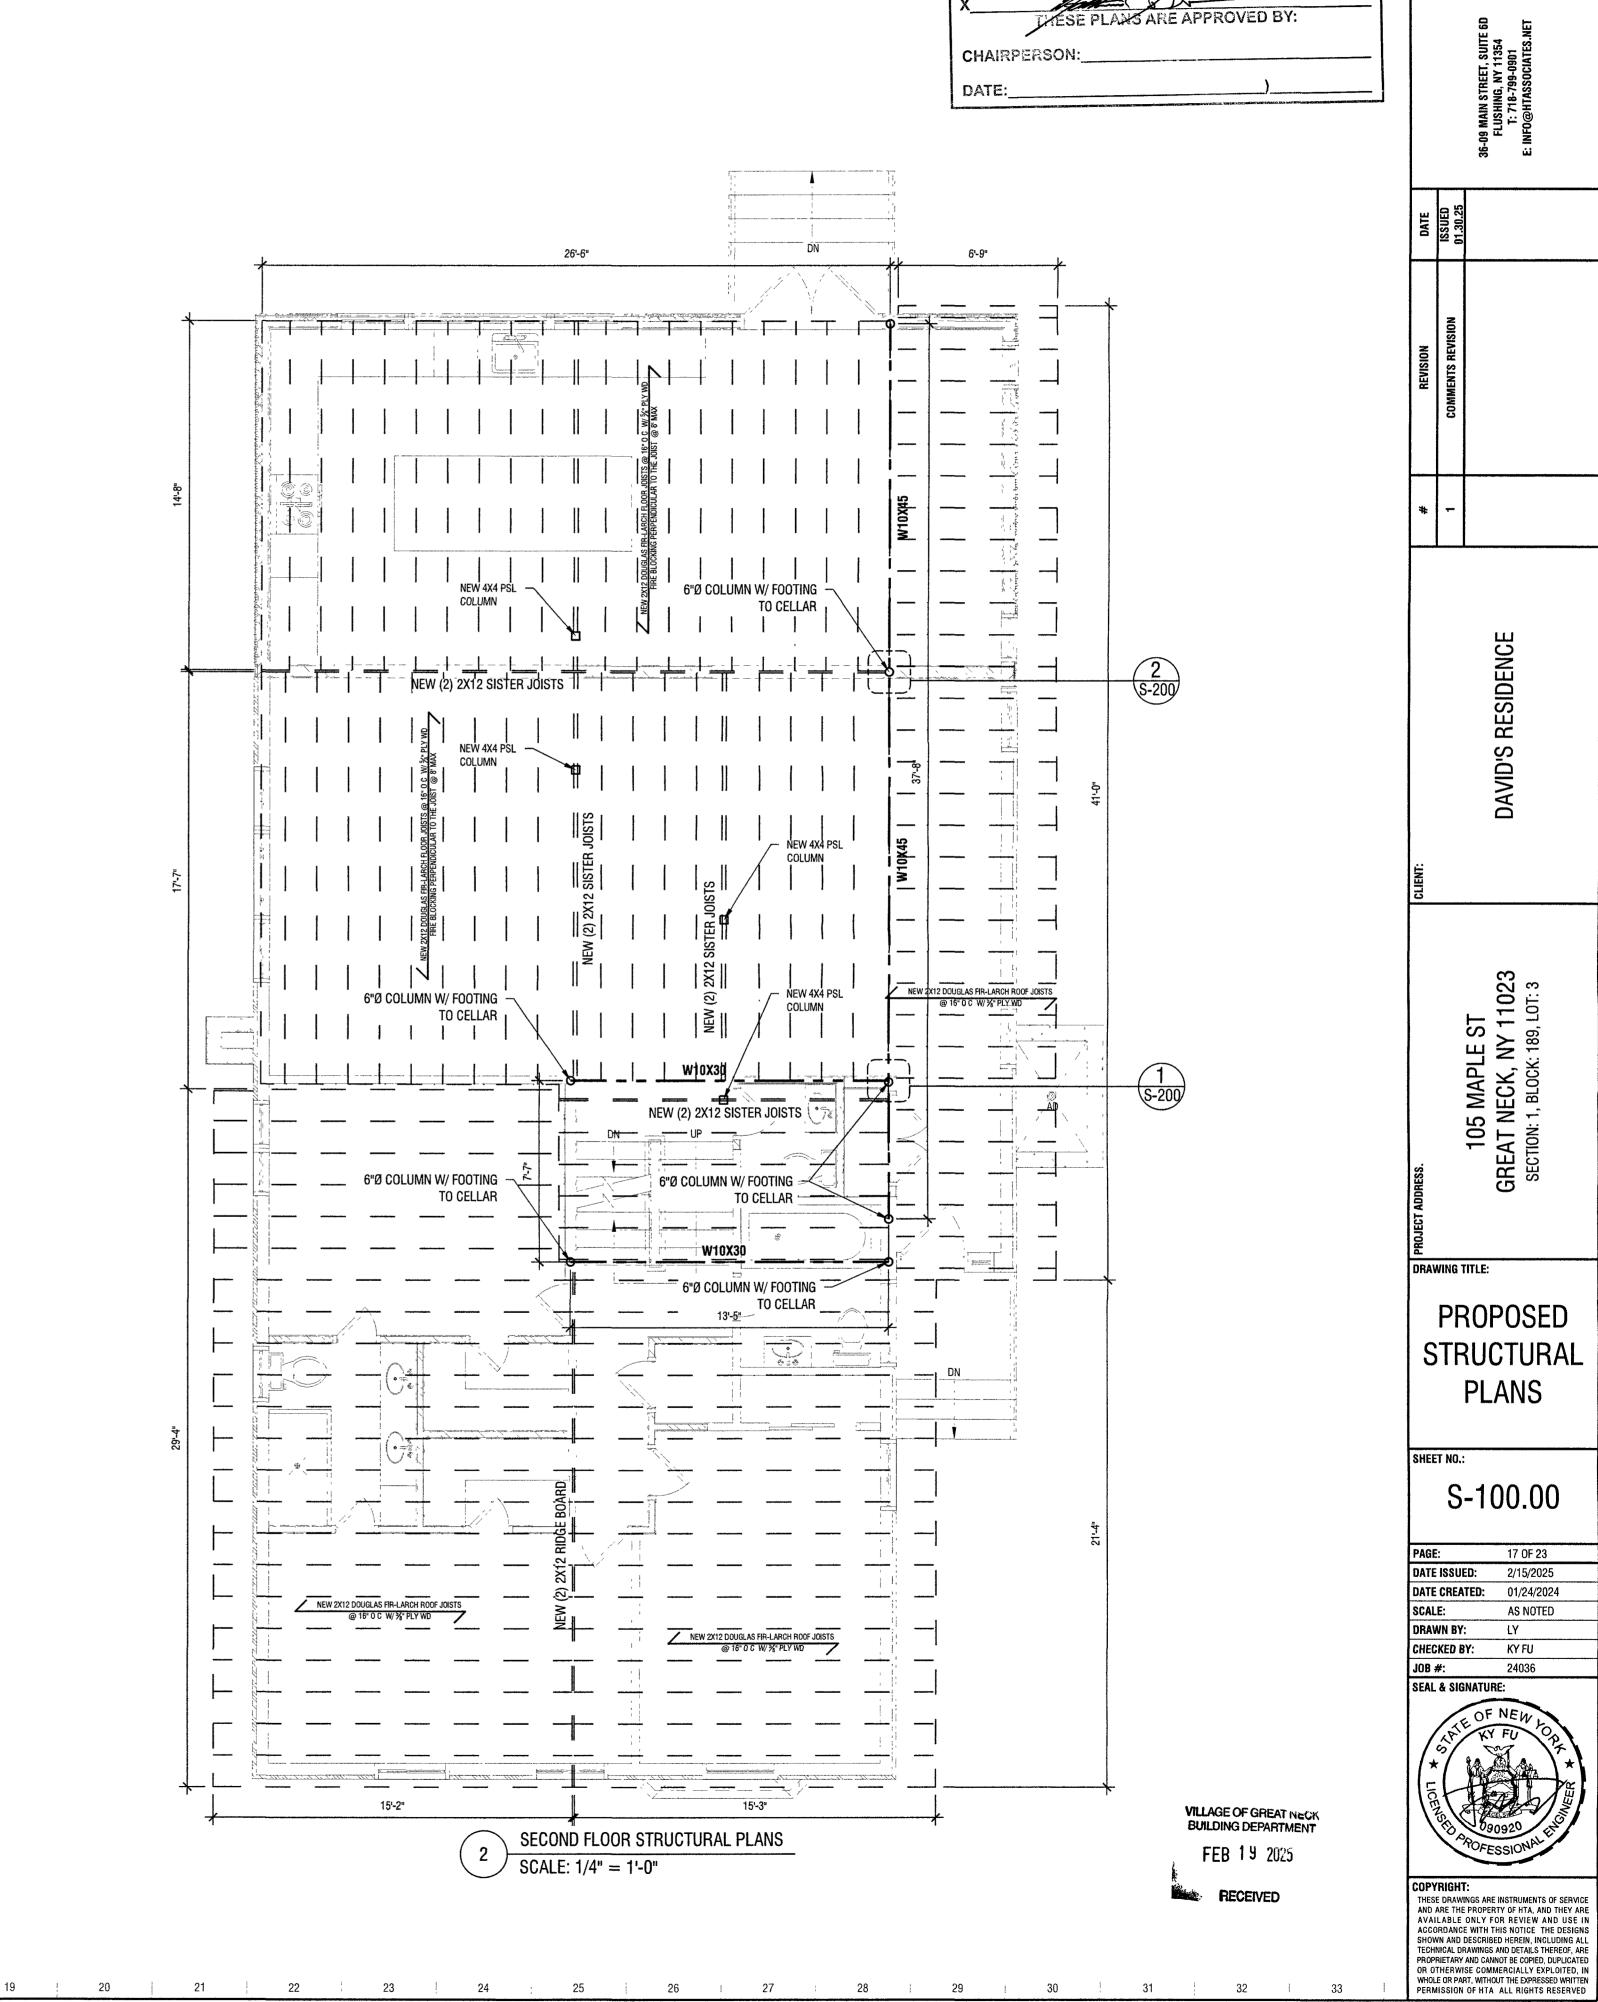

VILLAGE OF GREAT MECK BUILDING DEPARTMENT

APPROVED TO PROCEED WITH SOARD REVIEW

VILLAGE BOARD: HZM, PEL APC

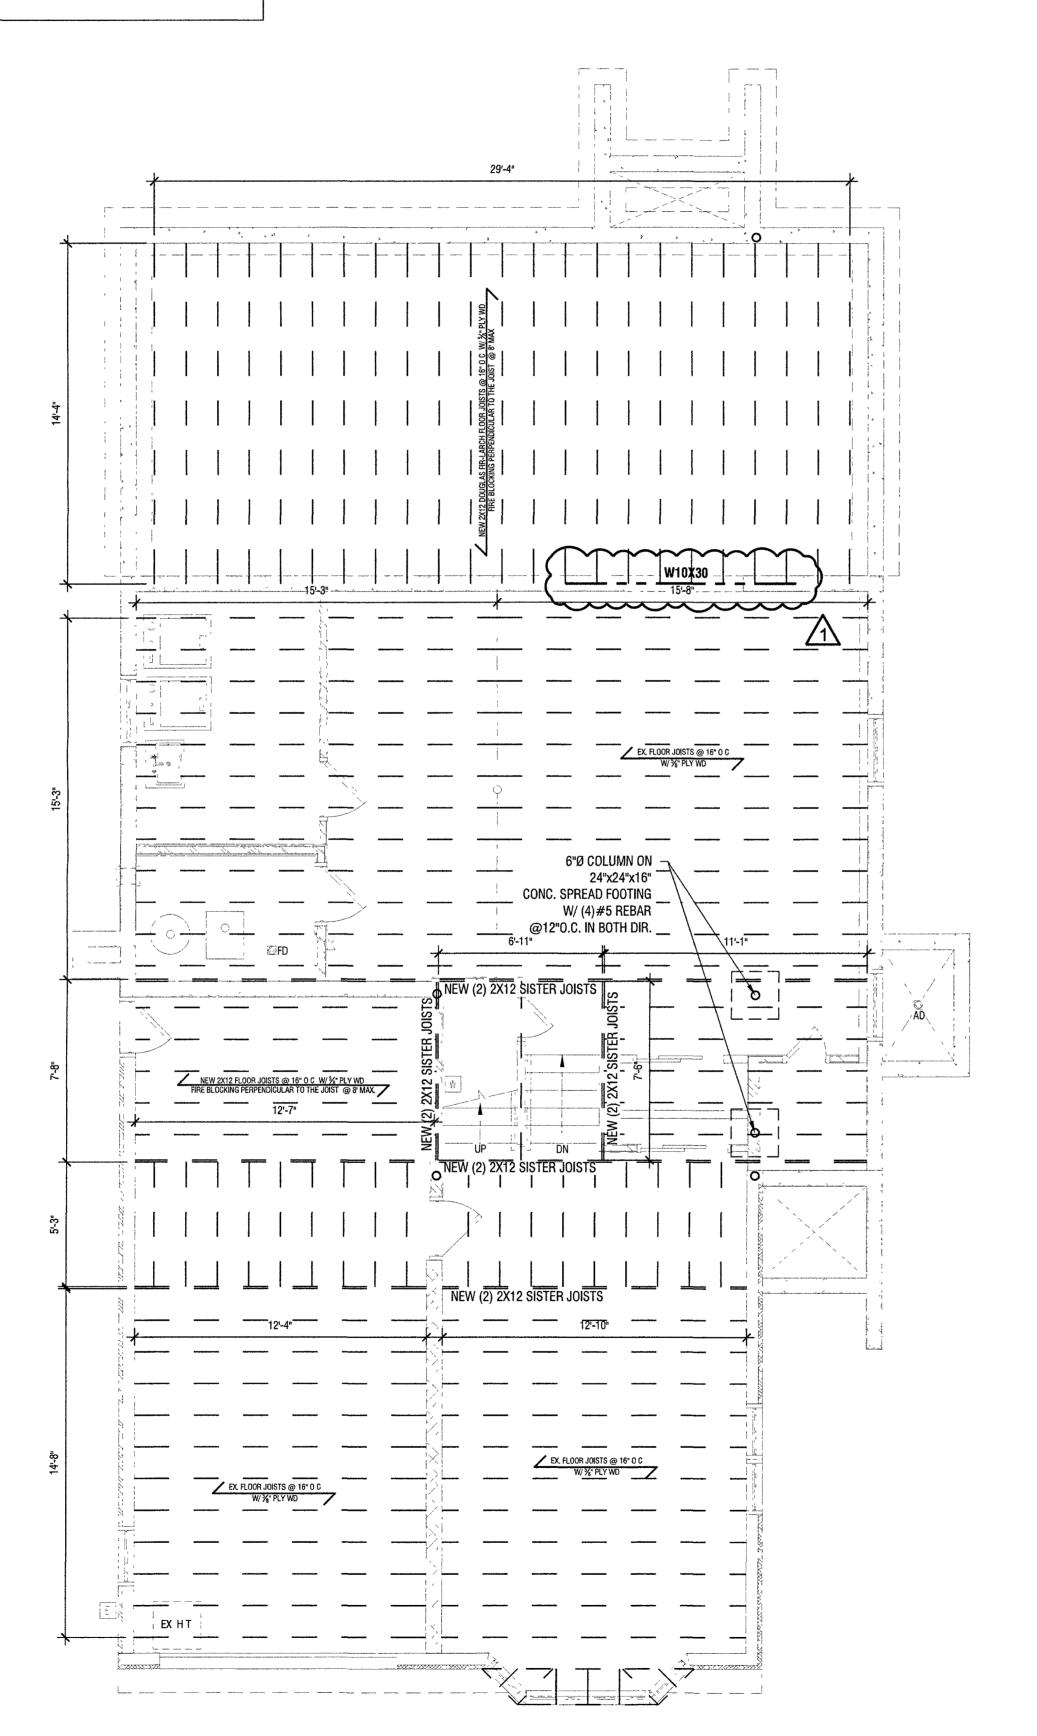

FIRST FLOOR STRUCTURAL PLANS

1 2 3 4 5 6 7 8 9 10 11 12 13 14 15 20 21 22 23 24 25 26 27 28 29 30 13 32 33

SCALE: 1/4" = 1'-0"

	SEISMIC LOADS AS PER ASCE 7-05	
	1 SEISMIC IMPORTANCE FACTOR I-1 0 OCCUPANCY CATEGORY II 2 MAPPED SPECTRAL RESPONSE ACCELERATIONS, Ss=0 35g, S1=0 07g 3 SITE CLASS C	
	4 SPECTRAL RESPONSE COEFFICIENTS Sds=0 36g 5 SEISMIC DESIGN CATEGORY B 6 BASIC SEISMIC-FORCE-RESISTING SYSTEMS ORDINARY STEEL MOMENT FRAMES	U
	7. DESIGN BASE SHEAR V=70 99K 8 SEISMIC RESPONSE COEFFICIENTS Cs=0 0263 9 RESPONSE MODIFICATION FACTOR, R=3 10 ANALYSIS PROCEDURE USED EQUIVALENT	UF
-	11 DESIGN BASE SHEAR. 110 KIPS 12. LATERAL SYSTEM DESCRIPTION ORDINARY MOMENT FRAMES/BRACING	NOTE [.]

FOR ALL HEADER POST NOT SPECIFIED: USE (2) 2X6 POST FOR OPENINGS < 6'-0"

USE 3-1/2" X 5-1/4" PSL COL. FOR OPENINGS > 6'-0"

ΔΠΟΙΤΙΟΝΔΙ	STRUCTUR.	AL NOTE:
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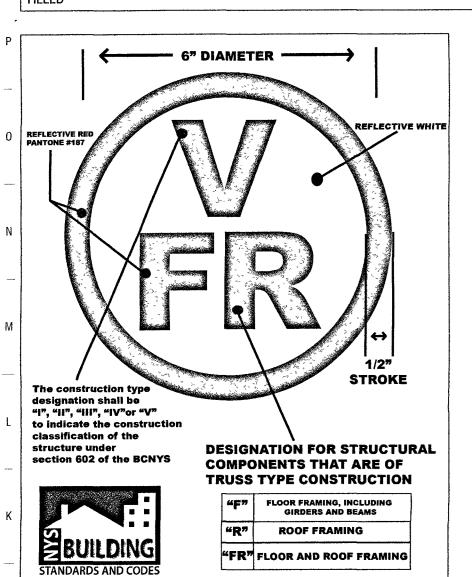
1 ALL EXISTING STRUCTURE ELEMENTS WILL BE VERIFIED AFTER DEMOLITION PHASE 2. PRESSURE TRADED WOOD WILL BE PROVIDED FOR THE RE-MODIFY WOOD DECK.

T	LINTEL SCHEDULE							
	OPENING	STEEL ANGLES	WIDE FLANGE BEAM	REMARKS				
S	4'-0" OR LESS	L4" x 3-1/2" x 5/16"	W10 x 15 MIN.	DOUBLE LINTELS FOR MASONRY				
	4'-1" TO 7'-0"	L5" x 3-1/2" x 5/16"	W10 x 17 MIN.	WALLS WITH FACE BRICK AND BACK-UP				
R	OVER 7'-0"	L5" x 3-1/2" x 1/2"	W10 x 19 MIN.	CONCRETE BLOCK WALLS				
	NOTE:							

A. 3-1/2" LEGS ARE HORIZONTAL B. PROVIDE ONE ANGLE FOR EACH 4" OF WALL THICKNESS


C. PROVIDE L5" x 5" x 5/16" ANGLES FOR 6" THICK WALLS AND PARTITIONS D. PROVIDE MIN. 6" BEARING AT EACH END FOR ALL LINTELS E. LINTELS OVER 4'-0" SHALL BE FIREPROOFED

F. ALL VOIDS BETWEEN LINTELS AND MASONRY UNITS TO BE FIRE PROOF GOUT FILLED




HEAL	DER SCHEDULE			FLANGE SCHEDULE		
ENING	REQUIRED MEMBER	FLANGE BEAM	LBS/FT	DEPTH	FLANGE WIDTH	WEB THICKNESS
TO 8'-0"	(2) 1-3/4" X 9-1/2" LVL U.O.N.	W10 X 30	30	10.47	5.810	0.300
		W10 X 45	45	10.1	8.020	0.350
O 10'-0"	(2) 1-3/4" X 11-7/8" LVL U.O.N.	<u> </u>				<u></u>

		STRUCTURAL LEGEND
NEW 2X12 FLOOR JOISTS @ 16" O.C. FIRE BLOCKING PERPENDICULAR @ 8' MAX. W/ %" P		NEW 2X12 FLOOR JOISTS @ 16" O.C. FIRE BLOCKING PERPENDICULAR @ 8' MAX. W/ $\%$ " PLY

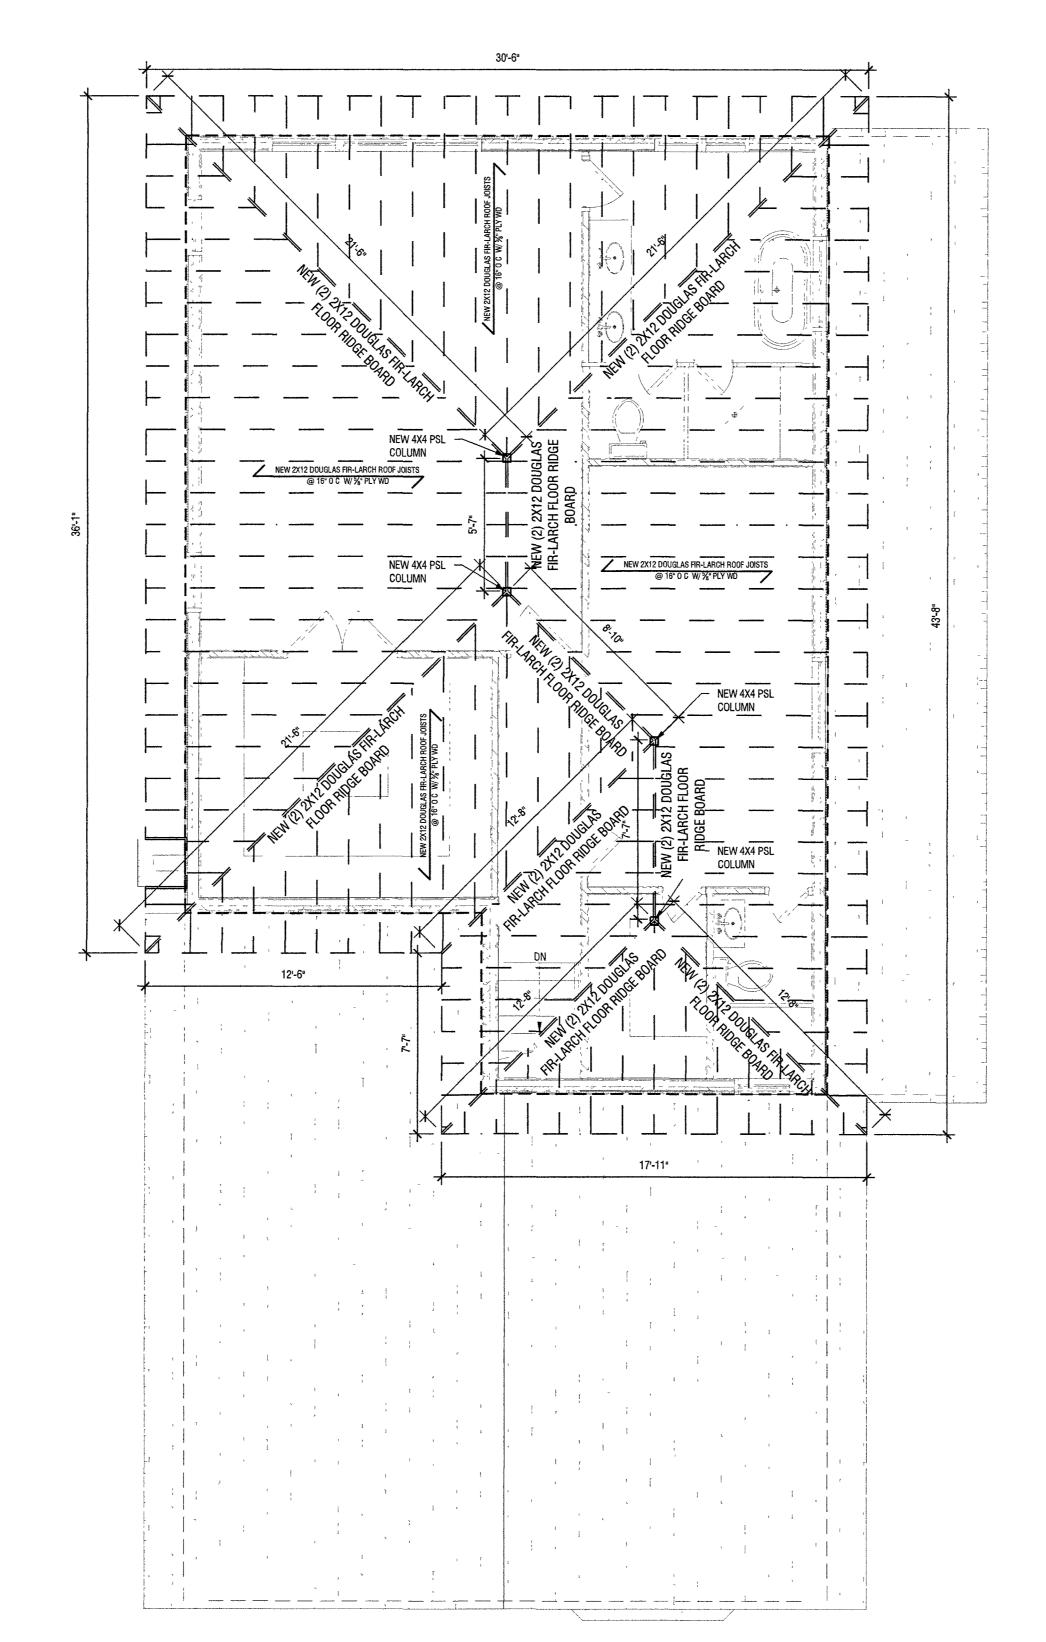

ROOF STRUCTURAL PLANS SCALE: 1/4" = 1'-0"

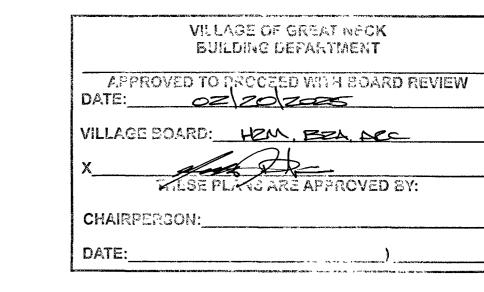

		30-96	Ë	
DATE	ISSUED 01.30.25			
REVISION	COMMENTS REVISION			
#	1			
		AVID'S BESIDENCE	יייי פייייי פייייי	

105 MAPLE ST GREAT NECK, NY 11023 SECTION: 1, BLOCK: 189, LOT: 3

PROPOSED STRUCTURAL **PLANS**

S-101.00

18 OF 23 **DATE ISSUED:** 2/15/2025 DATE CREATED: 01/24/2024 AS NOTED DRAWN BY: KY FU 24036 SEAL & SIGNATURE:




VILLAGE OF GREAT NEUK BUILDING DEPARTMENT

FEB 19 2025

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1 | 2 | 3 | 4 | 5 | 6 | 7 | 8 | 9 | 10 | 11 | 12 | 13 | 14 | 15 | 16 | 17 | 18 | 19 | 20 | 21 | 22 | 23 | 24 | 25 | 26 | 27 | 28 | 29 | 30 | 31 | 32 | 33

HTASSOCIATES

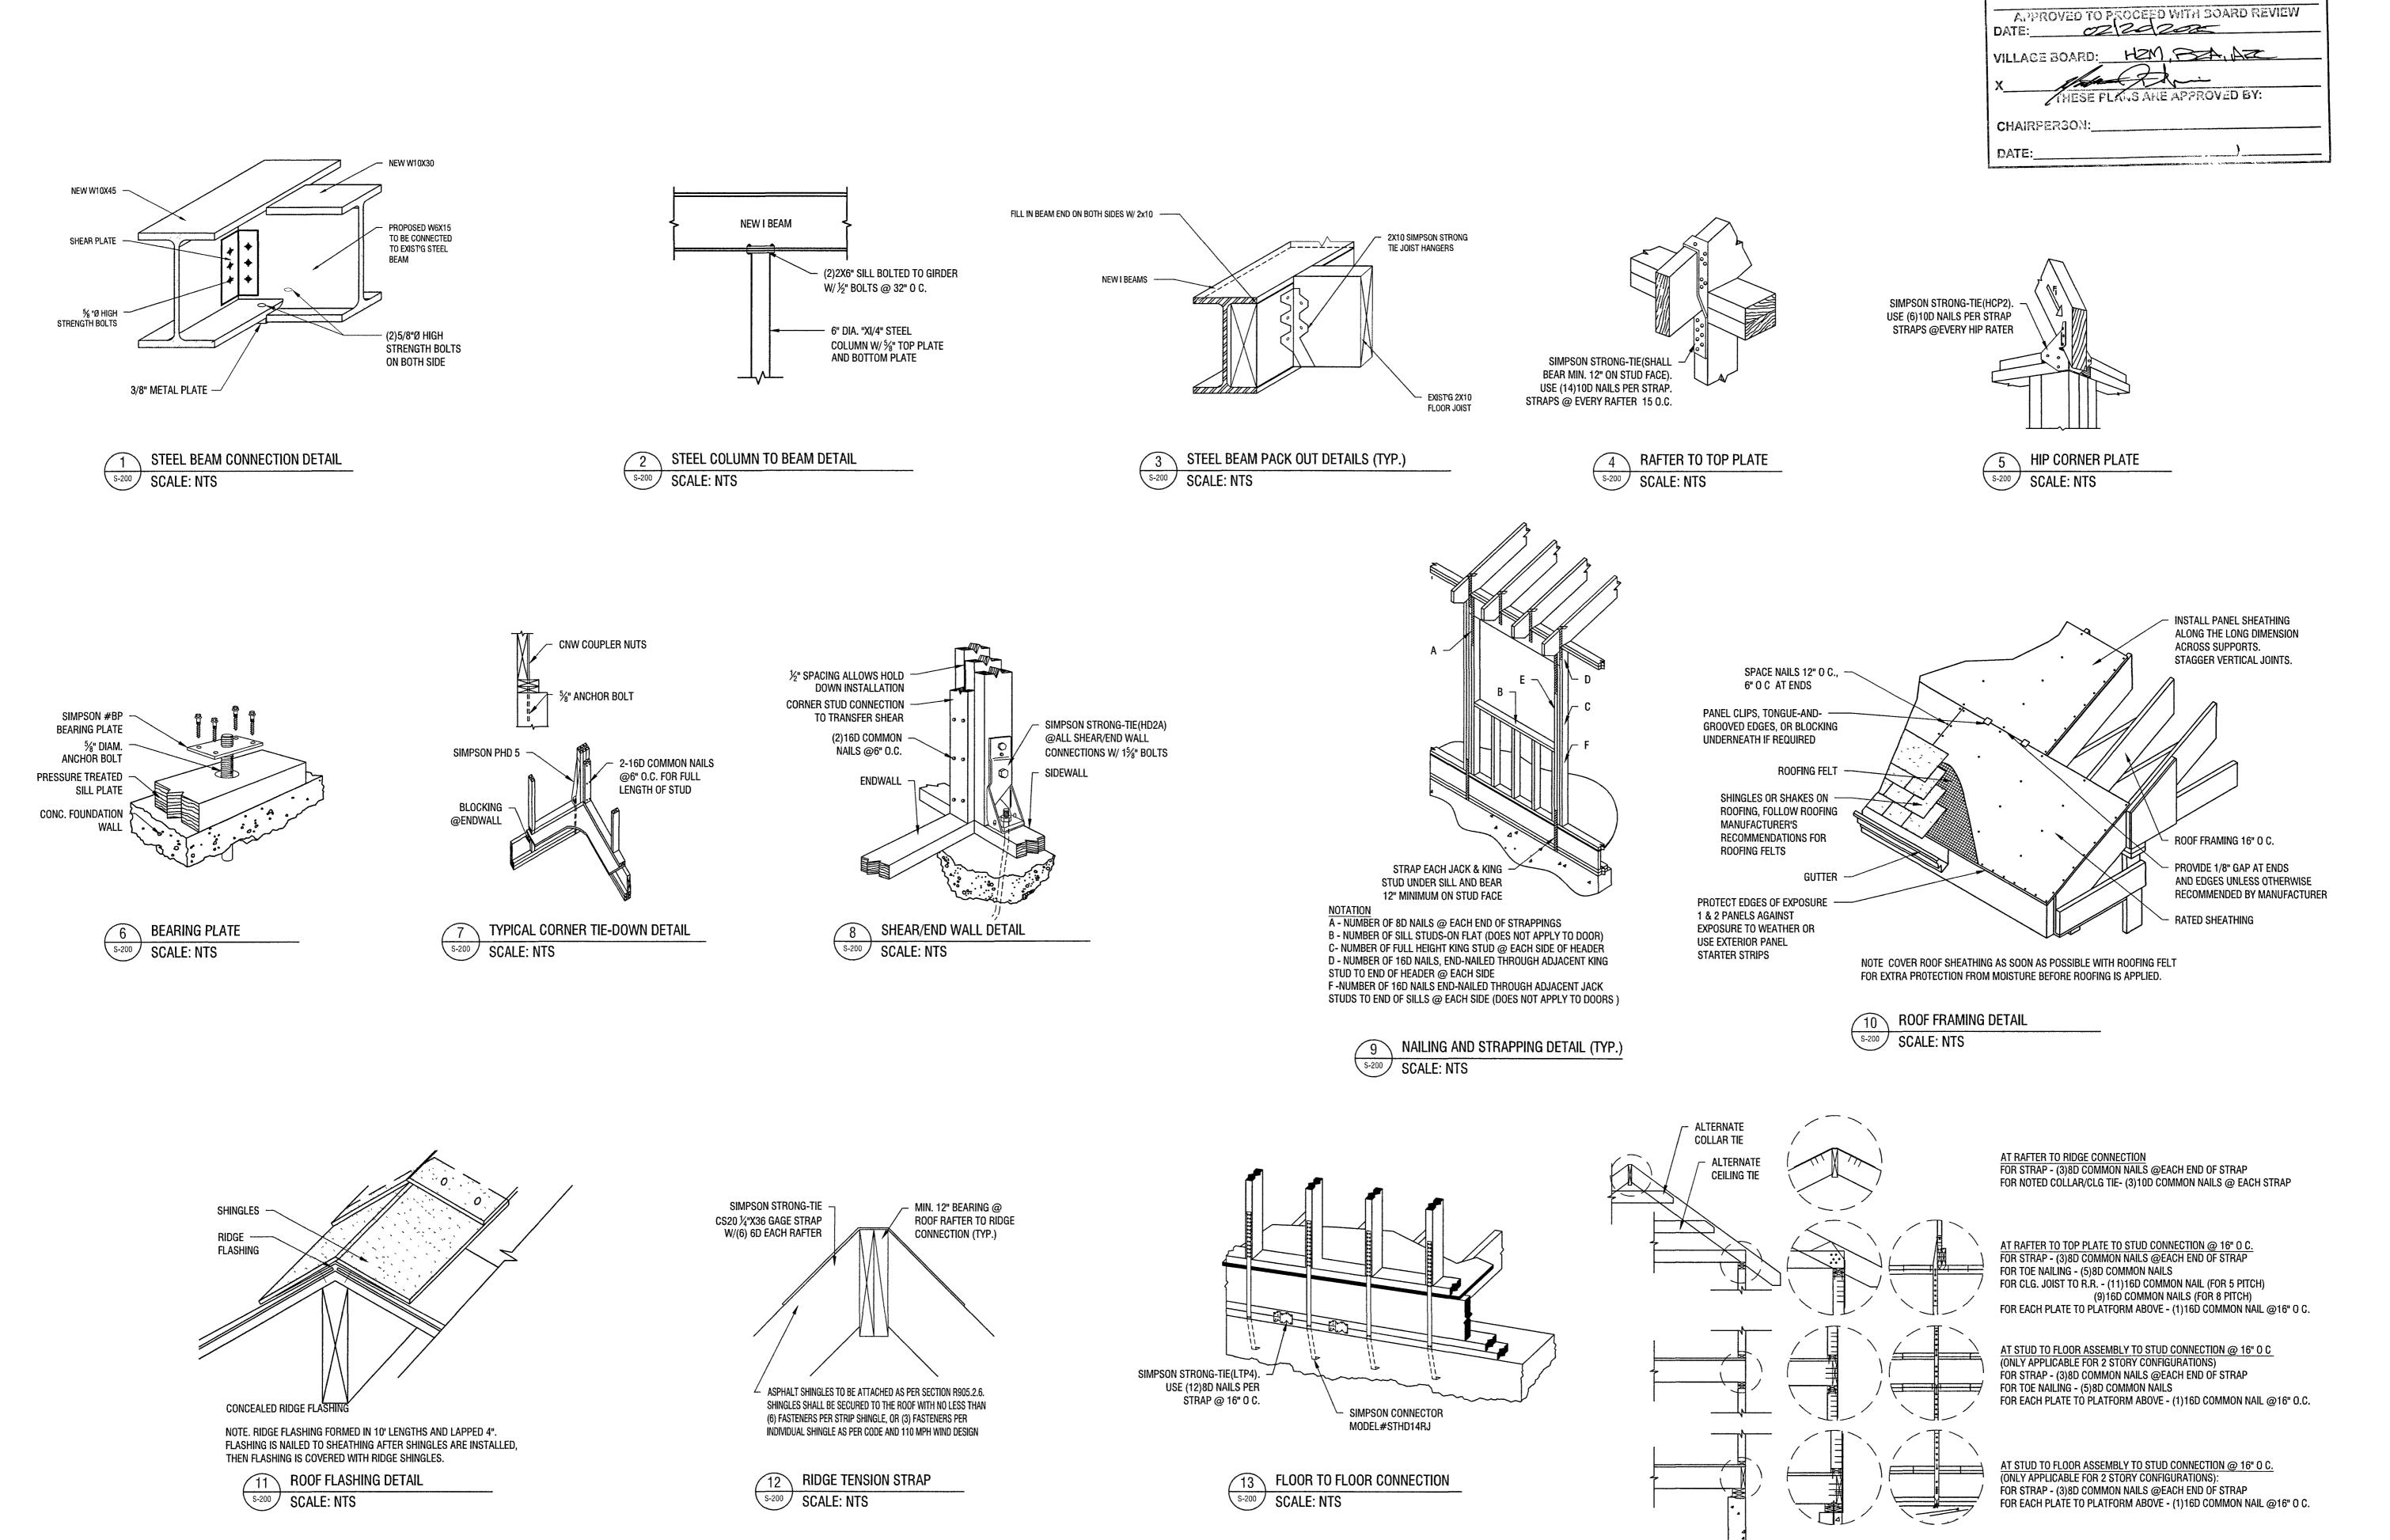VILLAGE OF GREAT NECK BUILDING DEPARTMENT

14 EXTERIOR WALL SECTION CALL OUT

S-200 SCALE: NTS

SHING, NY 11354

ST18-799-0901

@HTASSOCIATES.NET

HTA

01.30 25 36-09 MAIN STREE FLUSHING, NY T: 718-799-E: INFO@HTASSO

1 COMMENTS REVISION ISSUED 01.30 28

DAVID'S RESIDENCE

105 MAPLE ST GREAT NECK, NY 11023 SECTION: 1, BLOCK: 189, LOT: 3

10 GREAT

DRAWING TITLE:

STRUCTURAL DETAILS

S-200.00

PAGE: 19 OF 23

DATE ISSUED: 2/15/2025

DATE CREATED: 01/24/2024

SCALE: AS NOTED

SCALE: AS NOTE

DRAWN BY: LY

CHECKED BY: KY FU

JOB #: 24036

SEAL & SIGNATURE:

VILLAGE OF GREAT WELL BUILDING DEPARTMENT

FEB 19 2023

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2020 NEW YORK STATE ENERGY CONSERVATION CODE BUILDING TYPE: RESIDENTIAL BUILDING CLIMATE ZONE: 4 [ECC FIGURE 301.1] SCOPE OF PROJECT

THE PROJECT SHALL COMPLY WITH THE REQUIREMENTS OF THE 2020 NYSECC AND 1 RCNY §5000-01 "CONSTRUCTION APPROVAL REQUIREMENTS FOR COMPLIANCE WITH THE NEW YORK CITY ENERGY CONSERVATION CODE", AND OTHER APPLICABLE RULES AND REGULATIONS.

2020 NYSECC COMPLIANCE STATEMENT

TO THE BEST OF MY KNOWLEDGE, BELIEF AND PROFESSIONAL JUDGMENT, THESE PLANS AND SPECIFICATIONS ARE IN COMPLIANCE WITH THE 2020 NEW YORK STATE ENERGY CONSERVATION CODE, USING CHAPTER R4.

ENERGY GENERAL NOTES

ALL REQUIRED PROGRESS INSPECTIONS FOR THIS PROJECT SHALL BE PERFORMED BY A PROGRESS INSPECTOR AND/OR A PROGRESS INSPECTION AGENCY MEETING THE QUALIFICATION REQUIRED BY 1 RCNY §101-07(c)(3) FOR THE CATEGORY "ENERGY CODE COMPLIANCE FOR "RESIDENTIAL BUILDINGS.

- 1. THE PRIMARY INSPECTOR, OR INSPECTOR SUPERVISOR SHALL BE, EITHER
- THE REGISTERED DESIGN PROFESSIONAL OF RECORD FOR THE RESPECTIVE WORK, OR
- A REGISTERED DESIGN PROFESSIONAL WITH 5 YEARS EXPERIENCE IN THE DESIGN, CONSTRUCTION, CONSTRUCTION OBSERVATION AND/OR INSPECTION OF ENERGY CODE-REGULATED SYSTEMS FOR BUILDINGS.
- 2. A SUPPLEMENTAL INSPECTOR (UNDER THE DIRECT SUPERVISION OF AN INSPECTION SUPERVISOR), SHALL BE A PERSONS WITH 3 YEARS EXPERIENCE IN THE INSPECTION OR CONSTRUCTION OBSERVATION OF THE SYSTEMS TYPE(S) FOR ENERGY-REGULATED SYSTEMS IN COMMERCIAL BUILDINGS FOR WHICH HE/SHE PERFORMS PROGRESS INSPECTIONS.

WHERE PROGRESS INSPECTIONS ARE INDICATED IN THE CONTRACT DOCUMENTS AS OWNER'S RESPONSIBILITY, THE OWNER WILL ENGAGE A PROGRESS INSPECTOR, TO PERFORM THE REQUIRED SERVICES.

WHERE TESTS AND INSPECTIONS ARE NOT EXPLICITLY INDICATED AS THE CITY OF NEW YORK'S RESPONSIBILITY, OR WHERE TESTS AND INSPECTIONS ARE REQUIRED BUT NOT SPECIFICALLY LISTED, THE CONTRACTOR SHALL ENGAGE AN APPROVED PROGRESS INSPECTION AGENCY OR PROGRESS INSPECTOR, AS APPLICABLE, TO PERFORM THE REQUIRED SERVICES.

CONTRACTOR SHALL NOTIFY THE COMMISSIONER AND RELEVANT INSPECTING PARTY AT LEAST 72 HOURS IN ADVANCE OF TIME WHEN WORK THAT REQUIRES INSPECTION WILL BE PERFORMED.

WHERE ANY WORK OR INSTALLATION DOES NOT PASS AN INITIAL TEST OR INSPECTION, THE CONSTRUCTION SHALL BE CORRECTED, AND MUST BE MADE AVAILABLE FOR RE-INSPECTION AND/OR RE-TESTING BY THE PROGRESS INSPECTOR UNTIL IT COMPLIES AS PER ECC 104.2.3.

VERIFICATIONS BY PROGRESS INSPECTOR IN ADDITION TO ALL OTHER ITEMS REQUIRED TO BE INSPECTED IN ACCORDANCE WITH APPLICABLE LAWS AND RULES, THE PROGRESS INSPECTOR SHALL VERIFY THE FOLLOWING


- 1. COMPLETION OF RELATED SPECIAL INSPECTIONS. THE PROGRESS INSPECTION AGENCY'S PERFORMANCE OF A PROGRESS INSPECTION SHALL INCLUDE VERIFICATION THAT ANY SPECIAL INSPECTIONS THAT WERE REQUIRED TO HAVE BEEN CONDUCTED PRIOR TO THE PROGRESS INSPECTION HAVE BEEN DOCUMENTED AS COMPLETED.
- UPDATE APPROVED DOCUMENTS. PRIOR TO PERFORMING A PROGRESS INSPECTION, THE PROGRESS INSPECTION AGENCY SHALL VERIFY THAT THE RELEVANT APPROVED CONSTRUCTION DOCUMENTS, FOR THE PURPOSE OF THE PROGRESS INSPECTION, REPRESENT THE BUILT CONDITIONS IF CHANGES ARE REQUIRED IN THE APPROVED CONSTRUCTION DOCUMENTS FOR THE PURPOSE OF THE PROGRESS INSPECTION, THE PROGRESS INSPECTOR SHALL WAIT TO PERFORM THE INSPECTIONS UNTIL THE UPDATED CONSTRUCTION DOCUMENTS HAVE BEEN APPROVED, INCLUDING THE ENERGY ANALYSIS, WHERE APPLICABLE
- ENERGY CODE VERIFICATIONS. PROGRESS INSPECTORS FOR ENERGY CODE COMPLIANCE SHALL PERFORM INSPECTIONS IN ACCORDANCE WITH THE FOLLOWING
 SAMPLING UNLESS NOTED OTHERWISE IN THE INSPECTION/TEST COLUMNS OF TABLE II OF 1 RCNY §5000-01(h), REQUIRED INSPECTIONS OR TESTS SHALL BE PERFORMED ON NOT LESS THAN 15% OF EACH RELEVANT CONSTRUCTION ITEM IN THE SCOPE OF WORK AS LISTED IN THE APPLICABLE TABLE, AND ON NOT LESS THAN ONE OF EACH TYPE WHERE APPLICABLE SELECTION OF SUCH SAMPLE CONSTRUCTION SHALL BE AT THE SOLE DISCRETION OF THE PROGRESS INSPECTOR. NOTHING IN THIS ITEM SHALL PREVENT THE PROGRESS INSPECTOR FROM DETERMINING THAT, IN HIS OR HER PROFESSIONAL JUDGMENT, MORE THAN 15% OF A GIVEN TYPE OF CONSTRUCTION ITEM SHALL BE INSPECTED.
- PHASED INSPECTION FOR TEMPORARY CERTIFICATES OF OCCUPANCY. PRIOR TO ISSUANCE OF A TEMPORARY CERTIFICATE OF OCCUPANCY FOR LESS THAN THE
 TOTAL SCOPE OF WORK, INSPECTION SHALL BE REQUIRED FOR ALL WORK SERVING THE PORTION OF THE BUILDING FOR WHICH THE TEMPORARY CERTIFICATE OF
 OCCUPANCY IS TO BE ISSUED. WHERE A PRACTICAL DIFFICULTY FOR SOME INSPECTIONS IS DEMONSTRATED TO THE COMMISSIONER, THE COMMISSIONER MAY
 GRANT A WAIVER OF THOSE INSPECTIONS FOR A SPECIFIED TIME OR UNTIL FINAL INSPECTION FOR THE FINAL CERTIFICATE OF OCCUPANCY.

AN OPERATING AND MAINTENANCE MANUAL IS TO BE PROVIDED TO BUILDING OWNER BY THE MECHANICAL CONTRACTOR.

	ENERGY DESCRIPTIVE NOTES					
	ECC CITATION	DESCRIPTION	NOTES			
1	R402.4.1.2	AIR LEAKAGE TESTING	TESTING SHALL BE PERFORMED AND NOT EXCEED 3 ACH.			
2	R402 4	ROOM CONTAINING	MINIMUM R-10 INSULATION IS PROVIDED AT TENANT SEPARATION WALLS AND FLOORS			
3	R402.4.4 FUEL-BURNING APPLIANCES		ALL WALLS, CEILINGS, DOORS, WATER LINES AND DUCTS INTO THE UNCONDITIONED ROOM WILL BE FULLY GASKETED AND INSULATED.			
4	R402.4.6	TENANT SEPARATION WALLS	MAINTENANCE INSTRUCTIONS SHALL BE FURNISHED FOR EQUIPMENT AND SYSTEMS THAT REQUIRE PREVENTIVE MAINTENANCE REQUIRED REGULAR MAINTENANCE ACTIONS SHALL BE CLEARLY STATED AND INCORPORATED ON A READILY ACCESSIBLE LABEL. THE LABEL SHALL INCLUDE THE TITLE OR PUBLICATION NUMBER FOR THE OPERATION AND MAINTENANCE MANUAL FOR THAT PARTICULAR MODEL AND TYPE OF PRODUCT.			
			PROPOSE EACH HEATING AND COOLING SYSTEM WITHIN THE ZONE TO BE CONTROLLED BY INDIVIDUAL THERMOSTATIC CONTROL.			
			PROPOSE THERMOSTATIC CONTROLS TO HAVE A SET POINT OVERLAP RESTRICTION WHICH PROVIDES A TEMPERATURE RANGE OR DEADBAND OF AT LEAST 5°F.			
5	R403.1	THERMOSTAT	PROPOSE EACH ZONE TO HAVE A THERMOSTATIC SETBACK CONTROL THAT IS CONTROLLED BY A PROGRAMMABLE CONTROL SYSTEM DURING OFF-HOURS.			
			PROPOSE THERMOSTATIC SETBACK CONTROLS TO HAVE THE CAPABILITY TO SET BACK OR TEMPORARILY OPERATE THE SYSTEM TO MAINTAIN ZONE TEMPERATURES DOWN TO 55°F OR UP TO 85°F.			
			PROPOSE A PROGRAMMABLE CONTROL TO BE CAPABLE OF STARTING AND STOPPING THE SYSTEM FOR SEVEN DIFFERENT DAILY SCHEDULES PER WEEK AND RETAINING THEIR PROGRAMMING AND TIME SETTING DURING A LOSS OF POWER FOR AT LEAST 10 HOURS			
6	R403 2	OUTDOOR TEMPERATURE SETBACK	HOT WATER BOILERS THAT SUPPLY HEAT TO THE BUILDING THROUGH ONE- OR TWO-PIPE HEATING SYSTEM SHALL HAVE AN OUTDOOR SETBACK CONTROL THAT DECREASES THE BOILER WATER TEMPERATURE BASES ON THE OUTDOOR TEMPERATURE.			
7	R403.5	SERVICE HOT WATER SUPPLYING PIPING	MAXIMUM 32'-0" LENGTH PIPE METHOD TO BE USED WITH NO CIRCULATION PUMP OR HEAT TRACE.			
8	R403 6	VENTILATION DESIGN	ALL VENTILATION DESIGN SHALL HAVE OUTDOOR AIR INTAKES AND EXHAUSTS WITH AUTOMATIC OR GRAVI DAMPERS THAT CLOSES WHEN THE VENTILATION SYSTEM IS NOT OPERATING.			
9	R403.6 2	VENTILATION CONTROL & EFFICIENCY	HEAT RECOVERY VENTILATOR WILL BE USED TO CONTROL THE BALANCED VENTILATION OF SUPPLY AND EXHAUST IN THE HOUSE. A BALANCED VENTILATION SYSTEM SHALL HAVE THE EQUAL AMOUNT CFM ON INTAKE AND EXHAUST.			
10	R403.7	EQUIPMENT SIZING AND EFFICIENCY RATING	THE EQUIPMENT HAS BEEN SIZED REFERENCING ACCA MANUAL J AND MANUAL S.			
			NOT LESS THAN 90 PERCENT OF THE PERMANENTLY INSTALLED LIGHTING FIXTURES SHALL USE LAMPS WIT AN EFFICACY OF AT LEAST 65 LUMENS PER WATT, OR HAVE A TOTAL LUMINAIRE EFFICACY OF AT LEAST 45 LUMENS PER WATT.			
11	R404.1	DWELLING UNIT LIGHTING	R402.4.5 ALL RECESSED LIGHTING IN THE ROOF CEILING ASSEMBLY IS SEALED TO ALLOW NO MORE THAN 2 CFM AIR LEAKAGE AND SEALED W/ A GASKET OR CAULK.			
			FUEL GAS LIGHTING SYSTEMS SHALL NOT HAVE CONTINUOUSLY BURNING PILOT LIGHTS			
12	R404.2	METERING	ONE ELECTRICAL METER WILL BE PROVIDED TO EACH INDIVIDUAL DWELLING UNIT AND COMMON AREA.			
13	R404.3	ELECTRICAL VEHICLE SERVICE EQUIPMENT CAPABLE	ONE OR TWO-FAMILY DWELLINGS AND TOWNHOUSES WITH PARKING AREA PROVIDED ON THE BUILDING SIT SHALL PROVIDE A 208/240V 40-amp OUTLET FOR EACH DWELLING UNIT OR PANEL CAPACITY AND CONDUIT FOR THE FUTURE INSTALLATION OF SUCH AN OUTLET. OUTLET OR CONDUIT TERMINATION SHALL BE ADJACENT TO THE PARKING AREA			

TABLE R403.5.5 PIPE VOLUME AND MAXIMUM PIPING LENGTHS MAXIMUM PIPE OR TUBE LENGTH				
NOMINAL PIPE OR TUBE SIZE (INCH)	VOLUME (LIQUID OUNCES PER FOOT LENGTH)	SYSTEM WITHOUT A CIRCULATION LOOP OR HEAT-TRACED LINE (FEET)	SYSTEM WITH A CIRCULATION LOOP OR HEAT-TRACED LINE (FEET)	LAVATORY FAUCETS - PUBLIC (METERING AND NON METERING) (FEET)
1/4	0 33	50	16	6
5/16	0 50	50	16	4
3/8	0.75	50	16	3
1/2	1.50	43	16	2
5/8	2.00	32	12	1
3/4	3.00	21	8	0.50
7/8	4.00	16	6	0.50
1	5.00	13	5	0 50
1 1/4	8 00	8	3	0.50
1 1/2	11 00	6	2	0.50
2 OR LARGER	18.00	4	1	0.50

NARRA	TIVE OF INTERIOR CONTROLS DESCRIBING FUNCTIONS AND OPERATION
DWELLING UNITS	LOCAL SWITCHES
STAIR	OCCUPANCY SENSOR, AUTOMATICALLY TURNS LIGHTS ON, WHEN MOTION IS DETECTED AND OFF WITH 20 MIN. OF ALL OCCUPANT LEAVING THE SPACE
LIVING/DINING	MANUAL LIGHTING CONTROL, MANUAL ON/ OFF
BEDROOM	MANUAL LIGHTING CONTROL, MANUAL ON/ OFF
TOILET	MANUAL LIGHTING CONTROL, MANUAL ON/ OFF
CELLAR/UTILITY ROOM /ACCESSORY AREA	OCCUPANCY SENSOR, AUTOMATICALLY TURNS LIGHTS ON, WHEN MOTION IS DETECTED AND OFF WITH 20 MIN. OF ALL OCCUPANT LEAVING THE SPACE
BULKHEAD /BUILDING ENTRANCE	PHOTO SENSOR AND/ OR AUTOMATIC TIMECLOCK

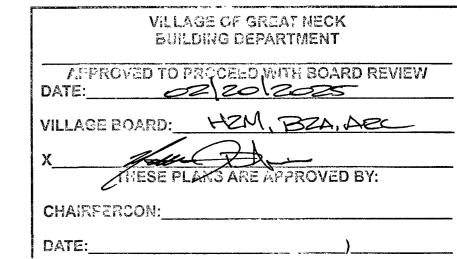


REVISION DATE

1 COMMENTS REVISION 01.30.25

36-09 MAIN STREET, 8

1 T. 714-79-9-098

E. INFO@HTASSOCIA

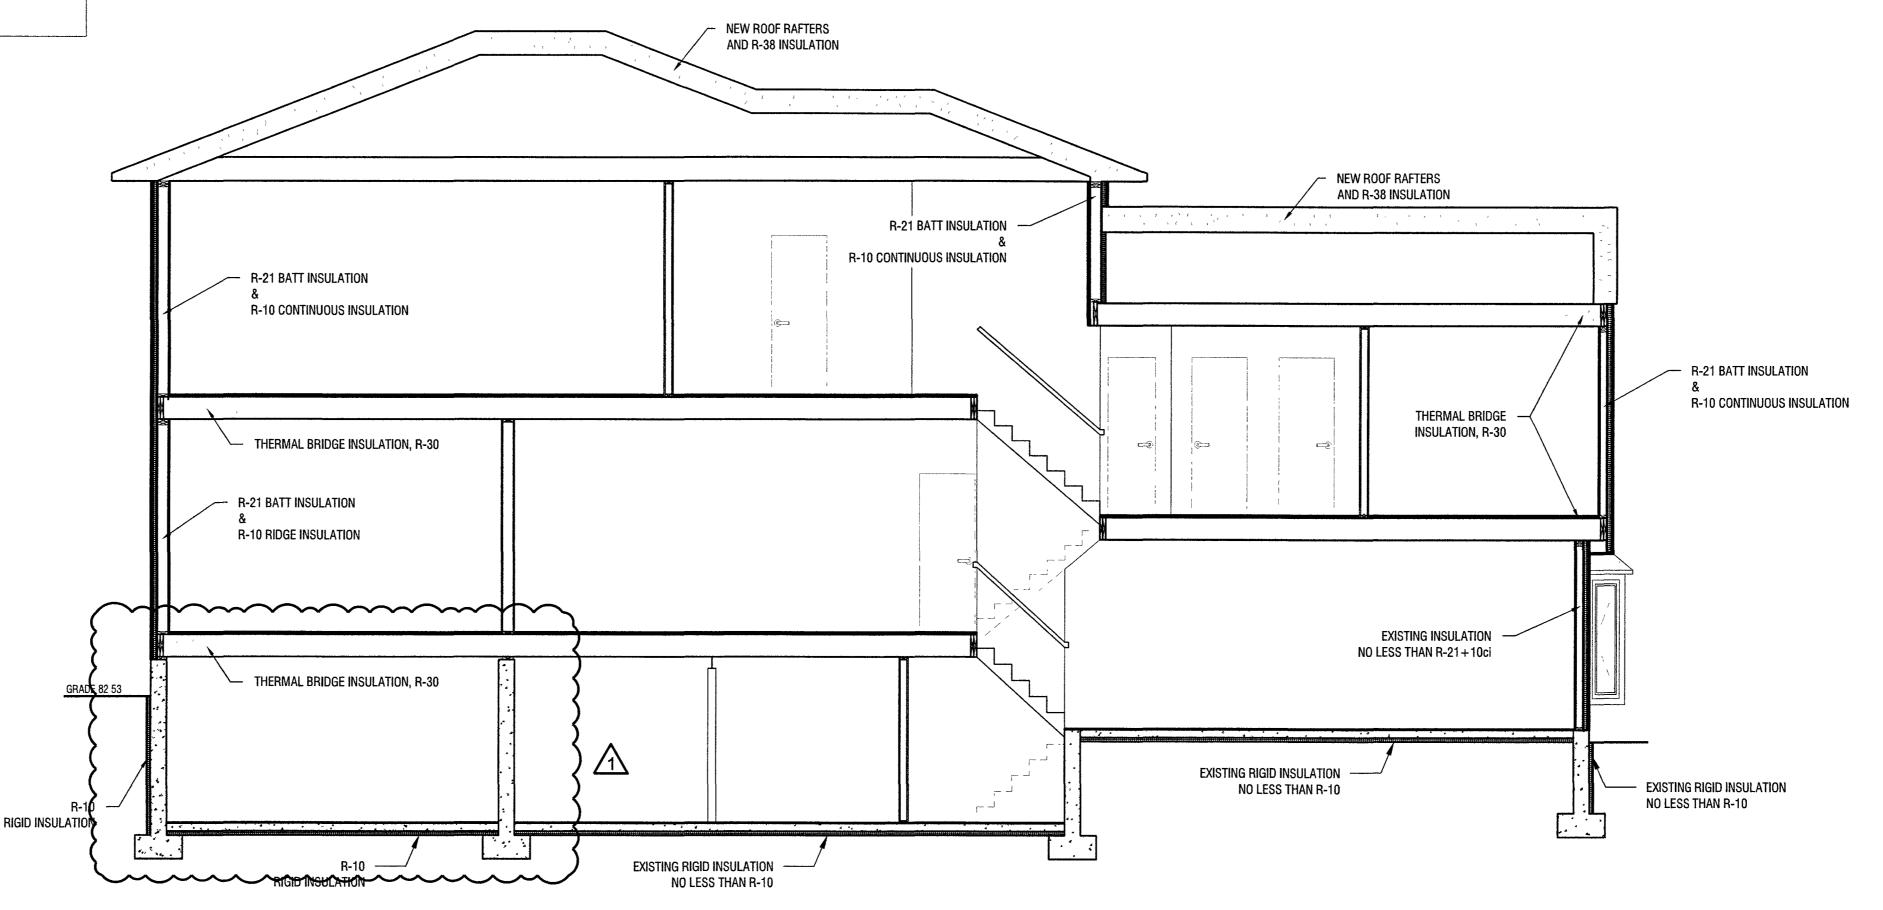

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VILLAGE OF GREAT NECK BUILDING DEPARTMENT FEB 19 2025

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ENERGY

ANALYSIS

EN-100.00

DATE ISSUED: 2/15/2025

DRAWN BY: CHECKED BY:

SEAL & SIGNATURE:


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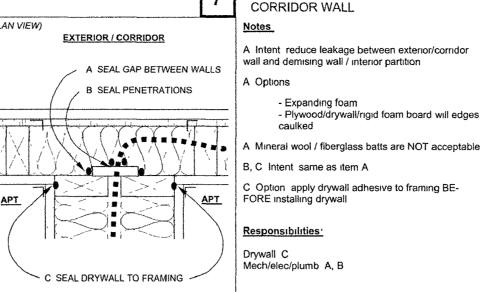
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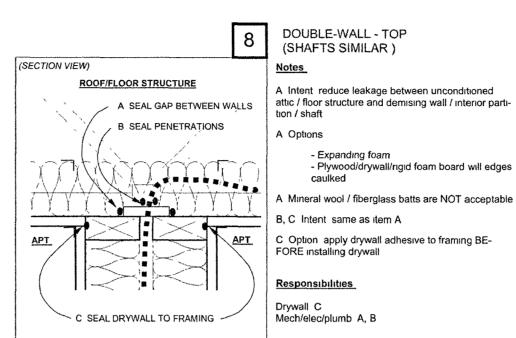
24036

BUILDING THERMAL BOUNDARY DIAGRAM
SCALE: N.T.S.






DOUBLE WALL AT EXTERIOR/

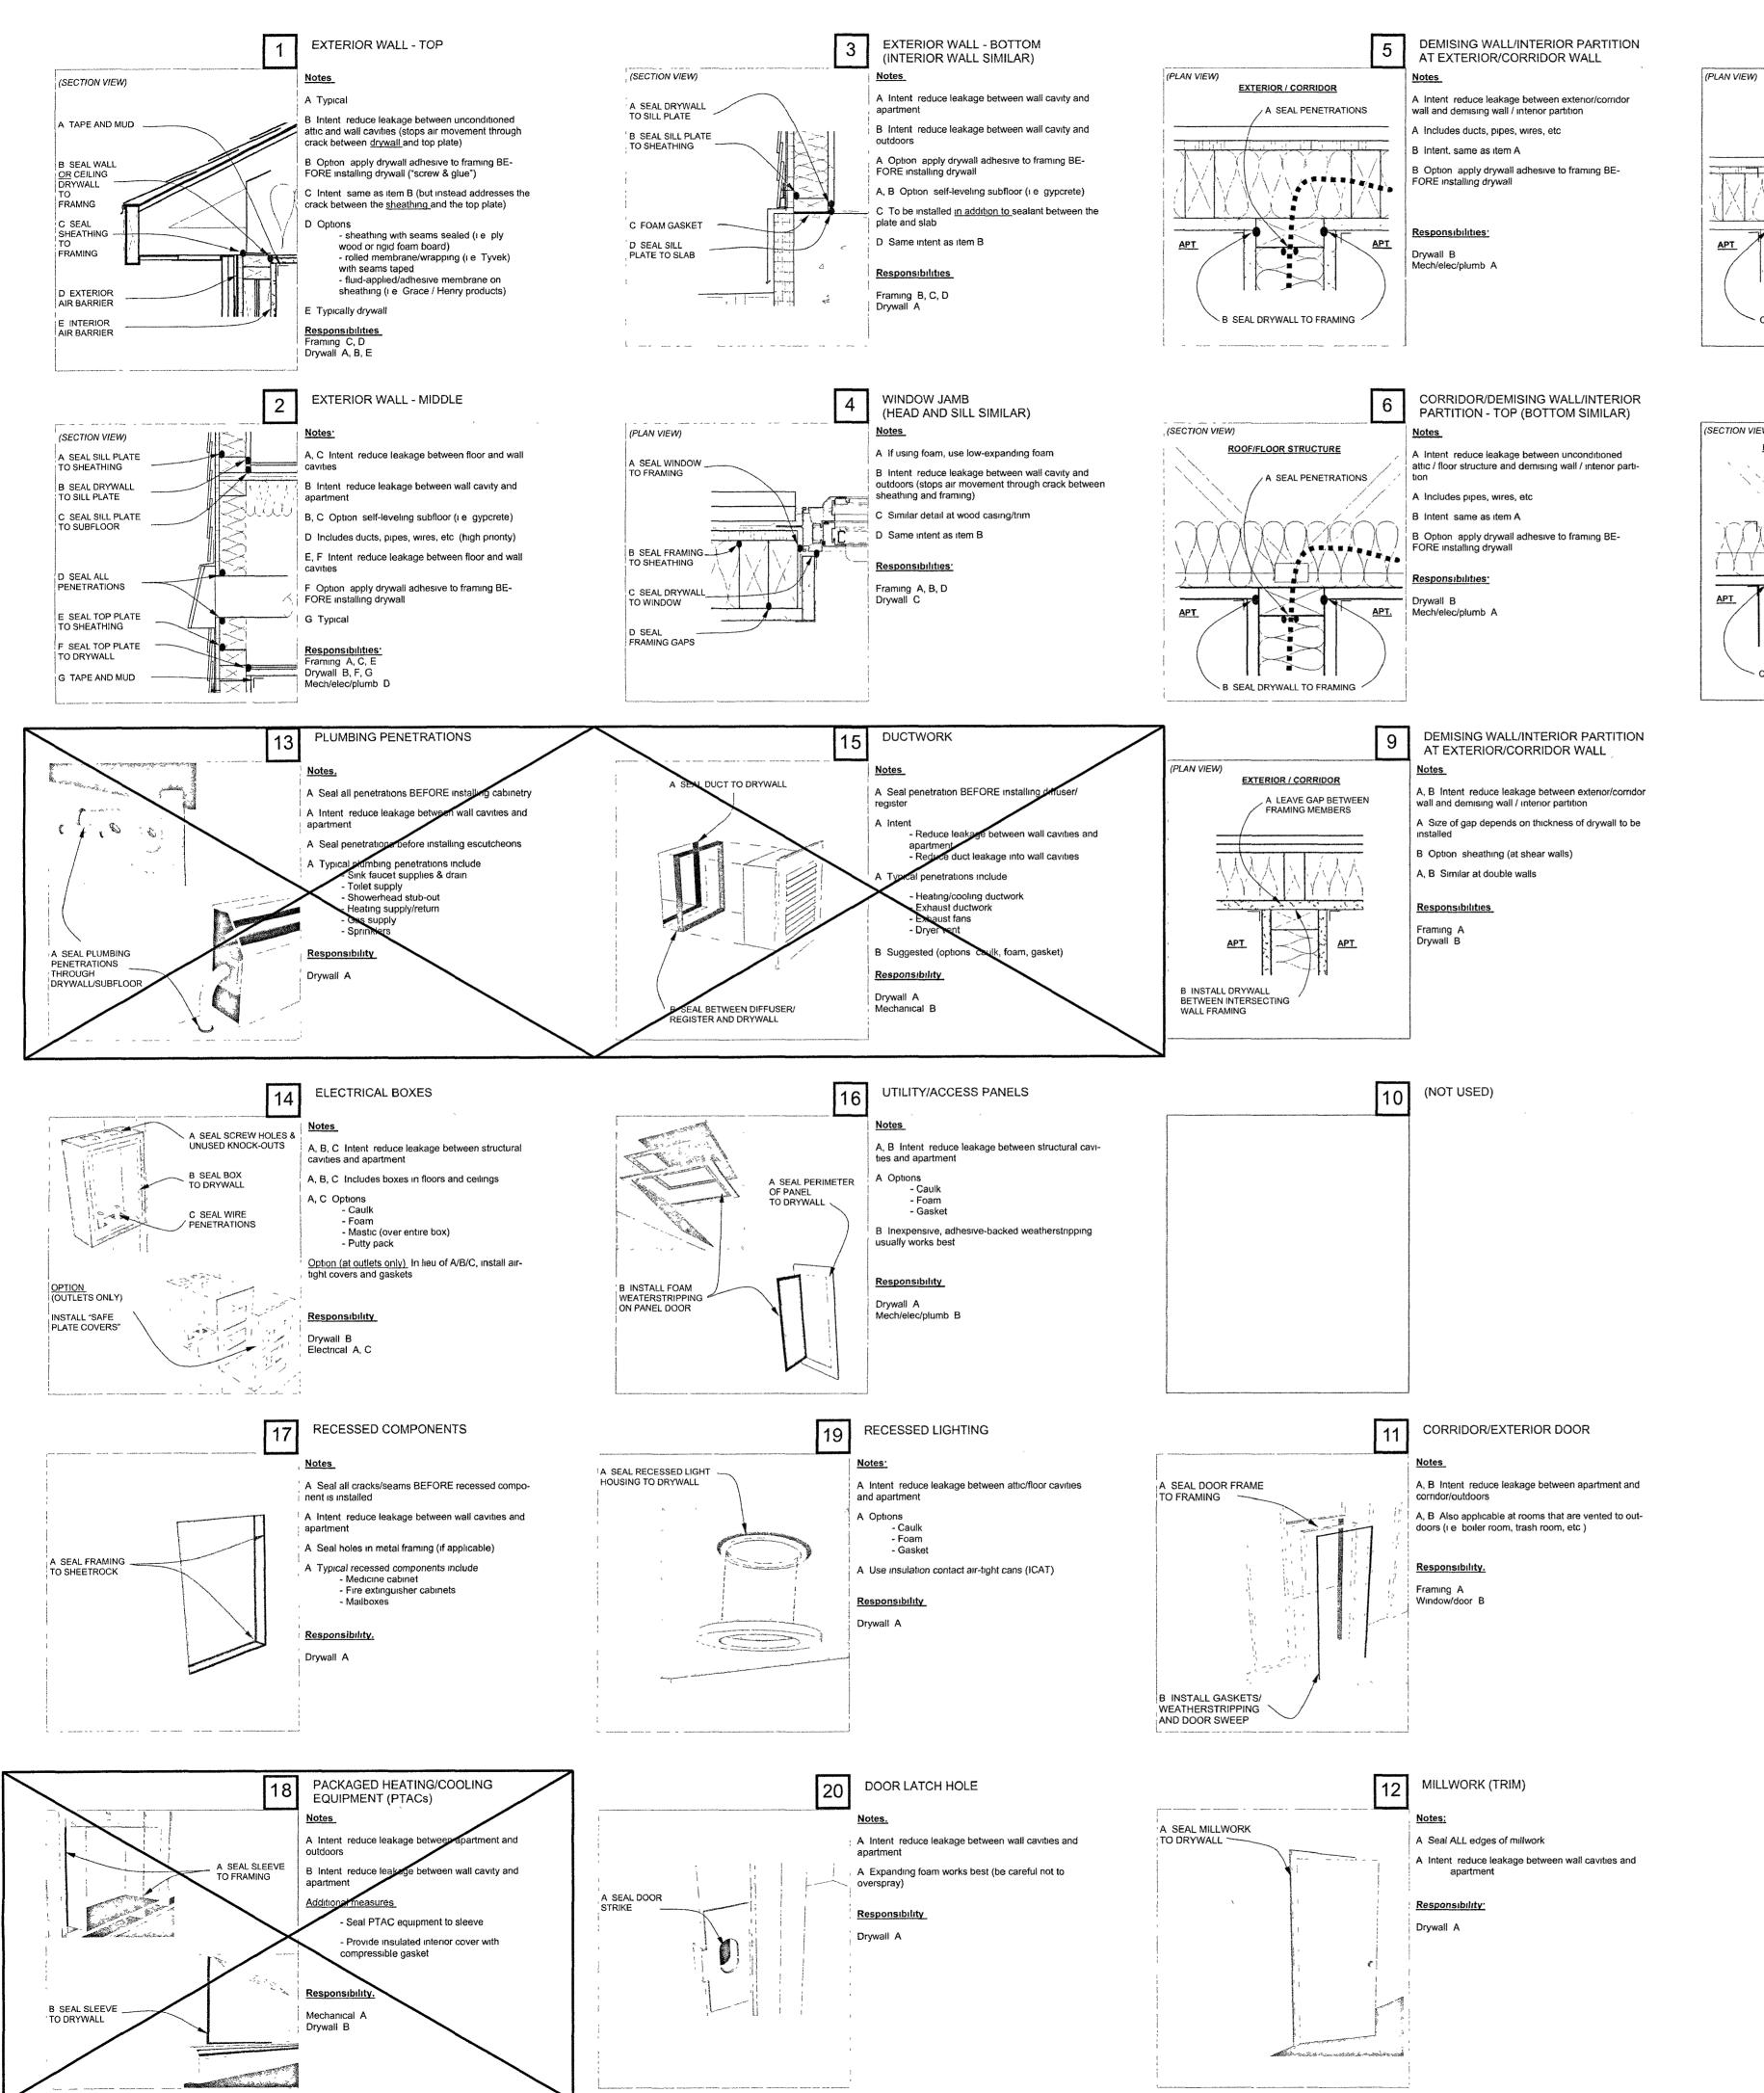

1 2 3 4 5 6 7 8 9 10 11 12 13 14 15 20 21 22 23 24 25 26 27 28 29 30 31 32

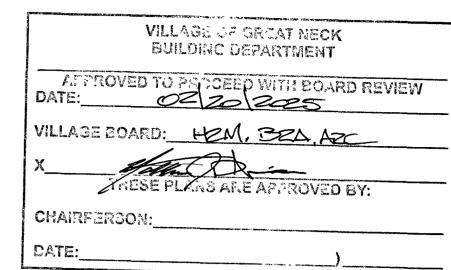


DATE	ISSUED 01 30.25	
REVISION	COMMENTS REVISION	
#	1	
CLIENT:		DAVID'S RESIDENCE
PROJECT ADDRESS:		105 MAPLE ST GREAT NECK, NY 11023 SECTION: 1, BLOCK: 189, LOT: 3
F	T NO.	LEAKAGE DETAILS
DATE SCAL DRAY CHEC JOB SEAL	CREA E: NN BY CKED E	AS NOTED LW SY: KY FU 24036 GNATURE:

VILLAGE OF GREAT NEUK BUILDING DEPARTMENT FEB 19 2025

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HTASSOCIATES

FLUSHING, NY 11354 T. 718-799-0901 IFO@HTASSOCIATES.NET
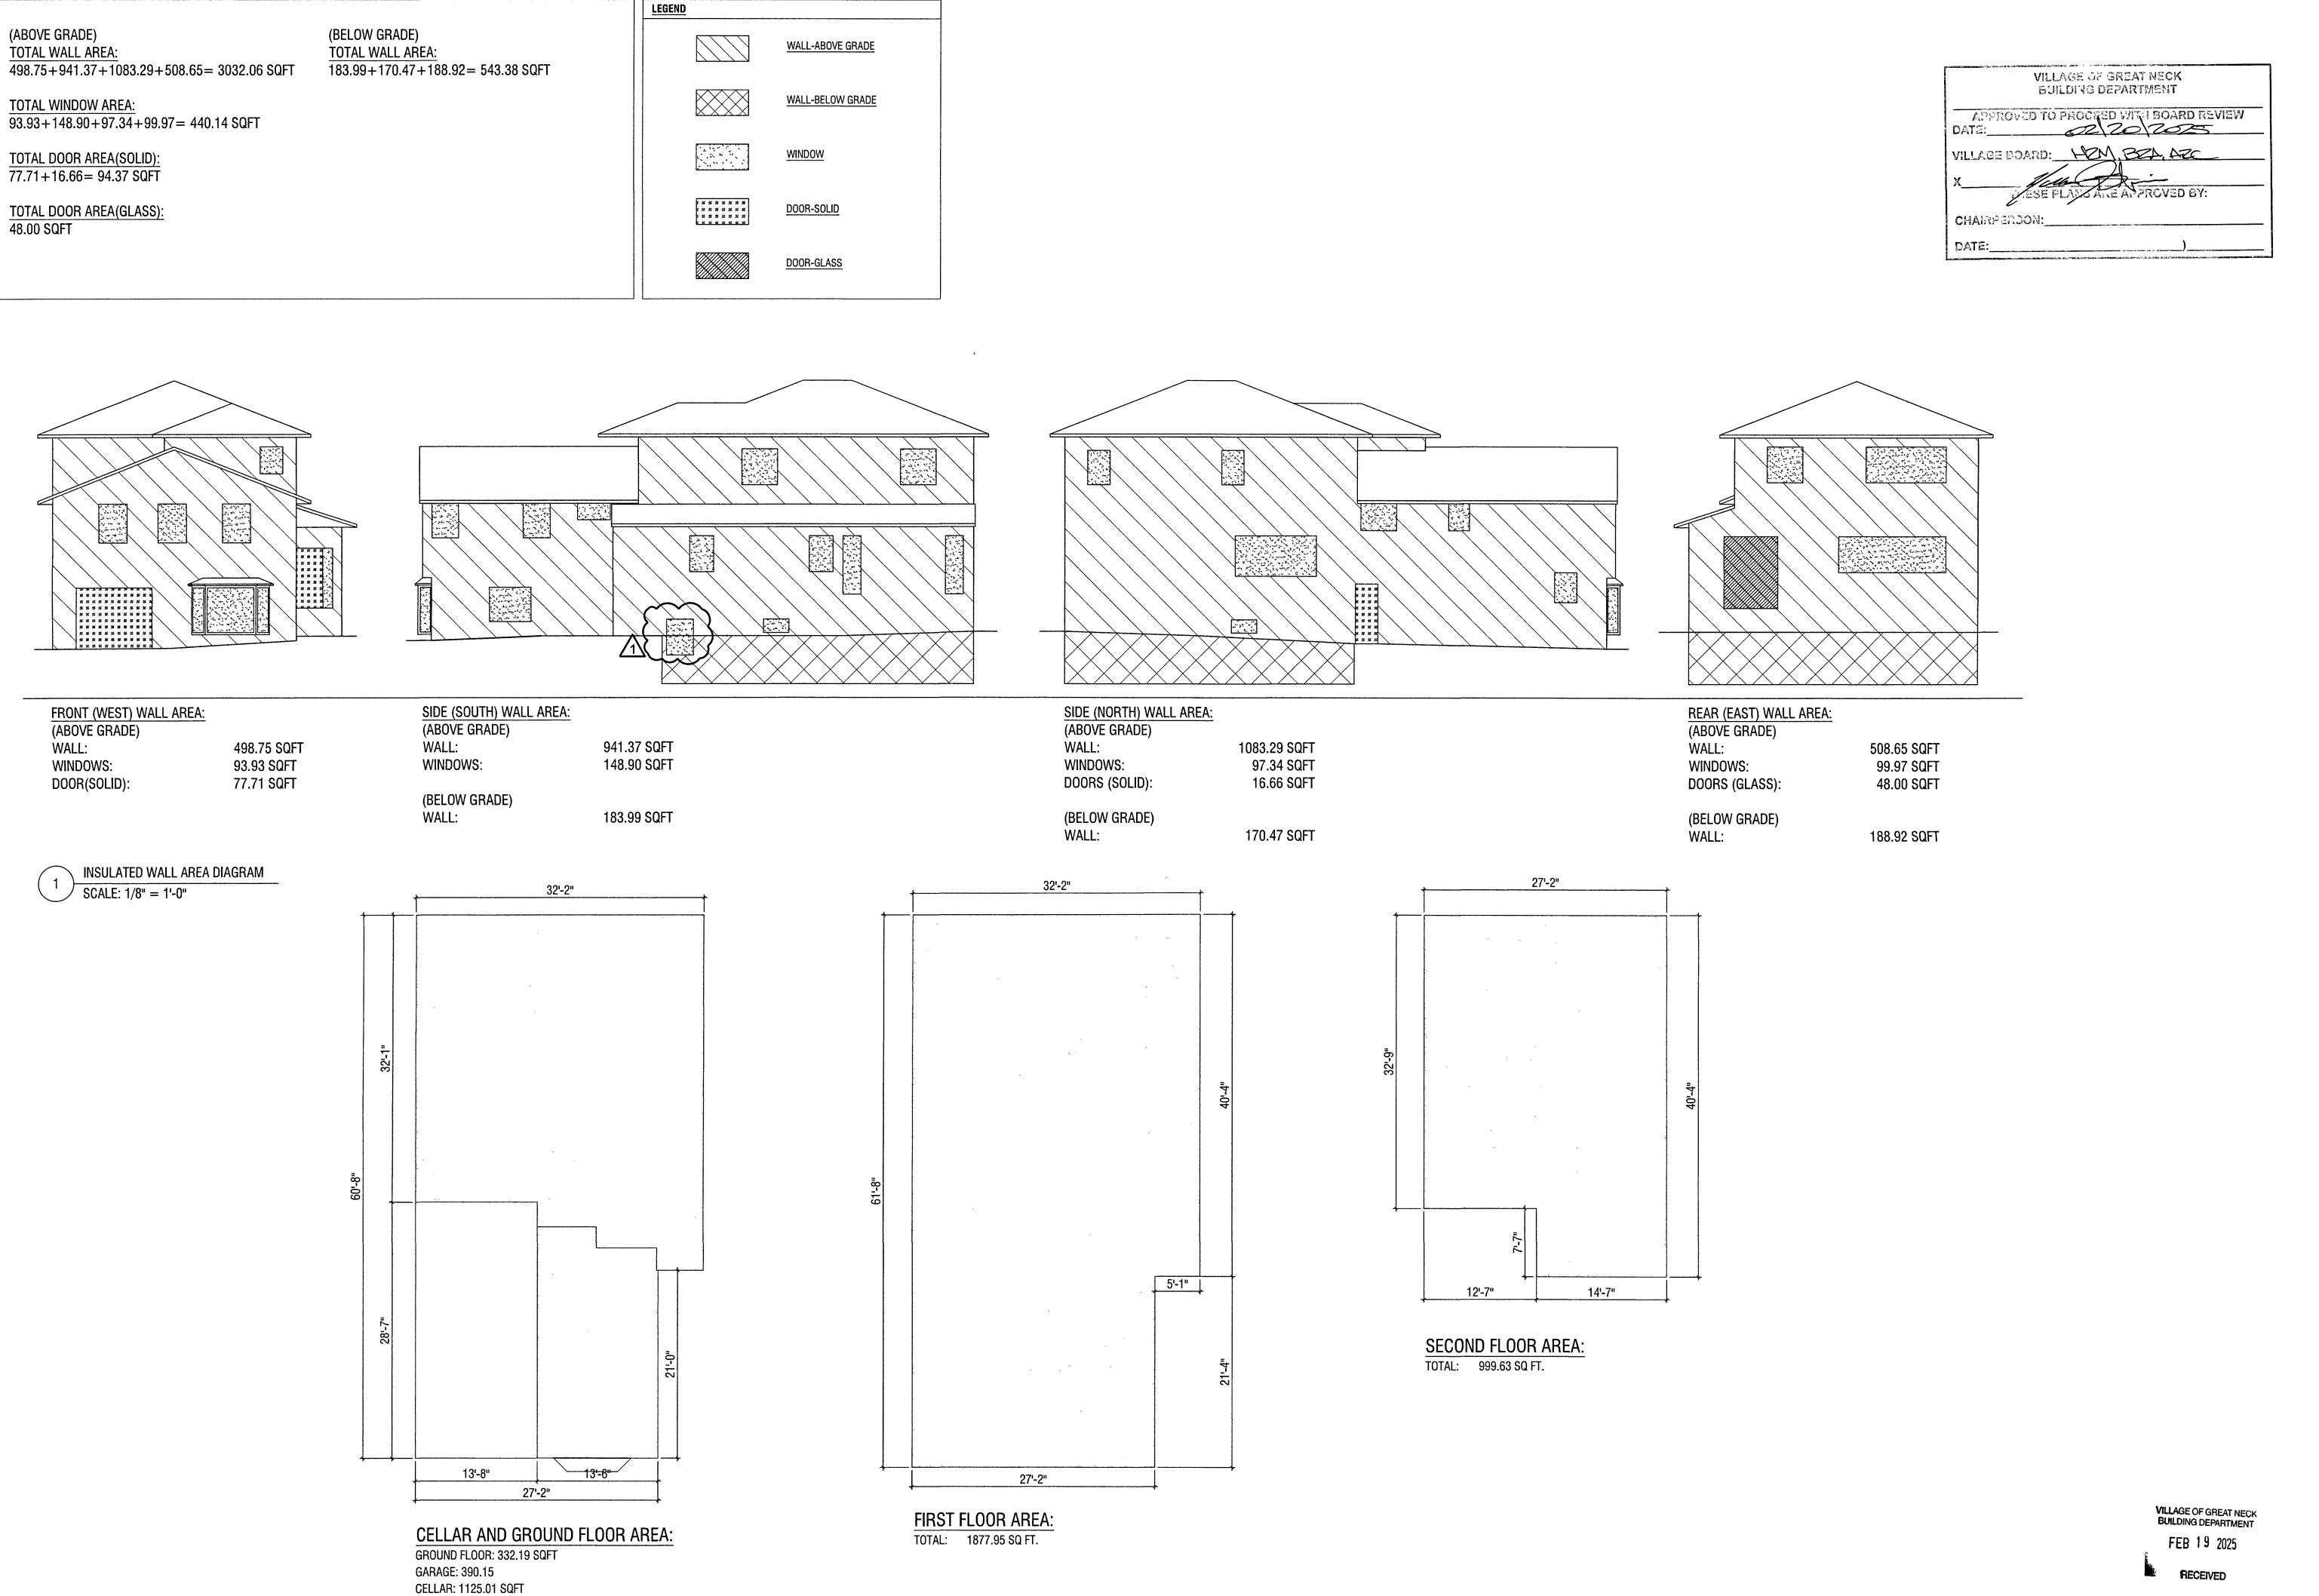
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MAPLE ST ECK, NY 11023


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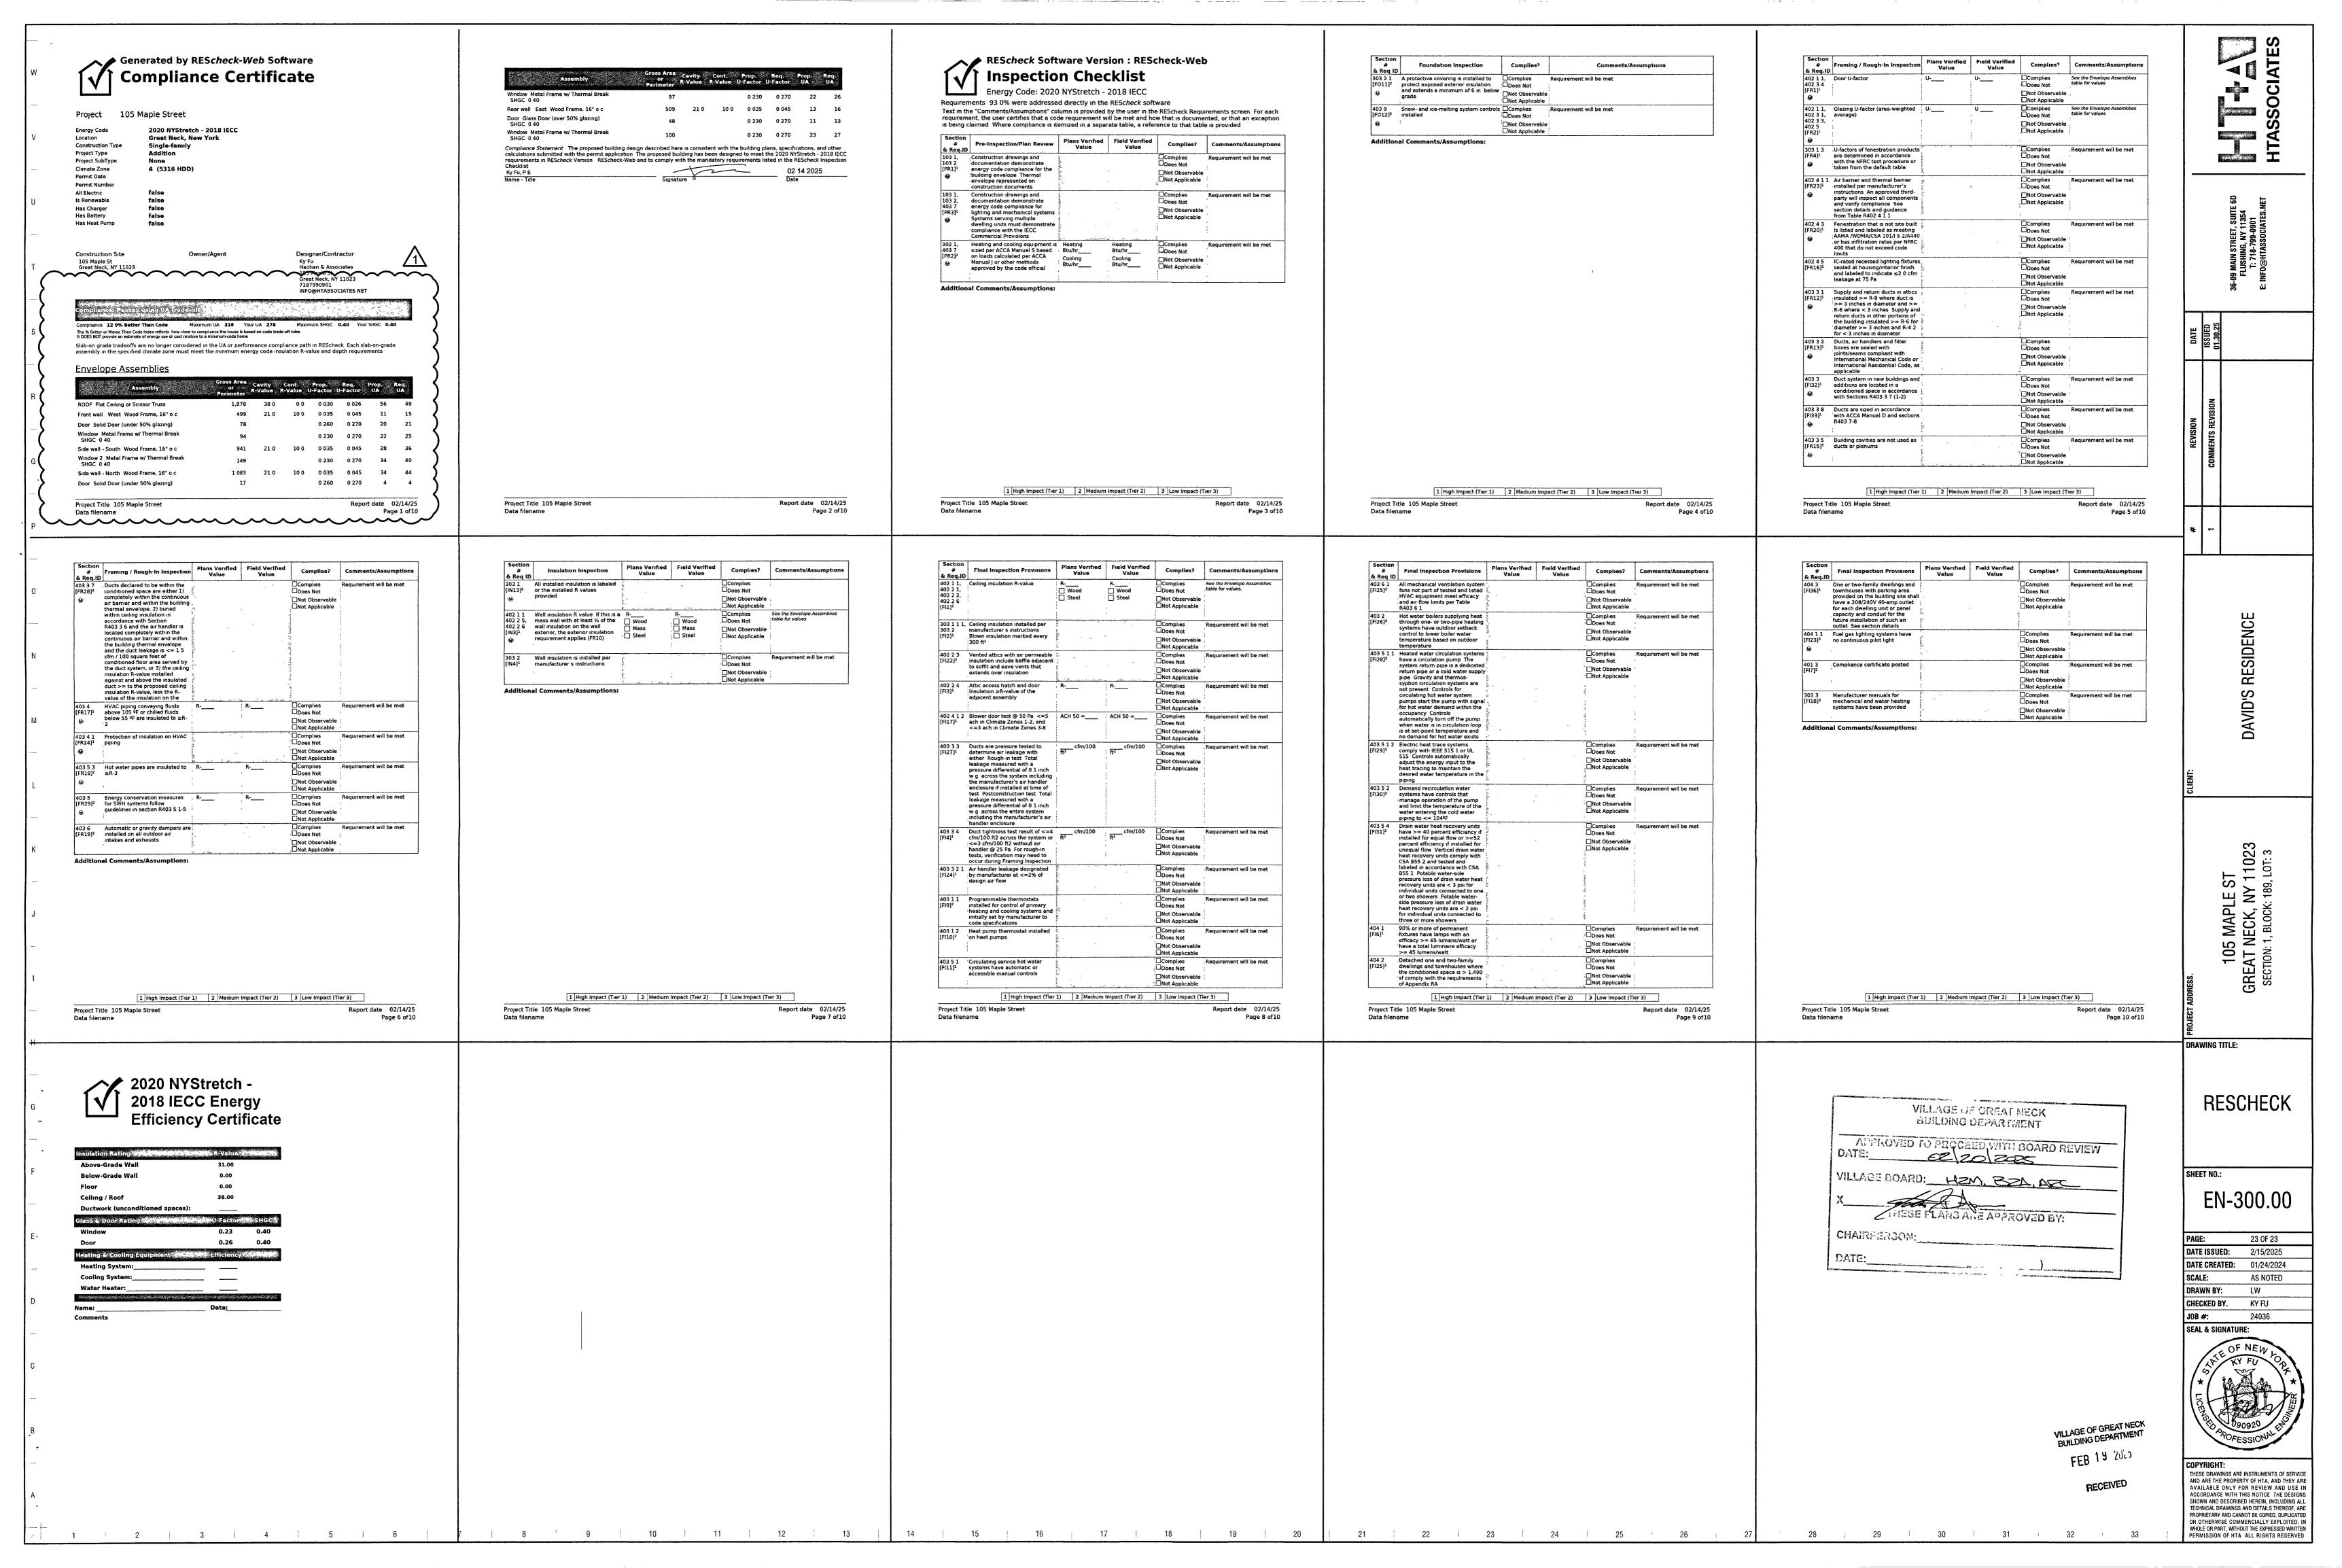
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PAGE:	22 OF 23
DATE ISSUED:	2/15/2025
DATE CREATED:	01/24/2024
SCALE:	AS NOTED
DRAWN BY:	LW
CHECKED BY:	KY FU
JOB #:	24036
SEAL & SIGNATU	RE:



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ITEM TITLE:

ARC CASE #25-5 41 STRATHMORE ROAD SECTION 1 BLOCK 203 LOT 66


SUBJECT:

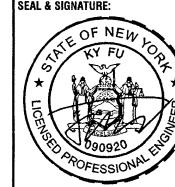Application for proposed exterior renovation, new stucco and brick finish. Proposed second floor addition.


ATTACHMENTS:


Description Type

□ PLANS Backup Material

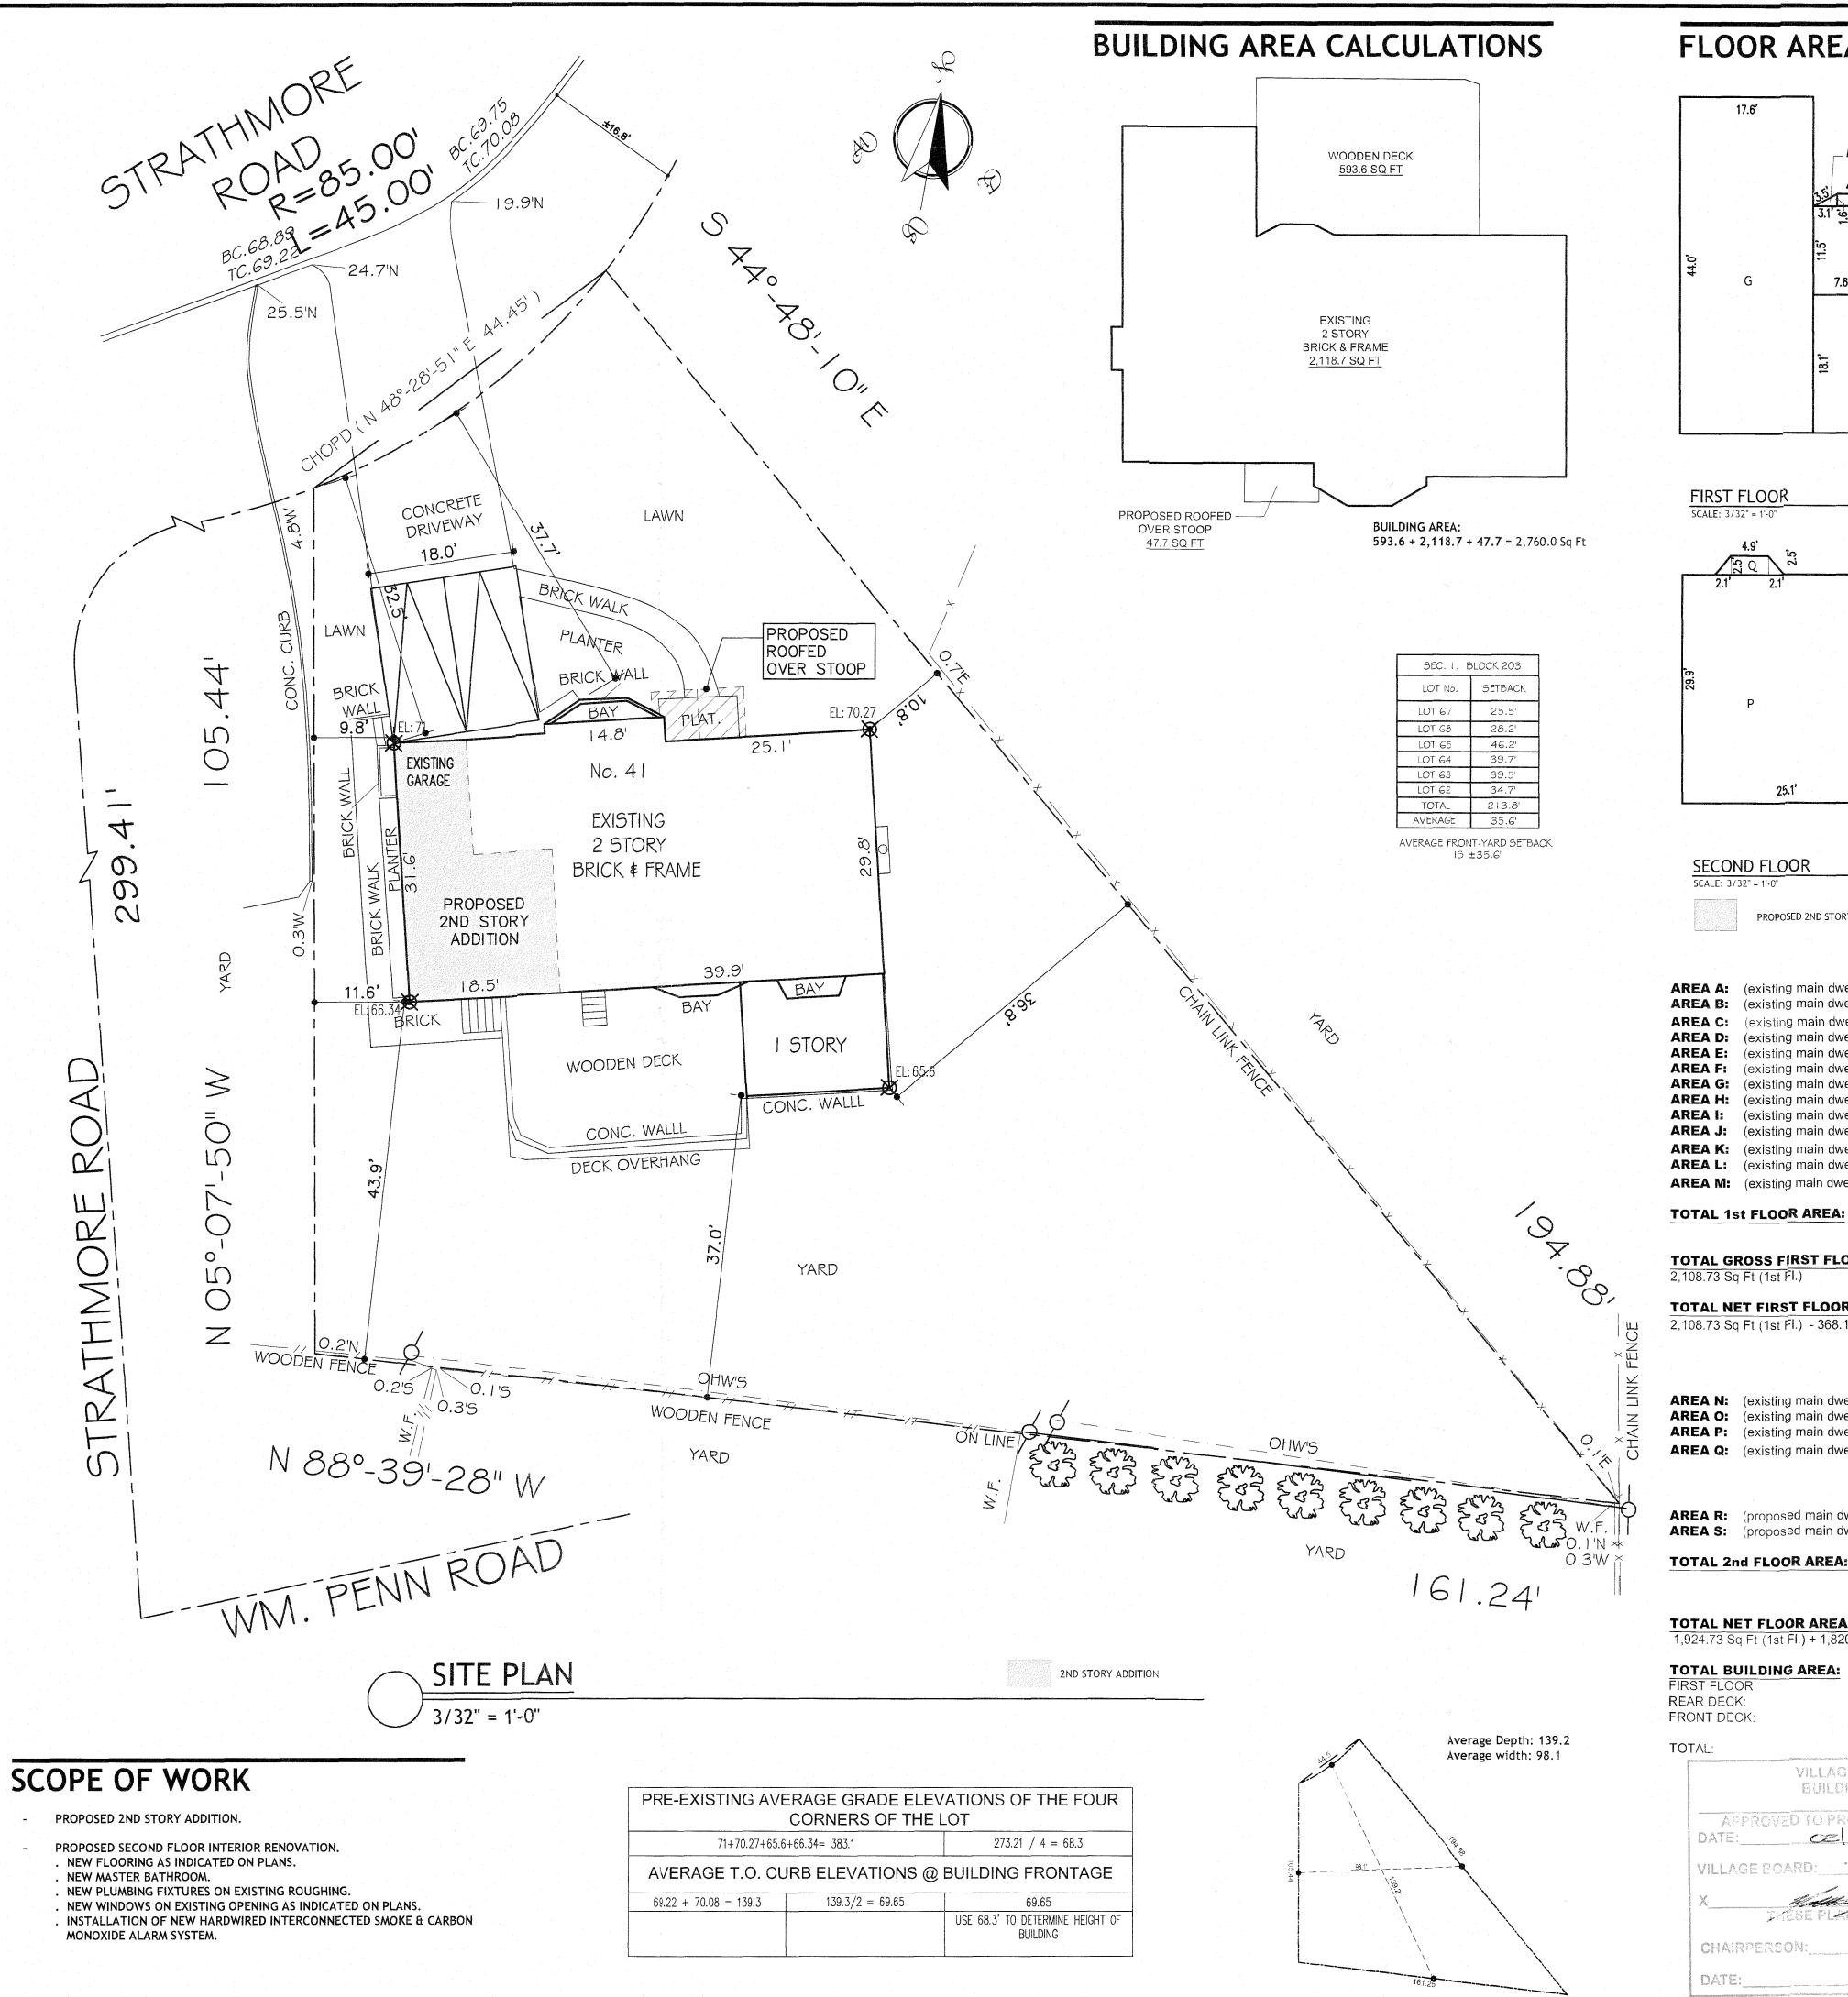


FLOOR AREA CALCULATIONS

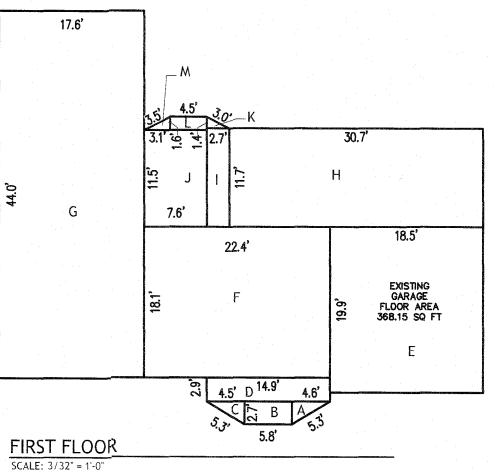

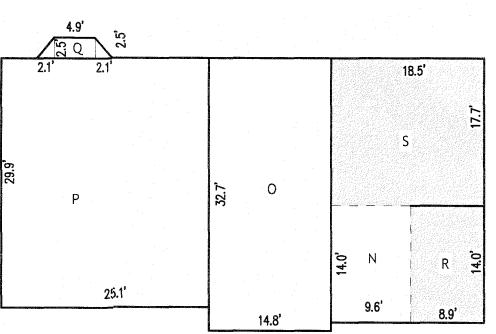

SECOND FLOOR SCALE: 3/32" = 1'-0"

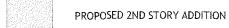

AREA A: AREA B:	(existing main dwelling) (existing main dwelling)	4.6' x 2.7' 2.7' x 5.8'	= 6.21 Sq Ft = 15.66 Sq Ft
AREA C: AREA D:	(existing main dwelling) (existing main dwelling)	4.5' x 2.7' 2.9' x 14.9'	= 6.07 Sq Ft = 43.21 Sq Ft
AREA E: AREA F:	(existing main dwelling) (existing main dwelling)	19.9' x 18.5' 22.4' x 18.1'	= 368.15 Sq Ft = 405.44 Sq Ft
AREA G: AREA H:	(existing main dwelling) (existing main dwelling) (existing main dwelling)	44.0' x 17.6' 30.7' x 11.7'	= 774.40 Sq Ft = 359.19 Sq Ft
AREA I: AREA J:	(existing main dwelling) (existing main dwelling) (existing main dwelling)	2.7' x 11.7' 11.5' x 7.6'	= 31.59 Sq Ft = 87.40 Sq Ft
AREA K:	(existing main dwelling)	1.4' x 2.7' 2	= 1.89 Sq Fi
AREA L: AREA M:	(existing main dwelling) (existing main dwelling)	4.5' x 1.6' 1.5' x 3.1' 2	= 7.20 Sq Ft = 2.32 Sq Ft

TOTAL GROSS FIRST FLOOR AREA:

2,108.73 Sq Ft (1st Fl.) = 2,108.73 Sq Ft

TOTAL NET FIRST FLOOR AREA:

 $2,108.73 \text{ Sq Ft (1st Fl.)} - 368.15 \text{ sq ft / 2 } (\frac{1}{2} \text{ garage}) = 1,924.73 \text{ Sq Ft}$

AREA N:	(existing main dwelling)	14' x 9.6'	= 134.4 Sq Ft
AREA O:	(existing main dwelling)	32.7' x 14.8'	= 483.96 Sq Ft
AREA P:	(existing main dwelling)	29.9' x 25.1'	= 750.49 Sq Ft
AREA Q:	(existing main dwelling)	$\left(\frac{2.1' \times 2.5'}{2}\right)$ + $\left(\frac{2.1' \times 2.5'}{2}\right)$	
		+ (2.5' x 4.9')	= 17.5 Sq Ft
AREA R:	(proposed main dwelling)	14.0' x 8.9'	= 124.6 Sq Ft
AREA S:	(proposed main dwelling)	18.5' x 17.7'	= 327.45 Sq Ft
TOTAL 2	nd FLOOR AREA:		1,820.9 Sq Ft

TOTAL NET FLOOR AREA: 1,924.73 Sq Ft (1st Fl.) + 1,820.9 Sq Ft (2nd Fl.) = 3,745.63 Sq Ft

TOTAL BUILDING AREA:

AVERAGE LOT WIDTH & DEPTH DIAGRAM

2,118.7 Sq Ft REAR DECK: 593.6 Sq Ft FRONT DECK: 47.7 Sq Ft

VILLAGE OF GREAT NECK BUILDING DEPARTMENT APPROVED TO PROCEED WITH BOARD REVIEW CE 28 2525 VILLAGE BOARD: TOZA, ACC The grand THÉSE PLANS ARE APPROVED BY: CHAIRPERSON:

2,760.0 Sq Ft

ZONING COMPUTATION

ADDRESS: 41 STRATHMORE RD, GREAT NECK, NY 11023 VILLAGE OF GREAT NECK LOT SIZE: 12,684.7 sq. ft.

SECTION: BLOCK: LOT(s): ZONING DISTRICT:

203 **RESIDENCE "A-1"** 7,500 sq. ft. 12,684.7 sq. ft.

LOT AREA REQUIRED: LOT AREA PROVIDED: LOT WIDTH REQUIRED: 60.0 ft. LOT WIDTH PROVIDED: 45.0 ft. LOT DEPTH REQUIRED: 100.0 ft. LOT DEPTH PROVIDED: 139.2 ft.

FRONT YARD REQUIRED: 25 ft. MIN. DEPTH TO 35 ft. MAX. DEPTH or average front yard (35.6 ft.) FRONT YARD EXISTING: 32,5 ft.

FRONT YARD PROPOSED: 32.5 ft. (Variance Required) REAR YARD REQUIRED: 25 ft. + 1/4 lot depth in excess of 100' 25 ft. + $\frac{1}{4}$ (139.2 - 100 ft.) = 34.8 ft. REAR YARD PROVIDED: REAR YARD PROPOSED: 43,9 ft. (Ok)

SIDE YARD (INTERIOR LOT) AGGREGATE SIDE YARD REQUIRED:

EXISTING EAVES HEIGHT PROVIDED:

18 ft. + $\frac{1}{2}$ of lot width in excess 60 ft. 98.1 average lot width 98.1 - 60= 38.1 x .5 = 19.05 19.05 + 18= 37.05

AGGREGATE SIDE YARD PROVIDED: 9.8 ft. + 10.8 ft. = 20.6 (Variance Required) MIN. SIDE YARD REQUIRED: $\frac{1}{2}$ of min. aggregate side yard

 $\frac{1}{2}$ x 37.05 = 18.52 ft. SIDE YARDS PROVIDED: 9.8 ft. and 10.8 ft. (Variance Required) MAX. HEIGHT PERMITTED: **EXISTING HEIGHT PROVIDED:** 30.41 ft (Variance Required) MAX. EAVES HEIGHT PERMITTED: 22.0 ft.

21.5 ft.

BUILDING AREA:

Max. Building Area permitted: 25% of lot area. $.25 \times 12,684.7$ sq. ft. = 3,171.17 sq. ft. Existing Building Area: 2,760.0 sq. ft. 21.7 % of lot area. TOTAL FLOOR AREA ALLOWED: (F.A.R.)

0.50 for first 6,000 sq. ft. of lot area = 3,000 sq. ft 0.20 for lot area in excess of 6,000 sq. ft. less than 100 ft. from street 0.2 X (7,994.45 sq. ft. - 6,000 sq. ft.) = 398.89 sq. ft.

0.10 for lot area in excess of 6,000 sq. ft. more than 100 ft. from street $4,690.23 \text{ sq. ft. } X \ 0.10 = 469.02 \text{ sq. ft.}$ MAX. F.A.R. = 3,000 + 398.89 + 469.02 = 3,897.91 sq. ft.

FLOOR AREA PROVIDED: (See Floor Area Diagram & Calculations)

TOTAL NET FLOOR ARE: 3,745.63 Sq Ft > 3,897.91 sq. ft.

575-155-J-A2 PARKING IN RESIDENCE DISTRICTS 5 BEDROOMS - 4 PARKING SPACES REQUIRED 2 PARKING SPACES PROVIDED IN THE DRIVEWAY.

GENERAL NOTES

2,108.73 Sq Ft

SPECIFICATIONS:

1) ALL CONSTRUCTION SHALL BE IN ACCORDANCE WITH THE 2020 NEW YORK STATE UNIFORM CODE AND THE 2020 THE NEW YORK STATE ENERGY CONSERVATION CODE.

2 PARKING SPACES PROVIDED IN THE GARAGE.

2) DRAWINGS ARE NOT TO BE SCALED. USE DIMENSIONS ONLY. CONTRACTOR SHALL CHECK ALL DIMENSIONS AND CONDITIONS AT JOB SITE. ANY DISCREPANCIES OR OMISSIONS FROM PLANS AND/OR SPECIFICATIONS MUST BE CALLED TO THE ATTENTION OF THE RECORD ARCHITECT/ENGINEER AND SAME CORRECTED WITHIN (5) DAYS AFTER CONTRACT HAS BEEN AWARDED OTHERWISE CONTRACTOR WILL BE HELD RESPONSIBLE. 3) NO WORK TO COMMENCE UNTIL APPROVAL HAS BEEN OBTAINED FROM VILLAGE OF GREAT NECK

DEPARTMENT OF BUILDINGS PERMITS HAVE BEEN SECURED.

4) CONTRACTOR AND/OR RESPECTIVE SUBCONTRACTORS SHALL BE RESPONSIBLE FOR ADEQUATELY BRACING AND PROTECTING ALL COLLAPSES, DISTORTIONS AND MISALIGNMENT ACCORDING TO ALL APPLICABLE CODES, STANDARDS AND GOOD CONSTRUCTION PRACTICES. 5) ALL MATERIALS AND CONSTRUCTION TO BE INCORPORATED IN THE WORK SHALL BE IN STRICT ACCORDANCE WITH THE LATEST EDITION OF ASTM SPECIFICATIONS WHERE APPLICABLE AND SHALL CONFORM INSTITUTES

(ACI, AISC, SJI, ETC.) ARE APPLICABLE. ALL MATERIALS USED IN CONNECTION WITH THIS PROJECT MUST BE

NEW MATERIALS UNLESS SPECIFIED OTHERWISE. 6) ALL CONCRETE SHALL BE 3,500 PSI, 28 DAY TEST MINIMUM 7) FOUNDATIONS AND FOOTINGS SIZED FOR BEARING ON VIRGIN SOIL AT MINIMUM BEARING CAPACITY OF 2

TONS PER SQUARE FOOT WITH A MINIMUM OF 3'-0" OF COVER 8) ALL WOOD FRAMING INCLUDING JOISTS, BEAMS, POSTS, STUDS, ETC. TO BE DOUGLAS FIR NO.2 OR BETTER Fb = 850 PSI, SINGULAR

Fb = 1150 PIS, REPETITIVE NOTE: PROVIDED SEISMIC AND HURRICANE TIES FOR ALL EXTERIOR FRAMING CONNECTIONS, SUBMIT SHOP DRAWINGS TO ARCHITECT FOR APPROVAL.

9) ALL HEADERS TO BE SUPPORTED BY 4" X 4" POST (TYP.) 10) PROVIDE DOUBLE HEADERS AND TRIMMERS AT ALL STAIR AND FLOOR OPENINGS AND UNDER ALL POSTS AND PARTITIONS RUNNING PARALLEL TO SAME.

11) BRIDGING TO BE EITHER SOLID OR 1" X 3" OR 18 GA. CROSS BRIDGING 12) ALL HEADERS TO BE (2) 2" X 8" UNLESS OTHERWISE NOTED.

13) ALL TOP AND BOTTOM EDGES OF JOISTS MAY BE NOTCHED NOT TO EXCEED 2".

14) ALL WINDOWS AND EXTERIOR DOOR OPENINGS WHERE BRICK VENEER OCCURS MUST BE PROVIDED WITH GALV. 3-1/2"X 5" X 5/16" STEEL LINTEL AT HEADER. 15) JOISTS HANGERS, ETC. TO BE "TECO", "SIMPSON" OR EQUAL FOR ALL FLUSH STRUCTURAL CONNECTIONS. 16) THE EXTERIOR SURFACE OF ALL FOUNDATION WALLS BELOW GRADE (EXCEPT SLAB AREAS) SHALL BE

WATERPROOFED WITH AN ELASTIC COAL TAR BASE, SELF PRIMING BITUMINOUS PLASTIC CEMENT.

17) FOUNDATION DRAIN TILE, 4" Ø MIN. SET IN GRAVEL MUST BE PROVIDED AROUND THE EXTERIOR PERIMETER SIDE OF ALL FOOTING, ± 4" BELOW CONCRETE SLAB. 18) SMOKE-DETECTING ALARM DEVICES, INSTALLED IN CONFORMITY WITH SECTION 1060.10 OF NYS BUILDING

CODE SHALL BE PROVIDED OUTSIDE EACH SEPARATE SLEEPING AREA, IN EACH SLEEPING SPACE AND ON EACH FLOOR LEVEL. 19) PROVIDE EXPANDABLE SPRAY-APPLIED POLYURETHANE FOAM SEALANT, CONTINUOUS @ WINDOW AND DOOR


ROUGH OPENINGS. 20) RECESSED LUMINAIRES IN THE ROOF & GARAGE CEILING ASSEMBLY SEALED TO 1CFM AIR MOVEMENT. 21) PROVIDE WEATHER STRIPPING ON ALL EXTERIOR DOORS.

1) ALL DIMENSIONS ARE TO FACE OF GYP. BD. AND CENTERLINE COLUMNS, UNLESS SPECIFICALLY OTHERWISE

2) FINISH FLOOR ELEVATIONS ARE TO TOP OF CONCRETE, UNLESS NOTED OTHERWISE. ALL VERTICAL

DIMENSIONS ARE REFERENCED FROM TOP OF CONCRETE, UNLESS NOTED OTHERWISE. 3) WHERE NO SPECIFIC DETAILS ARE SHOWN, CONSTRUCTIONS SHALL BE SIMILAR TO THAT INDICATED OR NOTED FOR SIMILAR CONDITIONS AND CASES OF CONSTRUCTION ON THIS PROJECT.

4) CONTRACTOR TO VERIFY THE STRUCTURE BEFORE COMMENCING ANY WORK AND NOTIFY ARCHITECT OR P.E.

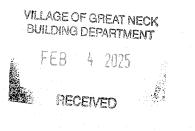

HN ENGINEERING, PC

15 Canterbury Road #A8 Great Neck, NY 11021 t. 516 209 7772 / f. 516 706 1853



Addition Story 2nd Propos T T

No. Date 07.8.24 Issued For Filing 01.17.24 | As Per 07.31.24 Comments 01.30.25 | As Per 01.27.25 Comments No. Date


> It is a violation of the New York State law for any person, unless acting under the direction of a licensed architect, to alter any item on

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SITE PLAN, NOTES & DIAGRAMS

Job No: Date: 2103 07/08/2024 Scale: as shown Drawn By: I.REI

Drawing Number:

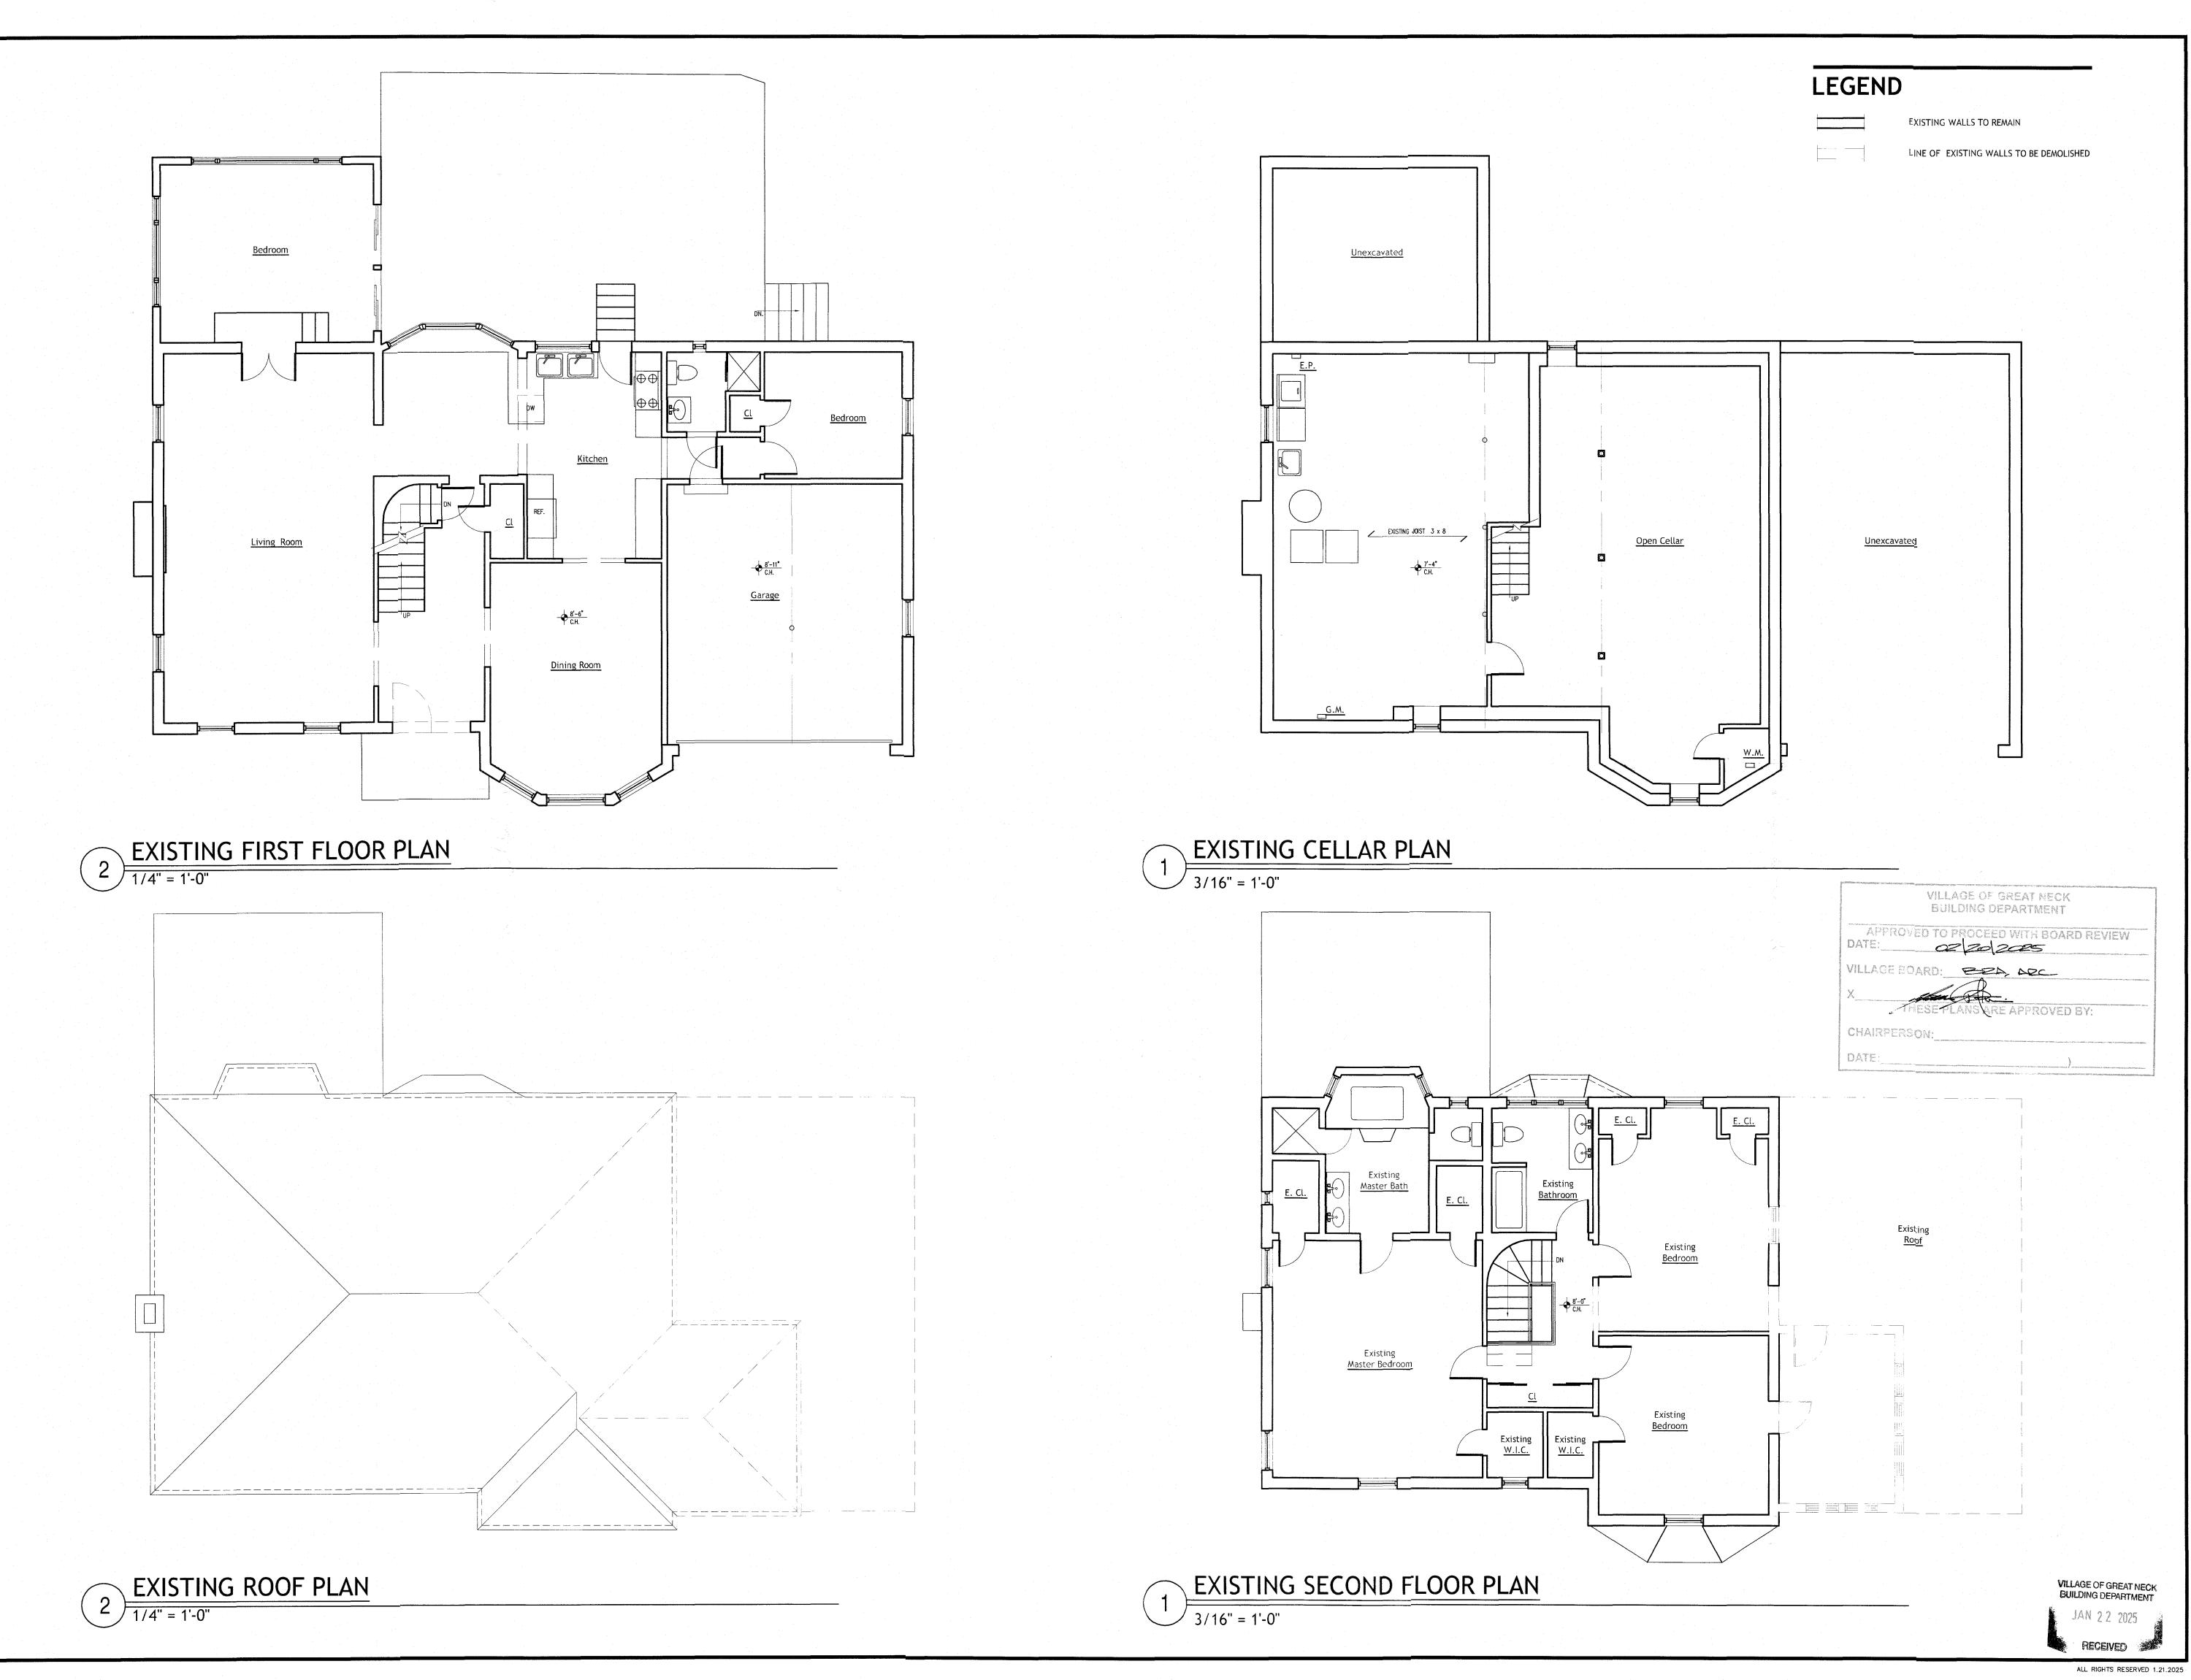

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ENGINEERING, PC

15 Canterbury Road #A8
Great Neck, NY 11021
t. 516 209 7772 / f. 516 706 1853
info@isaacrei.com

Seal

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Proposed 2nd Story Addition

Broked 2nd

No. Date | Sume:

1 07.08.24 | Sume:

1 07.08.24 | Sume:

2 01.17.24 | As Per 07.31.24 Comments

No. Date | Revision

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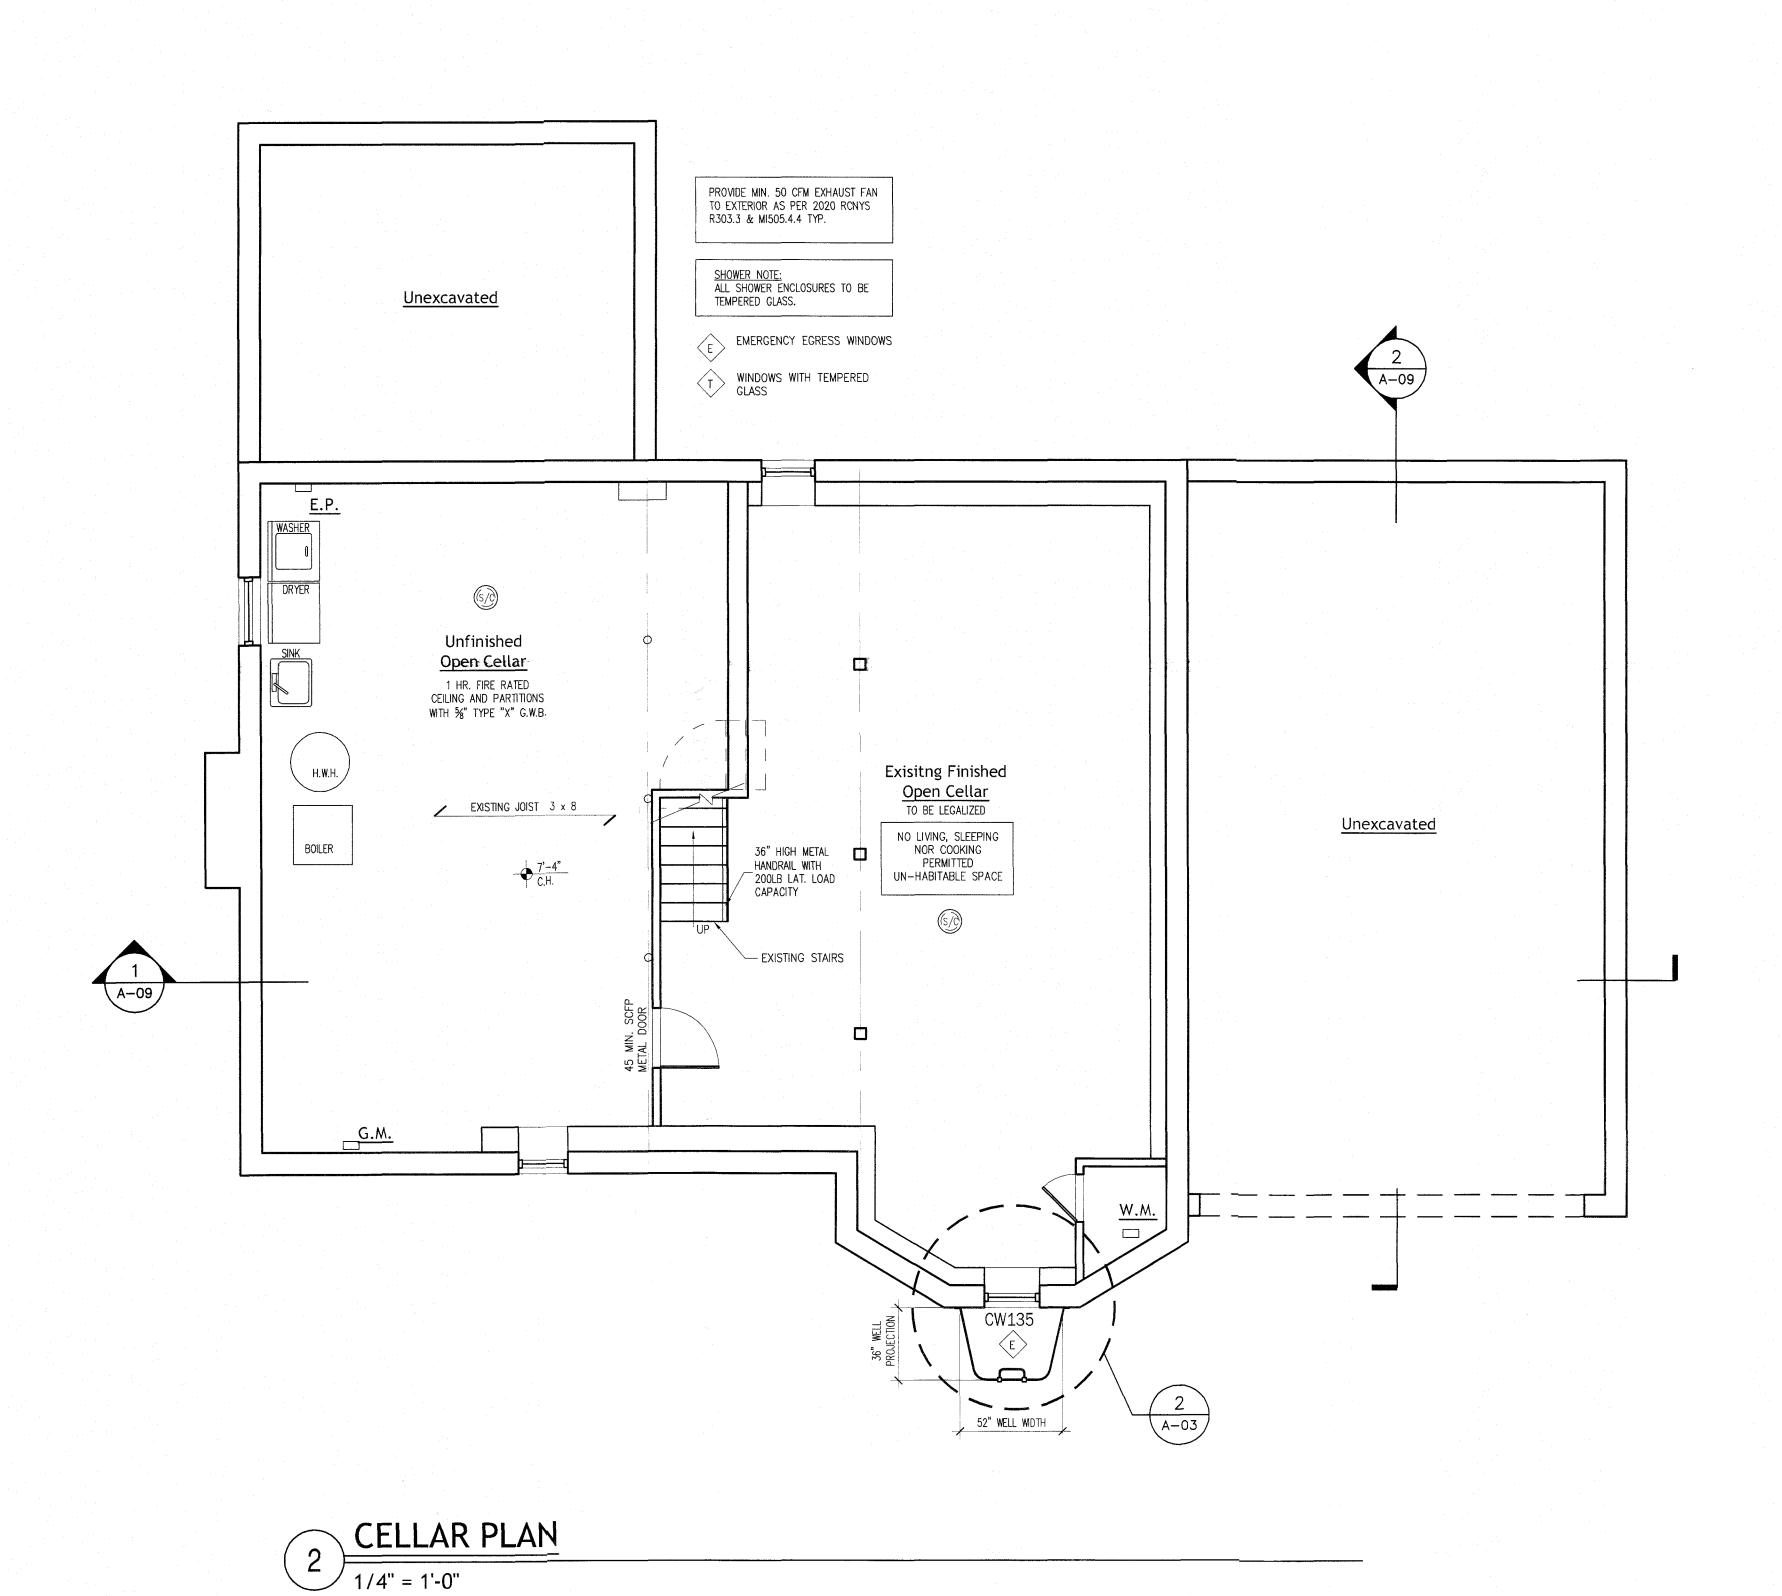
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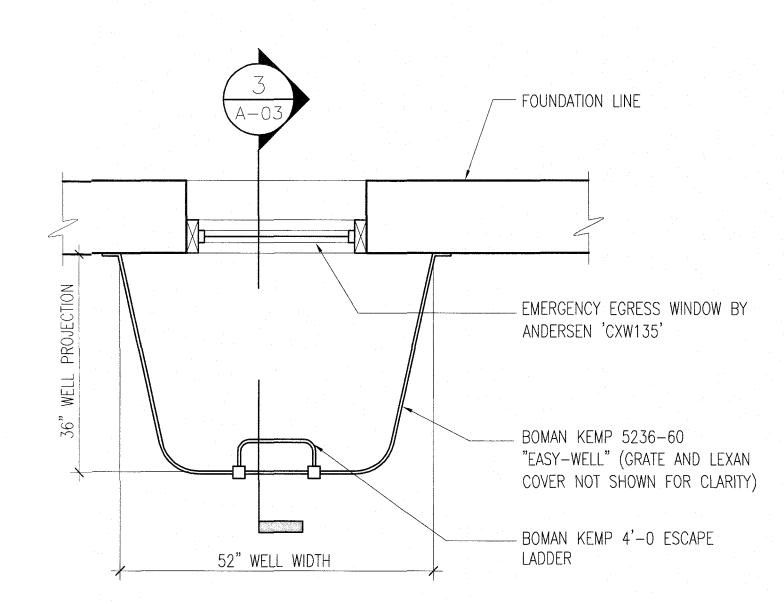
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EXISTING FLOOR PLANS


Job No: 2103
Date: 07/08/2024
Scale: as shown
Drawn By: I.REI

Drawing Number: $\begin{array}{c} \mathbf{A-02} \\ \mathbf{2} \text{ of } \mathbf{3} \end{array}$





EGRESS WINDOW WELL PLAN DETAIL 1/2" = 1'-0"

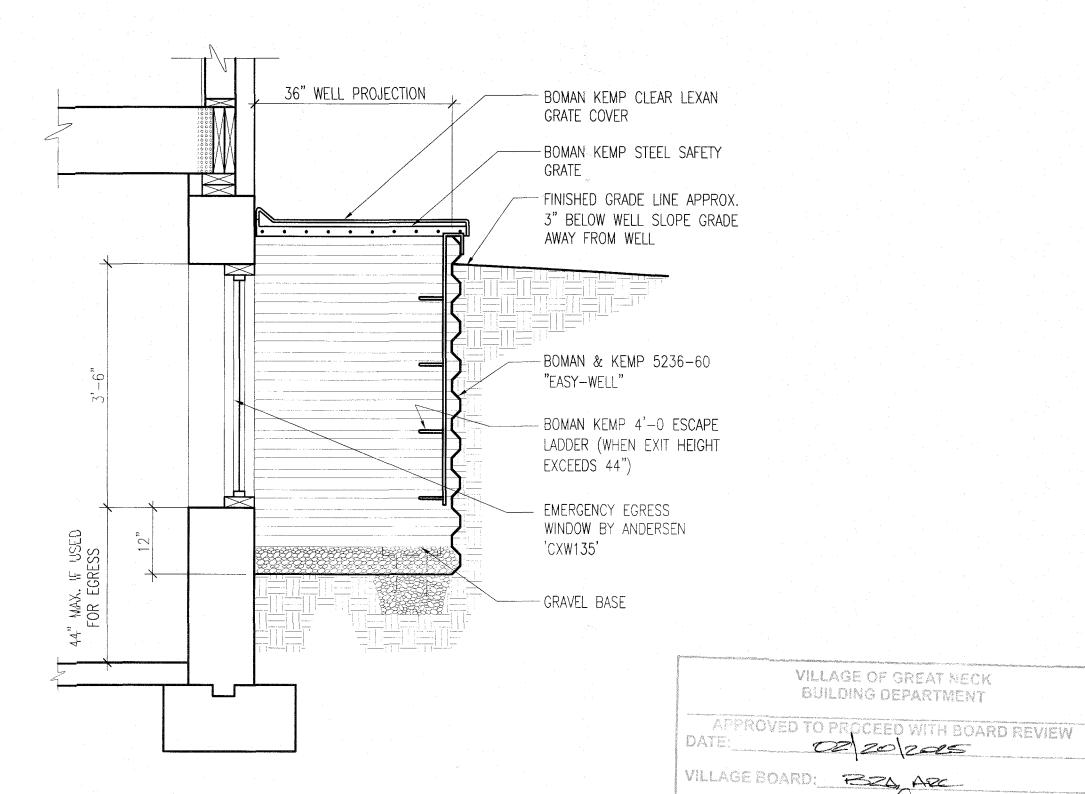

EGRESS WINDOW WELL SECTION DETAIL 1/2" = 1'-0"

Proposed 2nd Story A 41 Strathmore Rd, Great Neck, NY 11023 No. Date

Addition

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EXISTING CELLAR PLAN

 Job No:
 2103

 Date:
 07/08/2024

 Scale:
 as shown

 Drawn By:
 I.REI

3 of 9


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VILLAGE OF GREAT NECK BUILDING DEPARTMENT

VILLAGE OF GREAT NECK BUILDING DEPARTMENT

CHAIRPERSON:

DATE:

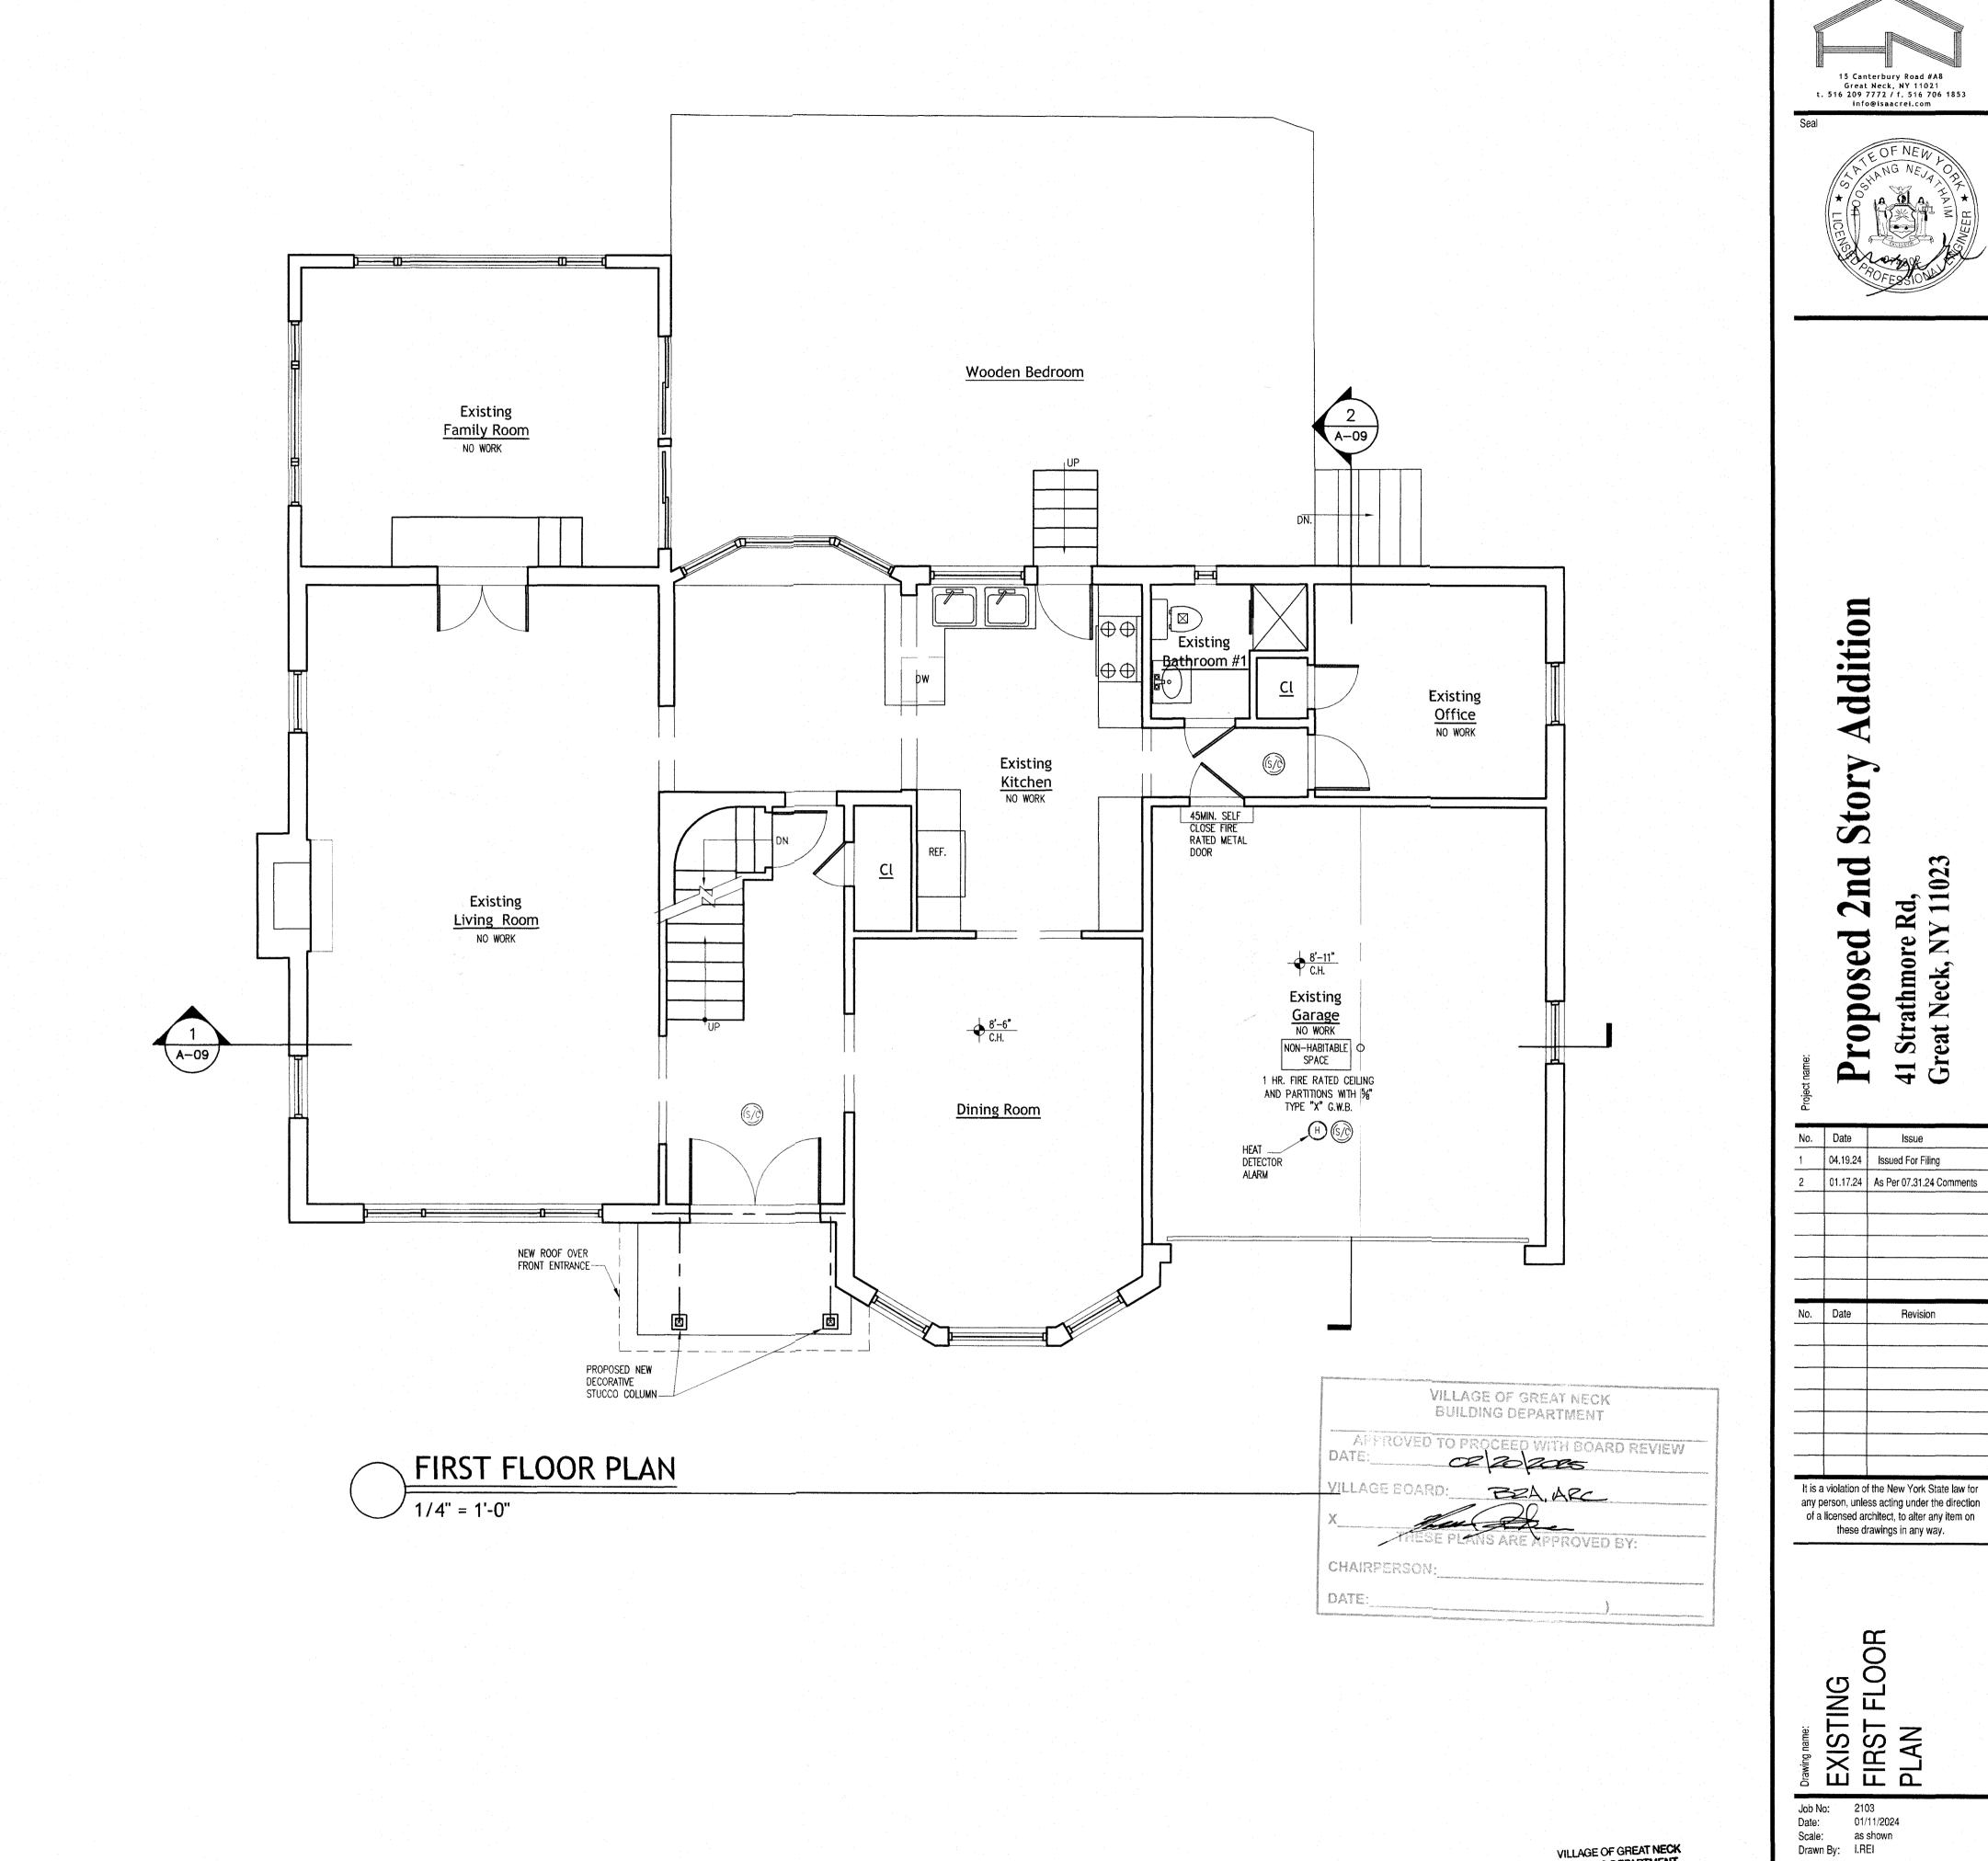


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VILLAGE OF GREAT NECK BUILDING DEPARTMENT FEB 2 0 2025

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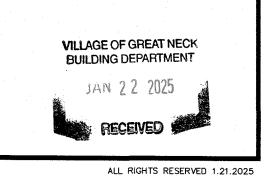
Drawing Number: 4 of 9



SECOND FLOOR PLAN

1/4" = 1'-0"

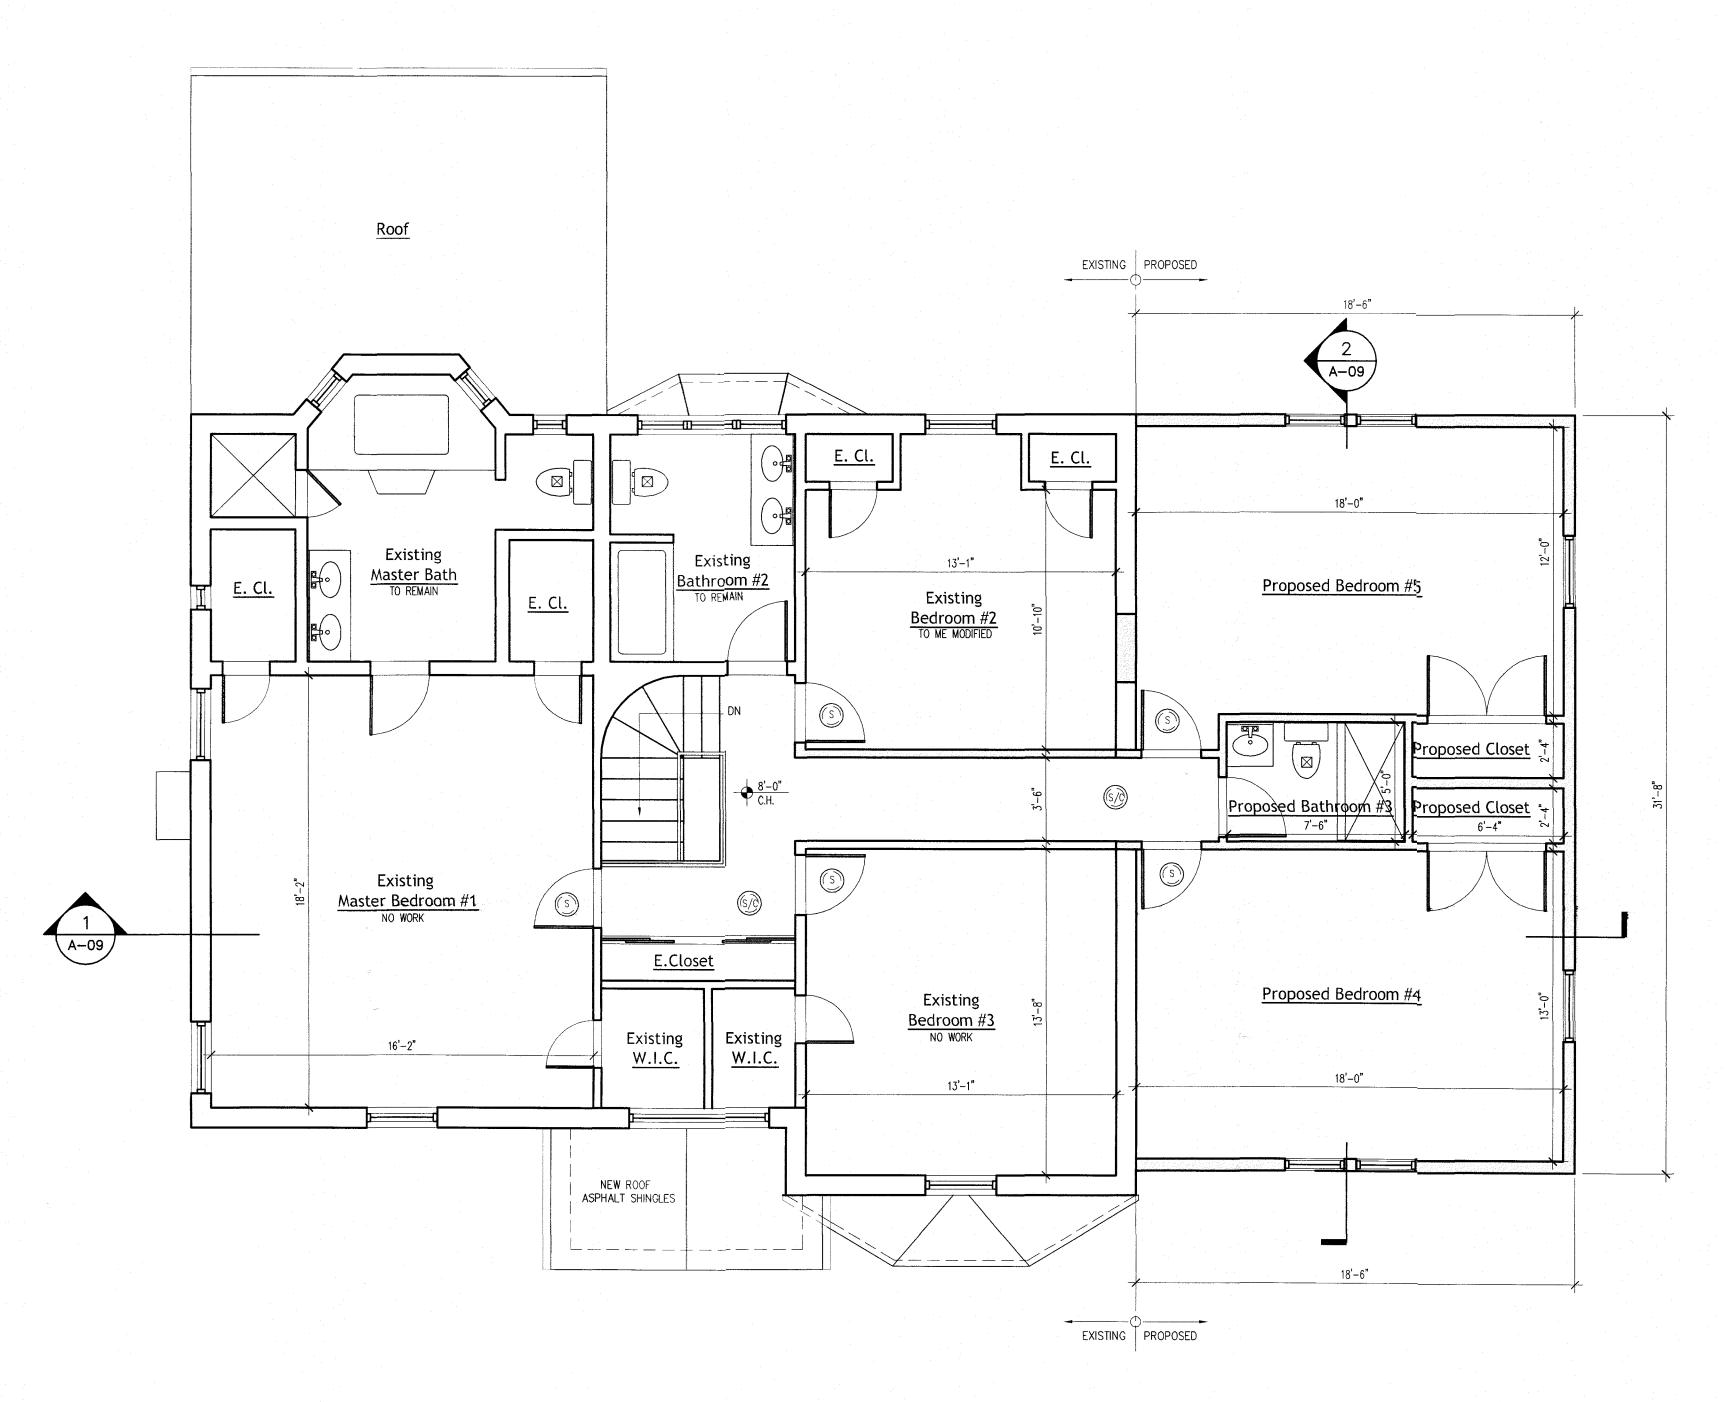APPR	OVED TO PROCEED WITH BOARD REVIEW
DATE:	02/2025
VILLAGE	BOARD: BEA, ARC
X	
And the state of t	TRESE PLANS ARE APPROVED BY:



HN
ENGINEERING, PC

15 Canterbury Road #A8
Great Neck, NY 11021
t. 516 209 7772 / f. 516 706 1853
info@isaacrei.com

Seal

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Proposed 2nd Story Addition
41 Strathmore Rd,
Great Neck, NY 11023

No. Date Issue

1 07.08.24 Issued For Filing

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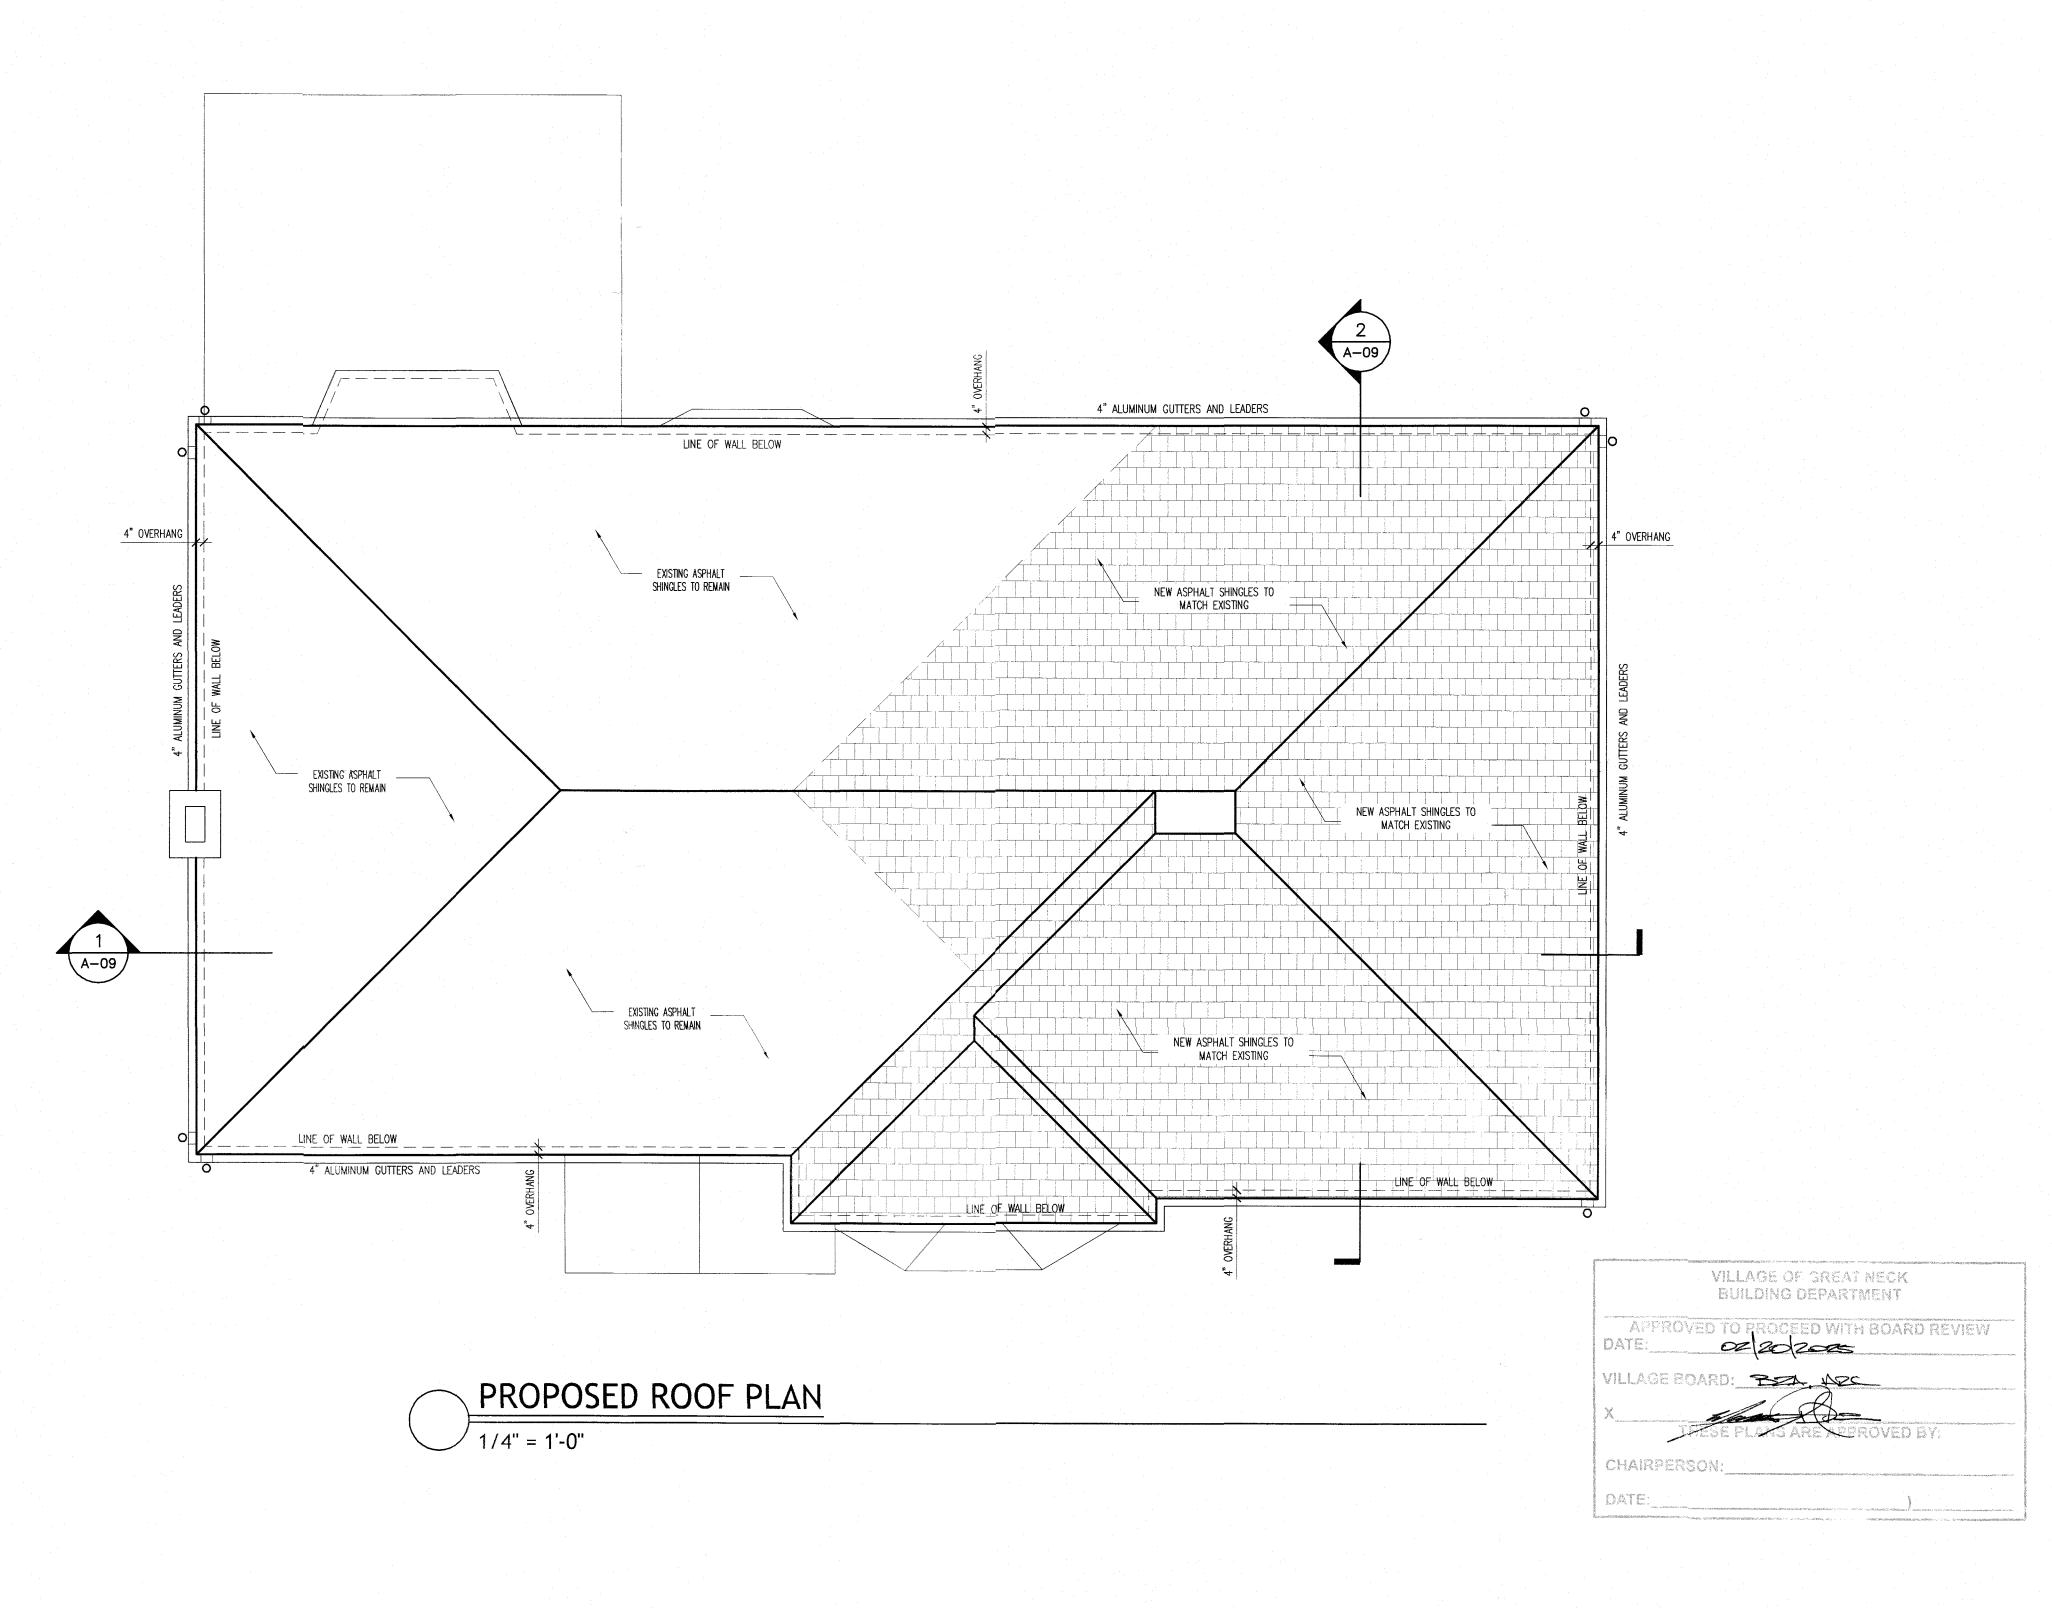
PROPOSED
SECOND FLOOR
PLAN

Job No: 2103
Date: 07/08/2024
Scale: as shown
Drawn By: I.REI

Drawing Number:

A-05

5 of 9



VILLAGE OF GREAT NECK BUILDING DEPARTMENT

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Addition Proposed 2nd Story 41 Strathm Great Necl

No. Date Issue 07.08.24 Issued For Filing 2 01.17.24 As Per 07.31.24 Comments No. Date It is a violation of the New York State law for

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PROPOSED ROOF PLAN


Job No: 2103
Date: 07/08/2024
Scale: as shown
Drawn By: I.REI

Drawing Number:




FENESTRATION @ WEST SIDE FACADE SCALE: N.T.S.

TOTAL AREA @ WEST SIDE FACADE: 805.76 SQ FT MINIMUM FENESTRATION REQUIRED: 10% FENESTRATION PROVIDED (WINDOWS & DOORS): 123 SQ FT. 15% (OK)

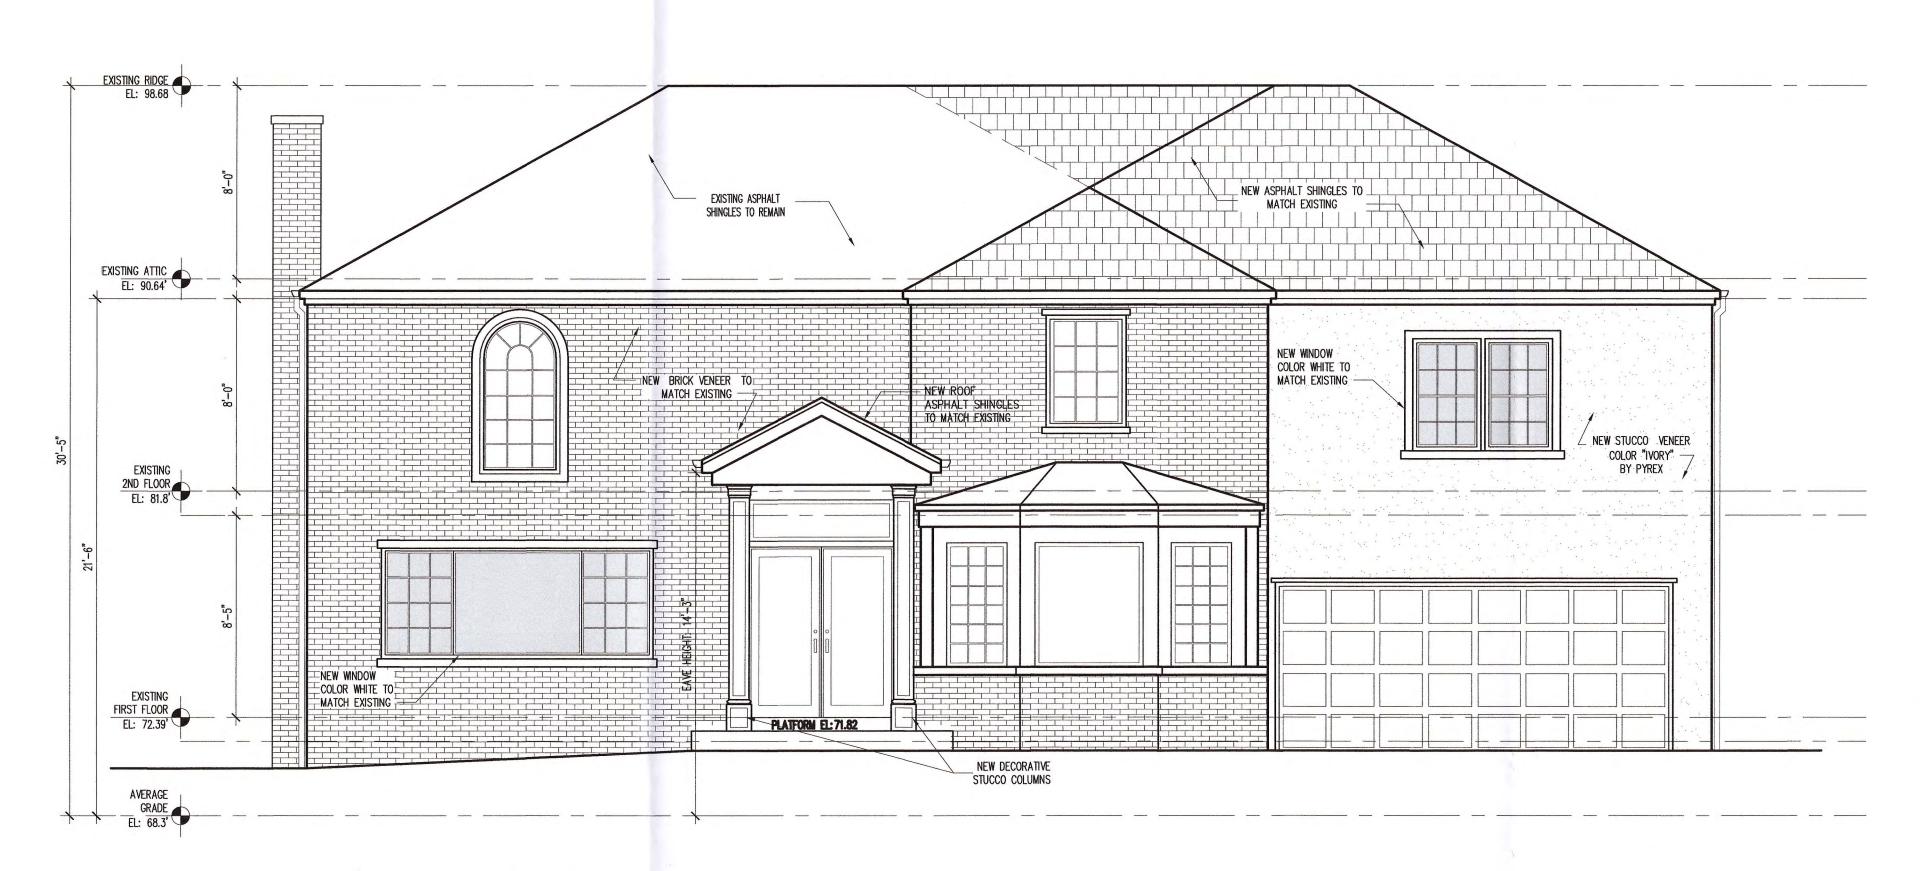

FRONT ELEVATION

1/4" = 1'-0"

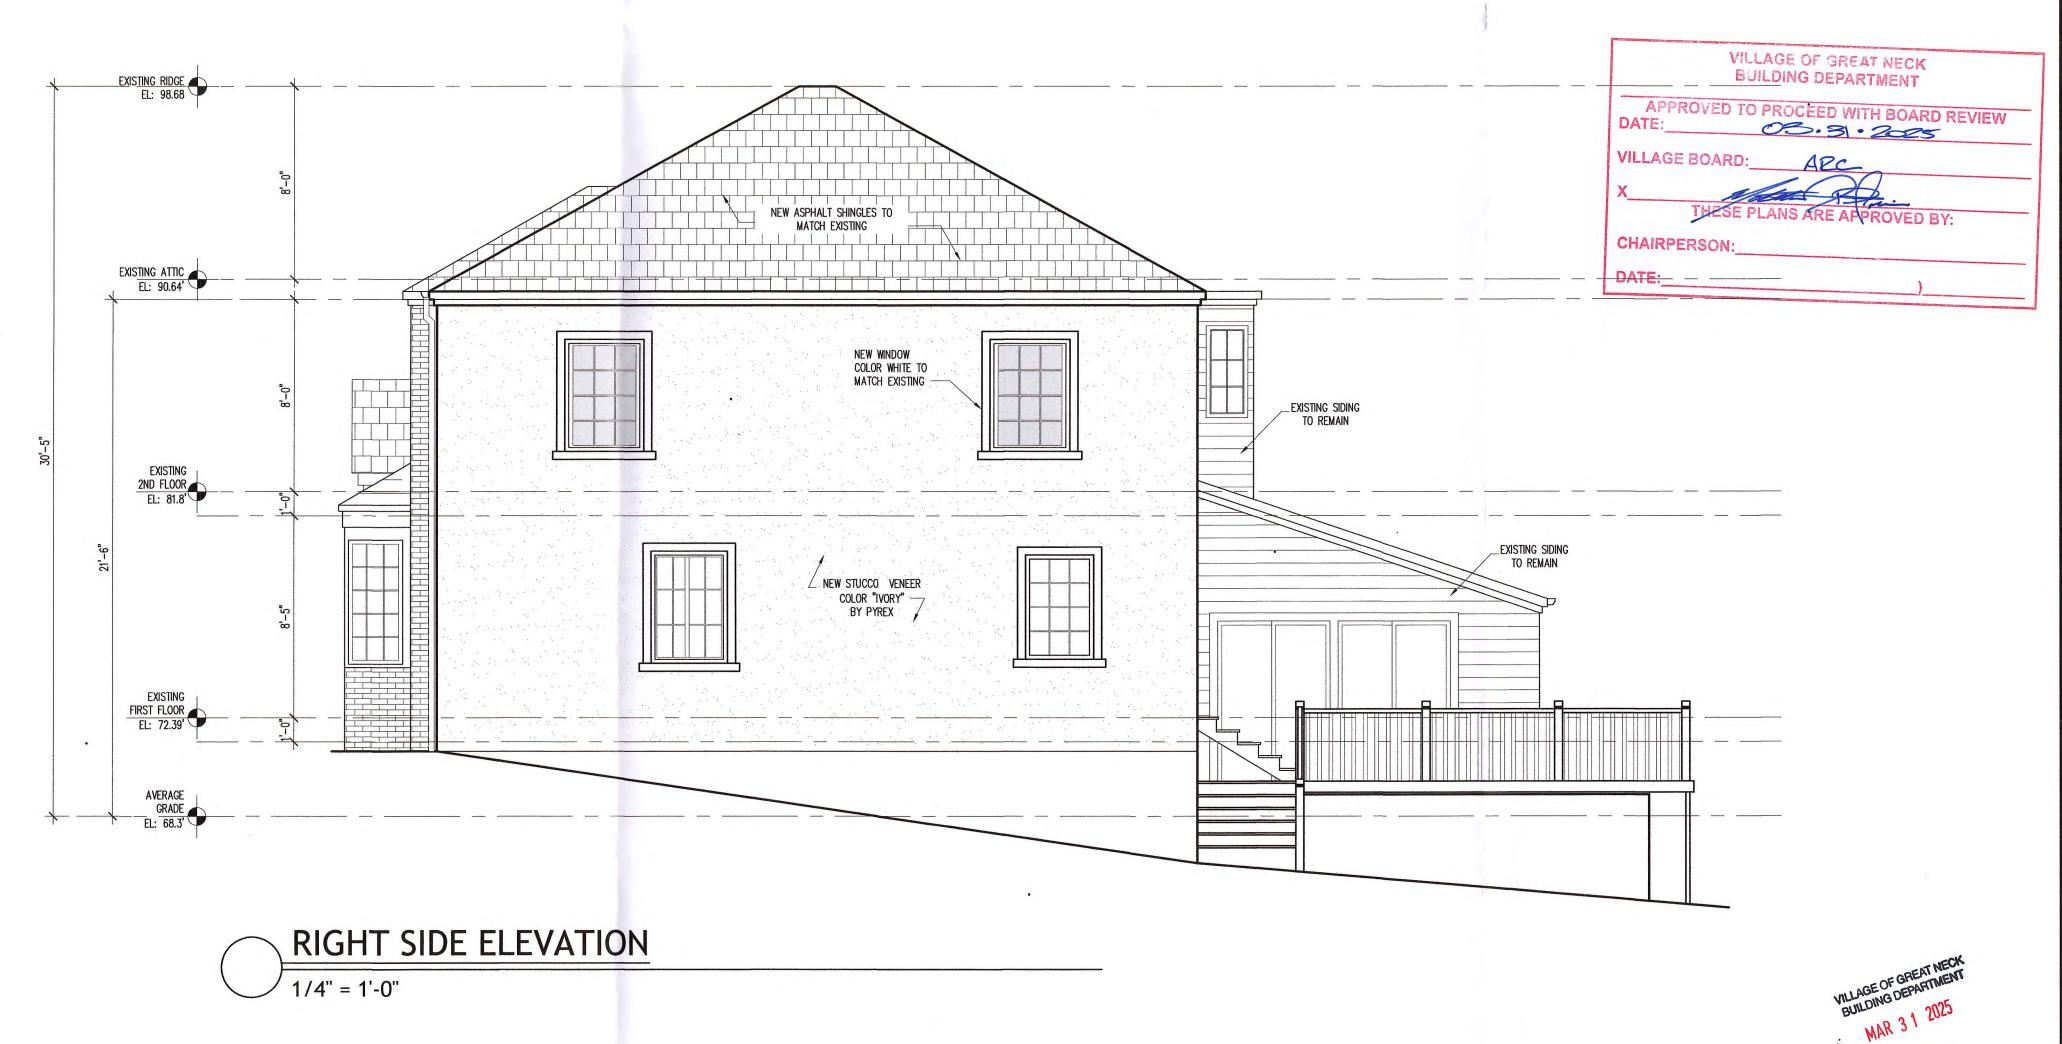

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15 Canterbury Road #A8
Great Neck, NY 11021
t. 516 209 7772 / f. 516 706 1853
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Proposed 2nd Story Addition
41 Strathmore Rd,
Great Neck, NY 11023

No. Date Issue

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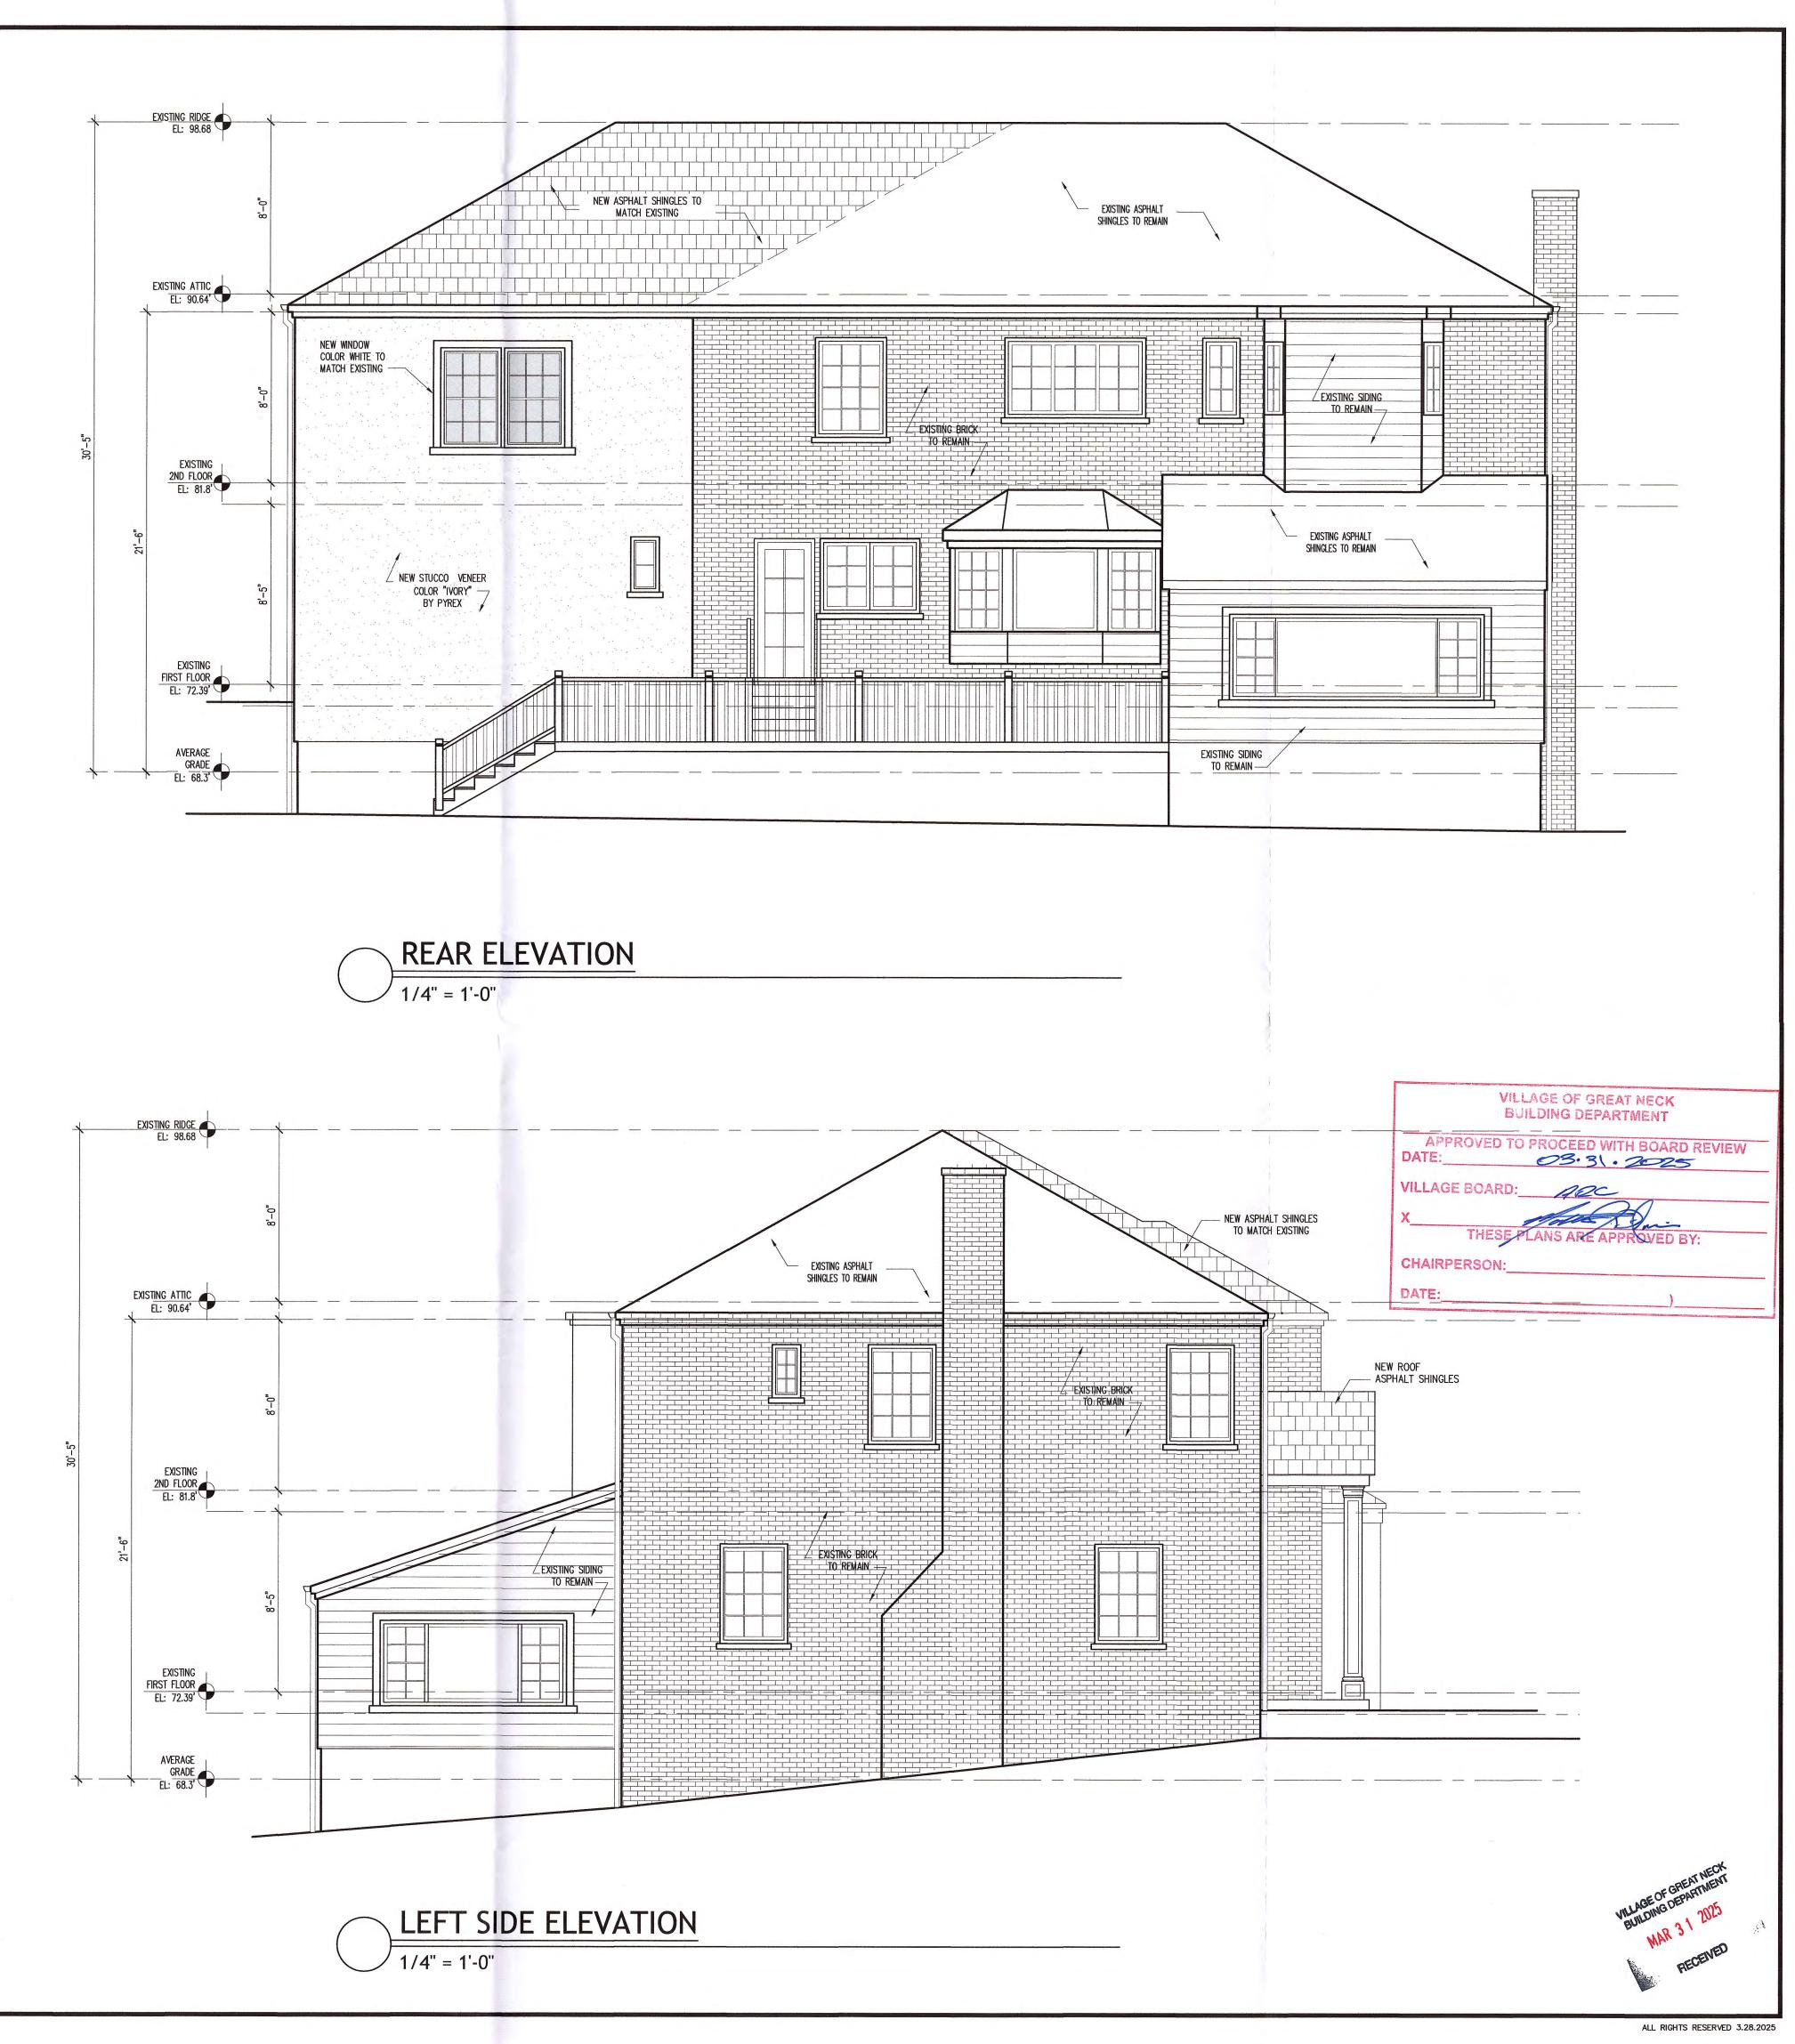
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Date: 01/11/2024
Scale: as shown
Drawn By: I.REI
Drawing Number:

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A-07
7 of 9



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Proposed 2nd Story Addition


41 Strathmore Rd, Great Neck, NY 11023 1 04.19.24 Issued For Filing 2 01.17.24 As Per 07.31.24 Comments No. Date

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ELEVATIONS

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Date: 01/11/2024
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Drawn By: I.REI 01/11/2024

A-08 8 of 9

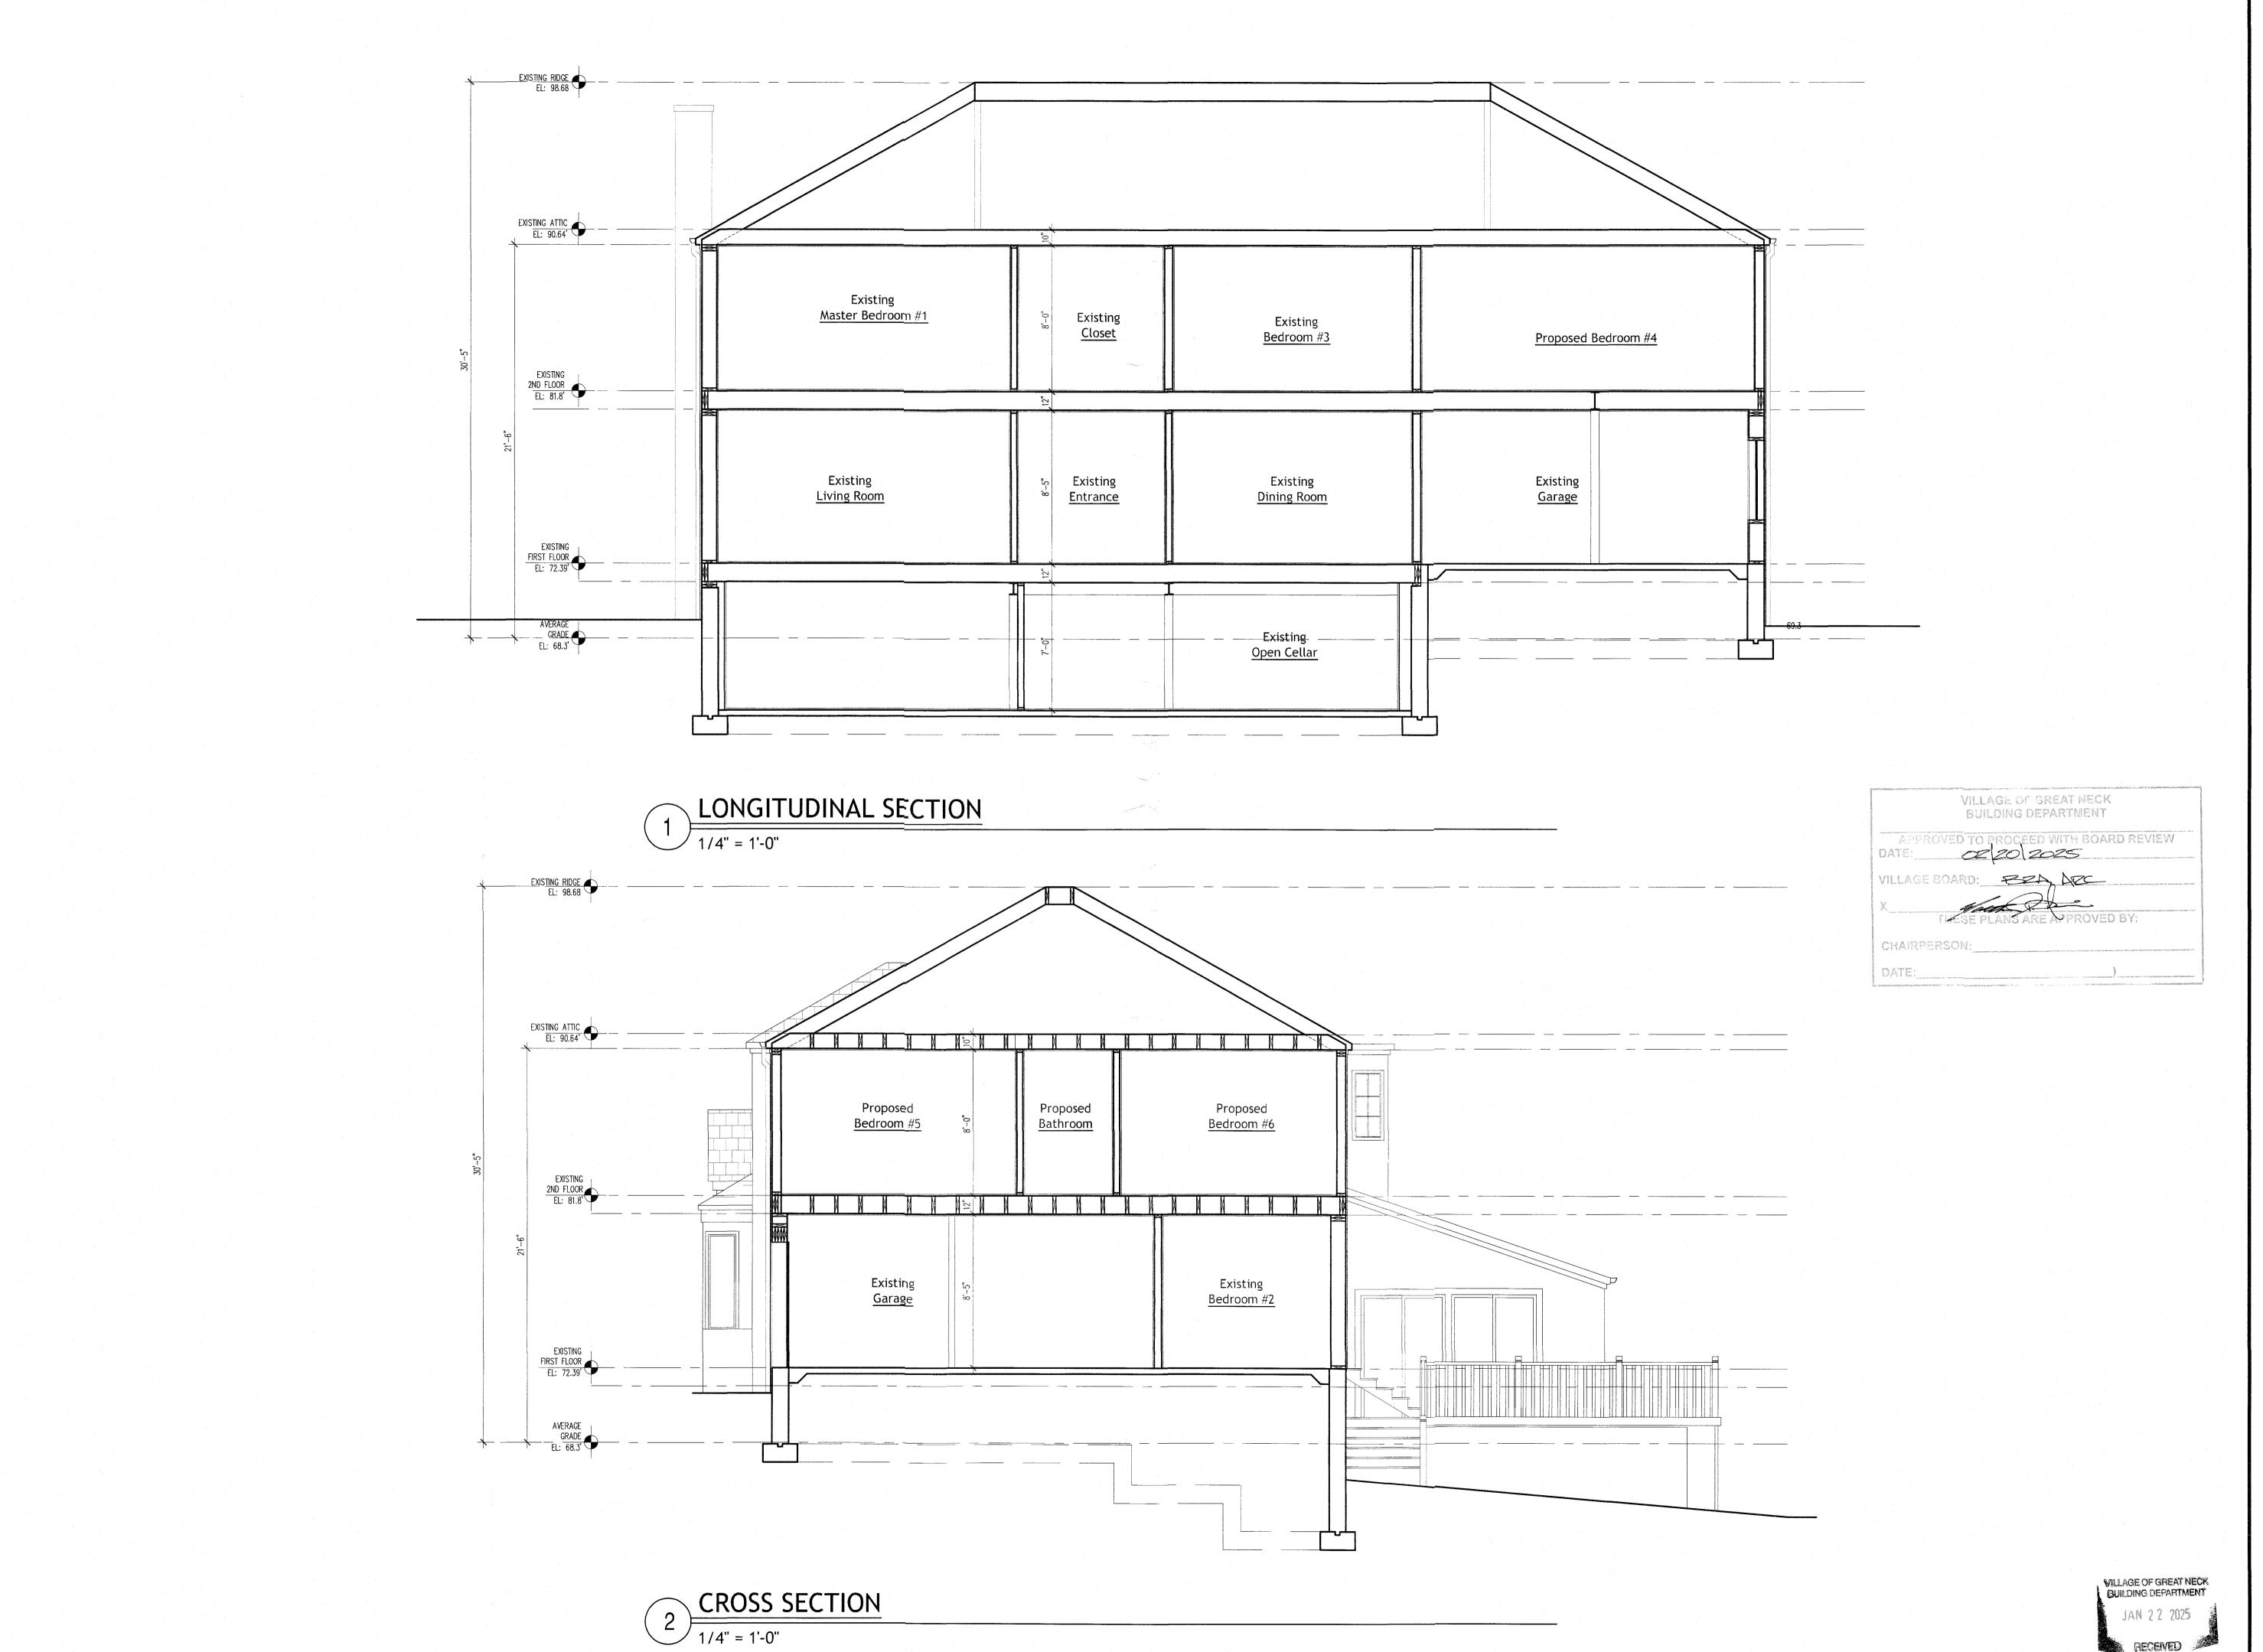

HN ENGINEERING, PC

15 Canterbury Road #A8 Great Neck, NY 11021 t. 516 209 7772 / f. 516 706 1853 info@isaacrei.com



Proposed 2nd Story Addition 41 Strathmore Rd, Great Neck, NY 11023

No. Date Issue 1 04.19.24 Issued For Filing
2 01.17.24 As Per 07.31.24 Comments No. Date

It is a violation of the New York State law for any person, unless acting under the direction of a licensed architect, to alter any item on these drawings in any way.

SECTIONS & DETAILS

Job No: 2103
Date: 01/11/2024
Scale: as shown
Drawn By: I.REI

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ITEM TITLE:

ARC CASE #25-6 2 MARGARET COURT SECTION 1 BLOCK 128 LOT 291

SUBJECT:


Application for proposed exterior renovation. 1st and 2nd story extension.

ATTACHMENTS:

Description Type

D PLANS Backup Material

GENERAL NOTES ZONING COMPUTATION SITE DRAINAGE 23 N68°02'50"E **CALCULATIONS & NOTES 2 MARGARET COURT** 1) ALL CONSTRUCTION SHALL BE IN ACCORDANCE WITH THE 2020 NEW YORK STATE UNIFORM CODE AND THE 2020 THE NEW YORK STATE ENERGY ္ကပ္ပါ သူပါ **GREAT NECK, NY 11024** CONSERVATION CODE. LOT SIZE: 9557.7 sq. ft. 2) DRAWINGS ARE NOT TO BE SCALED. USE DIMENSIONS ONLY. CONTRACTOR SHALL CHECK ALL DIMENSIONS AND CONDITIONS AT JOB SITE. ANY DISCREPANCIES BASED ON 3" FALL INTENSITY-SECTION: OR OMISSIONS FROM PLANS AND/OR SPECIFICATIONS MUST BE CALLED TO THE ATTENTION OF THE RECORD ARCHITECT/ENGINEER AND SAME CORRECTED HN Engineering PC BLOCK: 128 IMPERVIOUS AREA: 1 14" WITHIN (5) DAYS AFTER CONTRACT HAS BEEN AWARDED OTHERWISE CONTRACTOR WILL BE HELD RESPONSIBLE LOT(s): 291 3) NO WORK TO COMMENCE UNTIL APPROVAL HAS BEEN OBTAINED FROM VILLAGE OF GREAT NECK DEPARTMENT OF BUILDINGS PERMITS HAVE BEEN SECURED. 36 Ruxton Road PROPOSED ROOF AREA = 434.7 SQ FT **RESIDENCE "AA"** ZONING DISTRICT: 4) CONTRACTOR AND/OR RESPECTIVE SUBCONTRACTORS SHALL BE RESPONSIBLE FOR ADEQUATELY BRACING AND PROTECTING ALL COLLAPSES, DISTORTIONS Great Neck, NY 11023 DRIVEWAY EXPANSION AREA = 66.3 SQ FT 28" AND MISALIGNMENT ACCORDING TO ALL APPLICABLE CODES, STANDARDS AND GOOD CONSTRUCTION PRACTICES. ROOFED FRONT COVER T. 516-209-7772 5) ALL MATERIALS AND CONSTRUCTION TO BE INCORPORATED IN THE WORK SHALL BE IN STRICT ACCORDANCE WITH THE LATEST EDITION OF ASTM F. 516-706-1853 WOOD SPECIFICATIONS WHERE APPLICABLE AND SHALL CONFORM INSTITUTES (ACI, AISC, SJI, ETC.) ARE APPLICABLE. ALL MATERIALS USED IN CONNECTION WITH LOT AREA REQUIRED: 6,000 sq. ft. 第12" _DECK isaac.rei@gmail.com THIS PROJECT MUST BE NEW MATERIALS UNLESS SPECIFIED OTHERWISE. RAIN WATER ACCUMULATION FOR IMPERVIOUS AREA ZONE A: LOT AREA PROVIDED: 9,557.7 sq. ft. 542.1X 3" / 12 X 100% RUN-OFF = 135.5 CU F 6) ALL CONCRETE SHALL BE 3,500 PSI, 28 DAY TEST MINIMUM 彩12" 7) FOUNDATIONS AND FOOTINGS SIZED FOR BEARING ON VIRGIN SOIL AT MINIMUM BEARING CAPACITY OF 2 TONS PER SQUARE FOOT WITH A MINIMUM OF 3'-0" OF EXISTING LOT WIDTH REQUIRED: 6' DIAMETER DRYWELL 22.34 CU. FT. PER LINER FT LOT WIDTH PROVIDED: 60' BRICK 8) ALL WOOD FRAMING INCLUDING JOISTS, BEAMS, POSTS, STUDS, ETC. TO BE DOUGLAS FIR NO.2 OR BETTER WITH: 135.5 / 22.34 = 6 LINER FT PAVEMENT PROVIDE 6' Ø X 6' DEEP DRYWELL Fb = 850 PSI, SINGULAR LOT DEPTH REQUIRED Fb = 1150 PIS, REPETITIVE LOT DEPTH PROVIDED: 155,69 NOTE: PROVIDED SEISMIC AND HURRICANE E TIES FOR ALL EXTERIOR FRAMING CONNECTIONS, SUBMIT SHOP DRAWINGS TO ARCHITECT FOR APPROVAL 6'Ø x 6 DEEP 9) ALL HEADERS TO BE SUPPORTED BY 4" X 4" POST (TYP.) As per chapter 492-3 Surface water retention; investigation and certification of compliance DRYWELL 30' or 200' Average Front Setback FRONT YARD REQUIRED(CORNER LOT): A. No new impervious area in excess of 200 square feet shall be permitted unless the 10) PROVIDE DOUBLE HEADERS AND TRIMMERS AT ALL STAIR AND FLOOR OPENINGS AND UNDER ALL POSTS AND PARTITIONS RUNNING PARALLEL TO SAME. PROPOSED applicant has demonstrated to the overseer, by, among other things, the taking of soil AVE. FRONT YARD @ MARGARET CT.: 11) BRIDGING TO BE EITHER SOLID OR 1" X 3" OR 18 GA. CROSS BRIDGING borings, that the site upon which the proposed project is to take place can provide the DRIVEWAY AVE. FRONT YARD @ ARRANDALE AVE.: 12) ALL HEADERS TO BE (2) 2" X 8" UNLESS OTHERWISE NOTED. EXPANSION EXITING FRONT YARD @ MARGARET CT.: 18.6' (Existing Non Conforming) 13) ALL TOP AND BOTTOM EDGES OF JOISTS MAY BE NOTCHED NOT TO EXCEED 2". C. No building permit shall be issued by the Building Department for the creation of any 66.3 SQ.F PROP. FRONT YARD @ MARGARET CT.: 18.6' (Variance Required) 14) ALL WINDOWS AND EXTERIOR DOOR OPENINGS WHERE BRICK VENEER OCCURS MUST BE PROVIDED WITH GALV. 3-1/2" X 5" X 5/16" STEEL LINTEL AT HEADER. new impervious area in excess of 200 square feet until the overseer has certified NEW compliance with this chapter. 15) JOISTS HANGERS, ETC. TO BE "TECO", "SIMPSON" OR EQUAL FOR ALL FLUSH STRUCTURAL CONNECTIONS. EXITING FRONT YARD @ ARRANDALE AVE.: 53.1' (Existing Non Conforming) STANDBY *NEW A/C 16) THE EXTERIOR SURFACE OF ALL FOUNDATION WALLS BELOW GRADE (EXCEPT SLAB AREAS) SHALL BE WATERPROOFED WITH AN ELASTIC COAL TAR BASE, SELF IGENERATOR JUNITS All soil boring test must comply with "492-5, 492-6 & 492-7" of village of great neck PRIMING BITUMINOUS PLASTIC CEMENT. PROPOSED subsurface investigation. 17) FOUNDATION DRAIN TILE, 4" Ø MIN. SET IN GRAVEL MUST BE PROVIDED AROUND THE EXTERIOR PERIMETER SIDE OF ALL FOOTING, ± 4" BELOW CONCRETE **REAR YARD REQUIRED:** SIDE YARD 25' +1/4 IN EXCESS OF 100' Any existing structures to be removed shall be legally disposed of off-site. Notes: FRONTYARD (155.69 + 162.90) / 2 = 159.2918) SMOKE-DETECTING ALARM DEVICES, INSTALLED IN CONFORMITY WITH SECTION 1060.10 OF NYS BUILDING CODE SHALL BE PROVIDED OUTSIDE EACH SEPARATE (159.29 - 100) / 4 = 14.82 + 25 = 39.82AREA OF 2nd All drainage to be piped directly to drywells with min. 4" ø pvc pipe. SLEEPING AREA, IN EACH SLEEPING SPACE AND ON EACH FLOOR LEVEL. THE COPYRIGHT OF THIS DRAWING IS VESTED IN HIN 50.3' (Ok) **PROPOSED REAR YARD:** STORY ADDITION 19) PROVIDE EXPANDABLE SPRAY-APPLIED POLYURETHANE FOAM SEALANT. CONTINUOUS @ WINDOW AND DOOR ROUGH OPENINGS. ENGINEERING PC AND IT MAY NOT BE REPRODUCED IN WHOLE OR PART OR USED FOR THE Drywells must maintain clear distance of 10.0' to building wall, sanitary sewer lines. 20) RECESSED LUMINAIRES IN THE ROOF & GARAGE CEILING ASSEMBLY SEALED TO 1CFM AIR MOVEMENT. domestic water line or other drywells and property lines and a minimum 5.0' clear MANUFACTURE OF ANY ARTICLE WITHOUT THE EXPRESS 21) PROVIDE WEATHER STRIPPING ON ALL EXTERIOR DOORS. distance to gas line. MIN. SIDE YARD REQUIRED: 0 THE COPYRIGHT HOLDERS \bigcirc **EXITING SIDE YARD PROVIDED:** 6.3' (Existing Non Conforming) Contractor of the record is responsible to call 811 dig for marking all underground utility 2. THIS DRAWING IS TO BE READ IN CONJUNCTION WITH ALL 1) ALL ELECTRICAL WORK SHALL BE PERFORMED BY A LICENSED ELECTRICAL CONTRACTOR AND SHALL CONFORM TO E3401 NYS CODES REGULATIONS. PROP. SIDE YARD PROVIDED: 6.3' (Variance Required) ARCHITECT'S, SERVICE ENGINEER'S DRAWINGS AND GRONT YARD 2) ALL OUTLETS ARE TO BE PLACED 12" AFF, O.C. SWITCHES ARE TO BE PLACED 48" AFF, O.C. UNLESS OTHERWISE NOTED. SPECIFICATIONS. Contractor of the record or owner is responsible to call survivors to stakeout the property 3) PROVIDE GFI - GFCI OUTLETS IN ACCORDANCE WITH SECTION 3802 OF THE NYS RES. CODE IN ALL BATHROOMS, KITCHEN, GARAGE AND 5 **BUILDING HEIGHT** 3. IT IS A VIOLATION OF THE NEW YORK STATE LAW FOR ANY MAX. HEIGHT PERMITTED: DRIVEWAY 4) RECEPTACLE PLACEMENT SHALL BE IN ACCORDANCE WITH SECTION 3801 OD THE NYS RES. CODE. NO POINT MEASURED HORIZONTALLY PROPOSED TOTAL MAX. HEIGHT PROVIDED: 27.0' (Ok) ALONG THE WALL SHALL BE MORE THAN 6' FROM A RECEPTACLE. 324,8 SQ.FT ROOF EXPANSION 5) NOT LESS THAN 75% OF THE LAMPS IN PERMANENTLY INSTALLED LIGHTING FIXTURES SHALL BE HIGH EFFICIENCY LAMPS "AS PER SECTION AREA 434.7 SQ.FT MAX. EAVES HEIGHT PERMITTED: 22.0 NEW YORK STATE UNIFORM CODE AND THE 2020 THE NEW YORK STONE CURB MAX. EAVES HEIGHT PROVIDED: 18.5' (Ok) Second . 6.3' EXISTING CONSTRUCTION NOTES SIDE YARD **BUILDING AREA:** 1) ALL DIMENSIONS ARE TO FACE OF GYP. BD. AND CENTERLINE COLUMNS, UNLESS SPECIFICALLY OTHERWISE NOTED. \bigcirc Max. Building Area permitted: 2) FINISH FLOOR ELEVATIONS ARE TO TOP OF CONCRETE, UNLESS NOTED OTHERWISE. ALL VERTICAL DIMENSIONS ARE REFERENCED FROM TOP OF CONCRETE, LAWN 20% of lot area. $.20 \times 9,557.7 = 1,911.4 \text{ sq. ft.}$ WITHIN (5) DAYS AFTER CONTRACT HAS BEEN AWARDED OTHERWISE CONTRACTOR WILL BE HELD RESPONSIBLE. NEW EGRESS 3) WHERE NO SPECIFIC DETAILS ARE SHOWN, CONSTRUCTIONS SHALL BE SIMILAR TO THAT INDICATED OR NOTED FOR SIMILAR CONDITIONS AND CASES OF Proposed Building Area: 1896.59sq.ft. or 19% of lot area. (Ok) WINDOW WELL 6. NO WORK TO COMMENCE UNTIL APPROVAL HAS BEEN CONSTRUCTION ON THIS PROJECT. R 4) CONTRACTOR TO VERIFY THE STRUCTURE BEFORE COMMENCING ANY WORK AND NOTIFY ARCHITECT OR P.E. OF ANY DISCREPANCY 5 TOTAL FLOOR AREA ALLOWED "CORNER LOT": (F.A.R.) 0.33 for first 6000 sq. ft. of lot area = 3,000 sq. ft CONCRETE TRENCH -0.15 for lot area in excess of 6,000 sq. ft. EXTING.STONE WALK 0.15 (9,557.7 - 6,000) = 533.65 sq. ft.BUILDING PLANNING & DESIGN CRITERIA BASE F.A.R. = 3,000 + 533.65 = 3,533.65 sq. ft. R 01- CLIMATIC AND GEOGRAPHIC DESIGN CRITERIA (R301.2) LONGITUDINAL SECTION CROSS SECTION FLOOR AREA PROVIDED: (See Floor Area Diagram & Calculations) **TABLE R301.2 (1)** SUBJECT TO DAMAGE FROM WINTER MAX. F.A.R. PROVIDED: 3,149.72 Sq Ft (Ok) WIND DESIGN TYPICAL TRENCH DRAIN DETAIL UNDERLAYMENT HAZARDS FREEZING ANNUAL Know what's **below**. DEBRIS ZONE CATEGORY WEATHERING DEPTH TERMITES REQUIRED Call before you dig. INDEX REGION NOT TO SCALE 575-155-J-a2 Parking in residence districts. 4 BEDROOMS - 3 PARKING SPACES REQUIRED 1500 OR < N/A SEVERE 36" MIN. MOD. / HEAVY 2 PARKING SPACES PROVIDED IN THE -----26.8**'**-DRIVEWAY 2 PARKING PROVIDED IN THE GARAGE THIS INFORMATION HAS BEEN OBTAINED FROM THE CODE ENFORCEMENT OFFICIAL OF THE LOCAL JURISTICTION AND THE NYS CODE MANUAL PROPOSED CHIMNEY 7.0' EXISTING FRONT COVER L REINFORCED CONCRETE COVER SLAB — TRAFFIC TOP (H-20 RATED) SIDE YARD 41.17 SQ.FT. CONCRETE COVER BELOW-**BUILDING AREA CALCULATIONS** FLOOR AREA CALCULATIONS GRADE (SEE PLAN) 1' MIN. 2' MAX. T.O. POOL COVER EL 15.0' CALCULATION - ALONG MARGARET COURT BLOCK PIPE (FOR SIZE AND INVERT SEE LAWN PVC INLET PIPE (FOR SIZE &INVERT SEE 50.0 50.0'/2=25.0' 200' AVERAGE FRONT SET BACK IS 25.0' PRECAST CONC. STORM DRAIN RINGS ALONG ARRANDALE AVENUE FOR DIAMETER AND DEPTH SEE PLAN 506 35.9 64.0' 64.0'/2=32.0' 200' AVERAGE FRONT SET BACK IS 32.0' -GEOTEXTILE 10.9' 10.9 FABRIC **BOTTOM** OF SEE PLAN MINIMUM TO CONCRETE 6' MIN. PENETRATION GROUND WATER INTO ACCEPTABLE PAVEMENT TC.85.67 VILLAGE OF GREAT NECK LEACHING MATERIAL BACKFILL UNDER AND BC.85.27 BUILDING DEPARTMENT AROUND DRYWELL WITH FEB 2 0 2025 _GRANULAR MATERIAL CONCRETE CURB BC.85.20 CONTAINING LESS THAN S74°54'00"W 60.43' ARRANDALE AVENUE VIRGIN STRATA 15% FINE SAND, SILT & CLAY. (SILT & CLAY RECEIVED FRACTION NOT EXCEED 5%) BC.85. TYPICAL DRYWELL DETAIL SSUED FOR FILING WITH DOB NOT TO SCALE 36.2 DESCRIPTION: FILING ISSUE PROJECT NAME & ADDRESS: PRE-EXISTING AVERAGE GRADE ELEVATIONS OF THE FOUR 1,858.61 Sq Ft **TOTAL GROSS 1st FL. AREA:** Proposed Two Story SCALE: 3/32"=1'-0" (IN FEET) CORNERS OF THE LOT SITE PLAN AREA 1:(existing main dwelling) 36.3' x 26.3'= 951.06 Sq Ft Extension, Interior & AREA 2:(existing main dwelling) $12.5' \times 6.8' = 85.13 \text{ Sq Ft}$ 87.71+87.36+87.80+87.70 0 5' 10' 12.5' x 15.0' = 187.34 Sq Ft 350.57 / 4 = 87.64AREA 3:(proposed 1story extension Exterior Renovation AREA 4:(existing main dwelling) $17.1' \times 6.1' = 104.31 \text{ Sq Ft}$ 3/32" = 1'-0" AREA 5:(existing main dwelling) $5.3' \times 4.1' = 21.67 \text{ Sq Ft}$ AVERAGE T.O. CURB ELEVATIONS @ BUILDING FRONTAGE 1.8' x2.3' = 2.05 Sq Ft AREA 6:(existing main dwelling) 2 Margaret Court AREA 7:(existing main dwelling) 4.4'x 2.3' = 10.04 Sq Ft $1.8' \times 2.3' = 2.05 \text{ Sq Ft}$ 1363.67 Sq FAREA 8:(existing main dwelling) 86.53+86.10+85.68+85.60 343.91/4 = 85.97Great Neck, NY 11024 USE 87.6' TO DETERMINE HEIGHT OF AREA 9:(proposed garage extension) 22.7' x 10.9'= 247.40 Sq Ft 1st STORY EXTENSION BUILDING 22.7' x10.9' = 247.40 Sq Ft AREA 10:(existing garage) **SCOPE OF WORK** SITE PLAN, ZONING TOTAL NET 1st FL. AREA: BUILDING AREA CALCULATION: Max. Building Area permitted: 20% of lot area. $.20 \times 9,557.7 = 1,911.4 \text{ sq. ft.}$ 1,858.61 Sq Ft - 200 Sq Ft (Garage) = 1,658.61 Sq Ft 2nd STORY EXTENSION **NOTES & DIAGRAMS** A. Main dwelling: 1,858.61sq.ft. NY STATE CERTIFYING STATEMENT PROPOSED TWO STORY EXTENSION TOTAL NET 2nd FL. AREA: 1,491.11 Sq F 41.17sq.ft 1,899.7 sq.ft. (19.8%) B. Front cover: PROPOSED INTERIOR AND EXTERIOR RENOVATION TOTAL AREA: I, HOOSHANG NEJATHAIM, PROFESSIONAL ENGINEER, NEW YORK LICENSE NO. 074902, HEREBY CERTIFY THAT THE DRAWINGS AND THE SPECIFICATIONS AREA 11:(existing main dwelling) 36.2' x 27.5'= 998.31 Sq Ft **FRONT COVER** PROPOSED DRIVEWAY EXPANSION AND REPLACEMENT WERE PREPARED BY ME OR BY MY EMPLOYEES UNDER MY DIRECT SUPERVISION ARE IN COMPLIANCE WITH THE APPLICABLE PROVISIONS OF THE NEW YORK $3.4' \times 0.5' = 1.55 \text{ Sq Ft}$ AREA 12:(existing main dwelling) N.T.S. 02/01/25 STATE UNIFORM FIRE PREVENTION AND BUILDING CODE AND THE NEW YORK STATE ENERGY CONSERVATION CONSTRUCTION CODE, AS CURRENTLY IN I.R. 10.9' x 22.2'= 241.68 Sq Fi AREA 13:(existing main dwelling) 10.9' x 22.2'= 241.68 Sq Ft AREA 14:(proposed 1story extension) DRIVEWAY EXPANSION 24010 THE DETERMINATION THAT THE PROPOSED WORK MEETS NYSECC IS BASED ON ATTACHED ENERGY ANALYSIS OBTAINED FROM U.S. DEPARTMENT OF ENERGY TOTAL NET FLOOR AREA: 1,658.61 Sq Ft (1st Fl.) + 1,491.11 Sq Ft (2nd Fl.) 3,149.72 Sq Ft

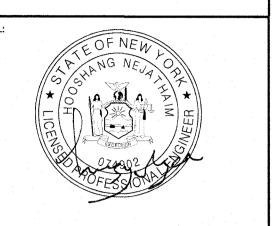

ARCHITECT OR P.E., TO ALTER ANY ITEM ON THESE DRAWINGS IN 4. ALL CONSTRUCTION SHALL BE IN ACCORDANCE WITH THE 2020

5. DRAWINGS ARE NOT TO BE SCALED, USE DIMENSIONS ONLY. CONTRACTOR SHALL CHECK ALL DIMENSIONS AND CONDITIONS AT JOB SITE, ANY DISCREPANCIES OR OMISSIONS FROM PLANS AND/OR SPECIFICATIONS MUST BE CALLED TO THE ATTENTION OF THE RECORD ARCHITECT/ENGINEER AND SAME CORRECTED

OBTAINED FROM DEPARTMENT OF BUILDINGS PERMITS HAVE BEEN

Dunage W

ALL RIGHTS RESERVED 2.20.2025

NOTES

WINDOW NOTES:

- 1. ALL WINDOW DIMENSIONS ARE APPROXIMATE. ALL WINDOW MANUFACTURER TO BE 'SIERRA PACIFIC H3 CASEMENT'. SHOULD OWNER CHOOSE AN ALTERNATE MFR. SPECIFIED SIZES ARE TO BE FOLLOWED AS CLOSELY AS POSSIBLE.
- ALL GLASS TO BE LOW "E" INSULATED GLASS. ARCHITECT IS TO BE SUPPLIED WITH SHOP DRAWINGS FOR ALL CUSTOM WINDOWS FOR
- APPROVAL, PRIOR TO ORDERING. 4. CONSULT EXTERIOR ELEVATIONS FOR WINDOWS THAT REQUIRE DIVIDED LIGHTS. SHOP DRAWINGS ARE TO INDICATE DIVIDED LIGHT DETAILS.
- ALL EXTERIOR COLOR OF WINDOW CLADDING TO BE CHOSEN BY OWNER PRIOR TO
- CONSULT EXTERIOR ELEVATIONS FOR HEIGHT OF WINDOWS ABOVE FINISHED FLOORS. 7. ALL WINDOWS ARE TO HAVE CLEAR PINE RETURNS & SILLS. MOLDING SURROUNDS MAY BE RESPECTIVE PRIOR TO ORDERING, G.C. IS TO ASSUME "DYKES" #241 FOR WINDOW
- ALL VENTING WINDOWS ARE TO HAVE INSECT SCREENS.
- 9. ALL WINDOWS TO BE SUPPLIED WITH STRAIGHT ARM OPERATORS. 10. ALL GLAZED OPENINGS TO BE PROTECTED FROM WIND-BORNE DEBRIS, AS REQUIRED BY THE NYS RESIDENTIAL CODE, MEETING REQUIREMENTS OF THE LARGE MISSLE TEST OF ASTM E 1996 AND OF ASTM E 1886. SEE ATTACHED MANUFACTURES SPECIFICATION.
- ALL FENESTRATION U-FACTOR INCLUDE GLAZED DOOR ARE TO MEET 0.35 (AS PER TABLE
- ALL GLAZED FENESTRATION SHGC INCLUDE GLAZED DOOR ARE TO MEET (DOUBLE GLAZED CLEAR) **0.7** (AS PER TABLE 303.1.3(3) ECCCNYS)
- ALL WINDOWS MEET PART 303 OD THE 2020 RESIDENTIAL CODE OF NYS FOR LIGHT & VENTILATION.
- $\langle \mathtt{C}
 angle$ of 24 inches. And Min. Opening width of 20 inches and Meet Part R310 of the code. - WINDOW CONTROL DEVISES REQUIRED FOR OPERABLE WINDOWS WITH SILL HEIGHT LOCATED LESS THAN 24 INCHES ABOVE FINISHED FLOOR AND GREATER THAN 72 INCHES ABOVE FINISHED GRADE. CONTROL DEVICES TO BE COMPLIANT WITH ASTM F 2090, WHICH WILL NOT REDUCE

- ALL EGRESS WINDOW HAVE A MIN CLEAR OPENING OF 5.7 SQ FT AND MIN. OPENING HEIGHT

- ALL WINDOWS IN BATHTUBS, SHOWERS, STAIRWELLS, DOORS AND WHIT IN 18" OF FINISHED FLOOR TO BE TEMPERED AS PER CODE SECTION R308.

DOOR NOTES:

ALL DOOR SWINGS SHOWN ON THE FLOOR PLANS ARE TO BE FOLLOWED.

THE NET CLEAR OPENING AREA TO LESS THAN REQUIRED FOR EMERGENCY EGRESS

- ALL EXTERIOR DOOR GLASS TO BE LOW "E" INSULATED GLASS. ALL CUSTOM DOORS ARE TO BE INCLUDED IN THE BID PRICE.
- 4. ALL GLASS PANELS ARE TO HAVE BEVELED EDGES.
- ALL POCKET DOORS ARE TO HAVE HEAVY DUTY 'GRANT HARDWARE. G.C. IS TO ASSUME ON STANDARD 'QUIKSET' HARDWARE IN BID.
- OWNER IS RESPONSIBLE TO PROVIDE ALL DECORATIVE GLASS.
- UNDERCUT DOORS 3/4" IN ALL CARPETED ROOMS. 9. PROVIDE WEATHER STRIPPING ON ALL EXTERIOR DOORS.

FIRESTOPPING & DRAFTSTOPPING **NOTES**

R302.11 Fireblocking

In combustible construction, fireblocking shall be provided to cut off both vertical and horizontal concealed draft openings and to form an effective fire barrier between stories, and between a top story and the roof space.

Fireblocking shall be provided in wood-framed construction in the following locations:

- 1. In concealed spaces of stud walls and partitions, including furred spaces and parallel rows of studs or staggered studs, as follows:
- 1.2. Horizontally at intervals not exceeding 10 feet (3048 mm). 2. At interconnections between concealed vertical and horizontal spaces such as occur at soffits,
- drop ceilings and cove ceilings. 3. In concealed spaces between stair stringers at the top and bottom of the run. Enclosed spaces
- under stairs shall comply with Section R302.7 4. At openings around vents, pipes, ducts, cables and wires at ceiling and floor level, with an
- approved material to resist the free passage of flame and products of combustion. The material filling this annular space shall not be required to meet the ASTM E136 requirements.
- 5. For the fireblocking of chimneys and fireplaces, see Section R1003.19. 6. Fireblocking of cornices of a two-family dwelling is required at the line of dwelling unit separation.

R302.11.1 Fireblocking Materials

1.1. Vertically at the ceiling and floor levels.

- Except as provided in Section R302.11, Item 4, fireblocking shall consist of the following materials. 1. Two-inch (51 mm) nominal lumber.
- 2. Two thicknesses of 1-inch (25.4 mm) nominal lumber with broken lap joints. 3. One thickness of 23/32-inch (18.3 mm) wood structural panels with joints backed by 23/32-inch (18.3 mm) wood structural panels. 4. One thickness of 3/4-inch (19.1 mm) particleboard with joints backed by 3/4-inch (19.1 mm)
- particleboard. 5. One-half-inch (12.7 mm) gypsum board. 6. One-quarter-inch (6.4 mm) cement-based millboard.
- 7. Batts or blankets of mineral wool or glass fiber or other approved materials installed in such a manner as to be securely retained in place. 8. Cellulose insulation installed as tested in accordance with ASTM E119 or UL 263, for the specific

R302.11.1.1 Batts or Blankets of Mineral or Glass Fiber

Batts or blankets of mineral or glass fiber or other approved nonrigid materials shall be permitted for compliance with the 10-foot (3048 mm) horizontal fireblocking in walls constructed using parallel rows of studs or staggered studs.

R302.11.1.2 Unfaced Fiberglass

application.

Unfaced fiberglass batt insulation used as fireblocking shall fill the entire cross section of the wall cavity to a height of not less than 16 inches (406 mm) measured vertically. Where piping, conduit or similar obstructions are encountered, the insulation shall be packed tightly around the obstruction.

R302.11.1.3 Loose-Fill Insulation Material

Loose-fill insulation material shall not be used as a fireblock unless specifically tested in the form and manner intended for use to demonstrate its ability to remain in place and to retard the spread of fire and hot gases.

R302.11.2 Fireblocking Integrity

The integrity of fireblocks shall be maintained.

R302.12 Draftstopping

In combustible construction where there is usable space both above and below the concealed space of a floor-ceiling assembly, draftstops shall be installed so that the area of the concealed space does not exceed 1,000 square feet (92.9 m2). Draftstopping shall divide the concealed space into approximately equal areas. Where the assembly is enclosed by a floor membrane above and a ceiling membrane below, draftstopping shall be provided in floor-ceiling assemblies under the following circumstances:

Ceiling is suspended under the floor framing. Floor framing is constructed of truss-type open-web or perforated members.

R302.12.1 Materials

Draftstopping materials shall be not less than 1/2-inch (12.7 mm) gypsum board, 3/8-inch (9.5 mm) wood structural panels or other approved materials adequately supported. Draftstopping shall be installed parallel to the floor framing members unless otherwise approved by the building official. The integrity of the draftstops shall be maintained.

WINDOW SCHEDULE


WIN. NO.	SIZE		MODEL		
	WIDTH (ROUGH OPENING)	HEIGHT (ROUGH OPENING)	NO.	REMARKS	

FIRST FLOOR


101	4'-5 1/16 "	2'-8"	CX145	CASEMENT WINDOW BY ANDERSEN 400 SERIES
102	4'-0 1/2 "	2'-8"	CX14	CASEMENT WINDOW BY ANDERSEN 400 SERIES
103	5'-0 3/8 "	4'-9"	CW25	CASEMENT WINDOW BY ANDERSEN 400 SERIES
104	5'-5 5/16 "	4'-9"	CW235	CASEMENT WINDOW BY ANDERSEN 400 SERIES
105	5'-0 3/8 "	4'-9"	CW25	CASEMENT WINDOW BY ANDERSEN 400 SERIES

SECOND FLOOR


201	4'-5 5/16 "	6'-0 3/8"	C345	CASEMENT WINDOW BY ANDERSEN 400 SERIES
202	4'-0 1/2 "	2'-8"	CX14	CASEMENT WINDOW BY ANDERSEN 400 SERIES (E)
203	4'-0 1/2 "	2'-8"	CX14	CASEMENT WINDOW BY ANDERSEN 400 SERIES
204	3'-0 7/16 "	1'-9"	CN13	CASEMENT WINDOW BY ANDERSEN 400 SERIES (T)
205	4'-5 5/16 "	5'-3 1/4"	CX245	CASEMENT WINDOW BY ANDERSEN 400 SERIES (E)
206	4'-5 5/16 "	5'-3 1/4"	CX245	CASEMENT WINDOW BY ANDERSEN 400 SERIES (E)
207	4'-5 5/16 "	5'-3 1/4"	CX245	CASEMENT WINDOW BY ANDERSEN 400 SERIES (E)
208	4'-5 5/16 "	6'-0 3/8"	C345	CASEMENT WINDOW BY ANDERSEN 400 SERIES
209	4'-0 1/2 "	2'-8"	CX14	CASEMENT WINDOW BY ANDERSEN 400 SERIES (T)
210	4'-5 5/16 "	5'-3 1/4"	C245	CASEMENT WINDOW BY ANDERSEN 400 SERIES (T)

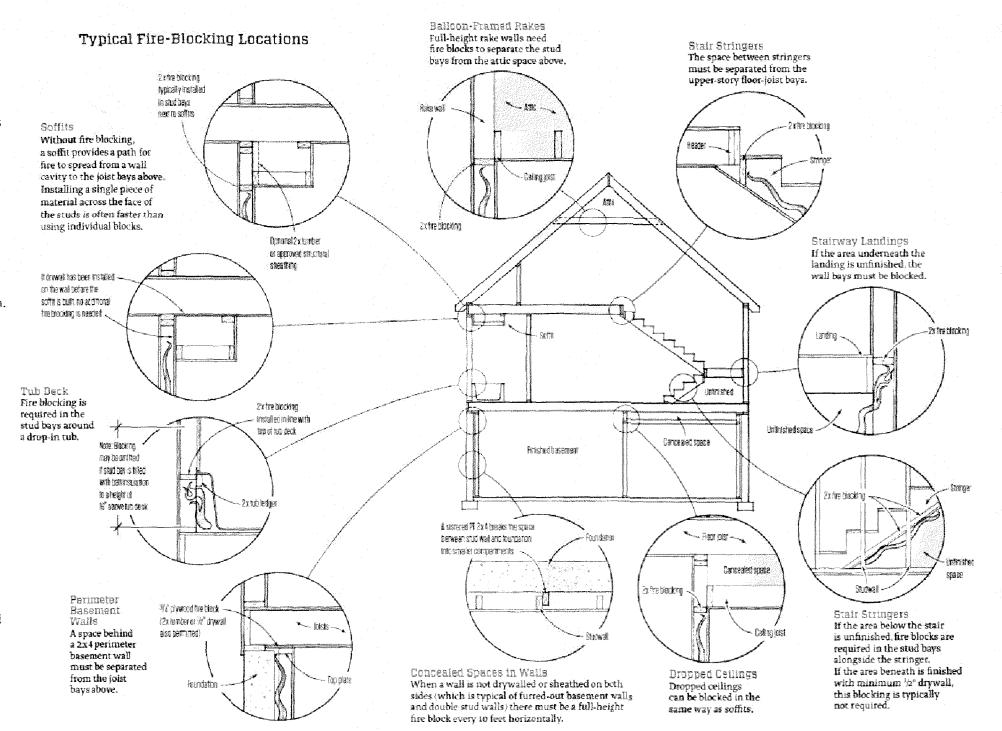


PLUMBING RISER DIAGRAM

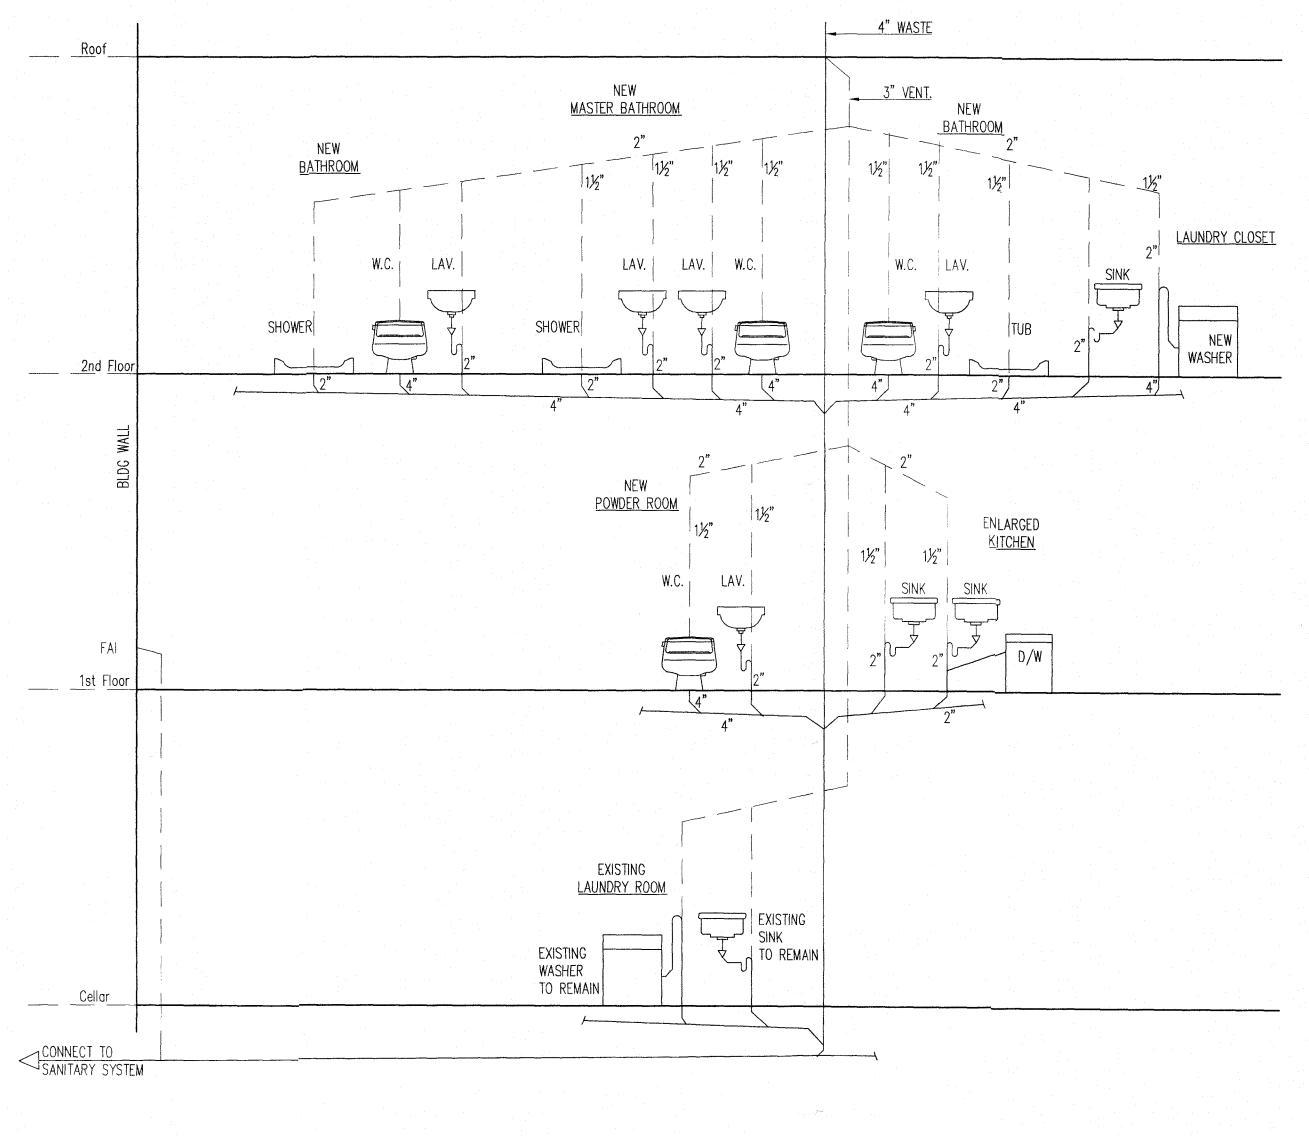


GAS RISER DIAGRAM

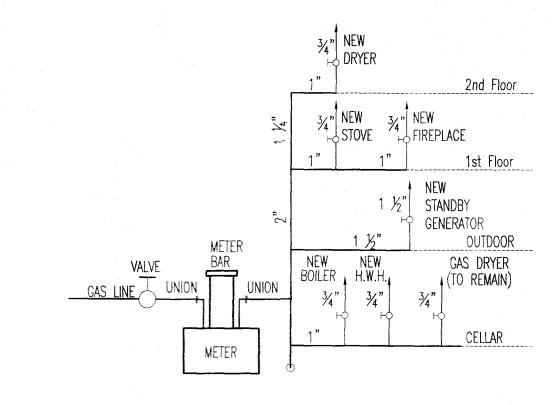


DRYER ROOF VENT DETAIL

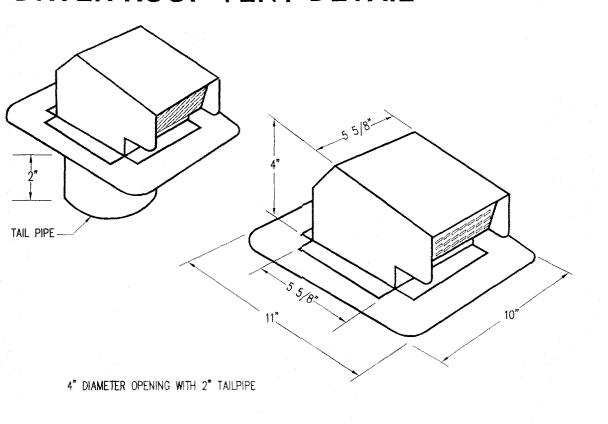

PIPING INSULATION DETAIL

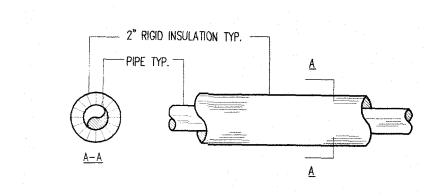


AIR HANDLER DETAIL

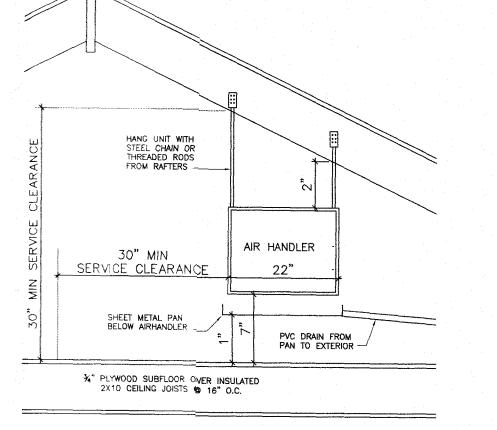

HN Engineering PC 36 Ruxton Road Great Neck, NY 11023 T. 516-209-7772

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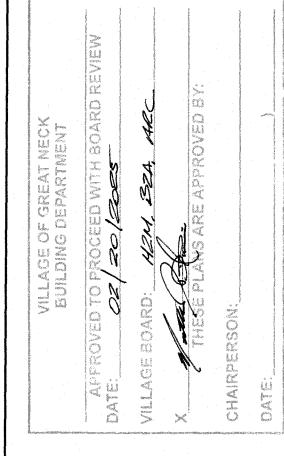
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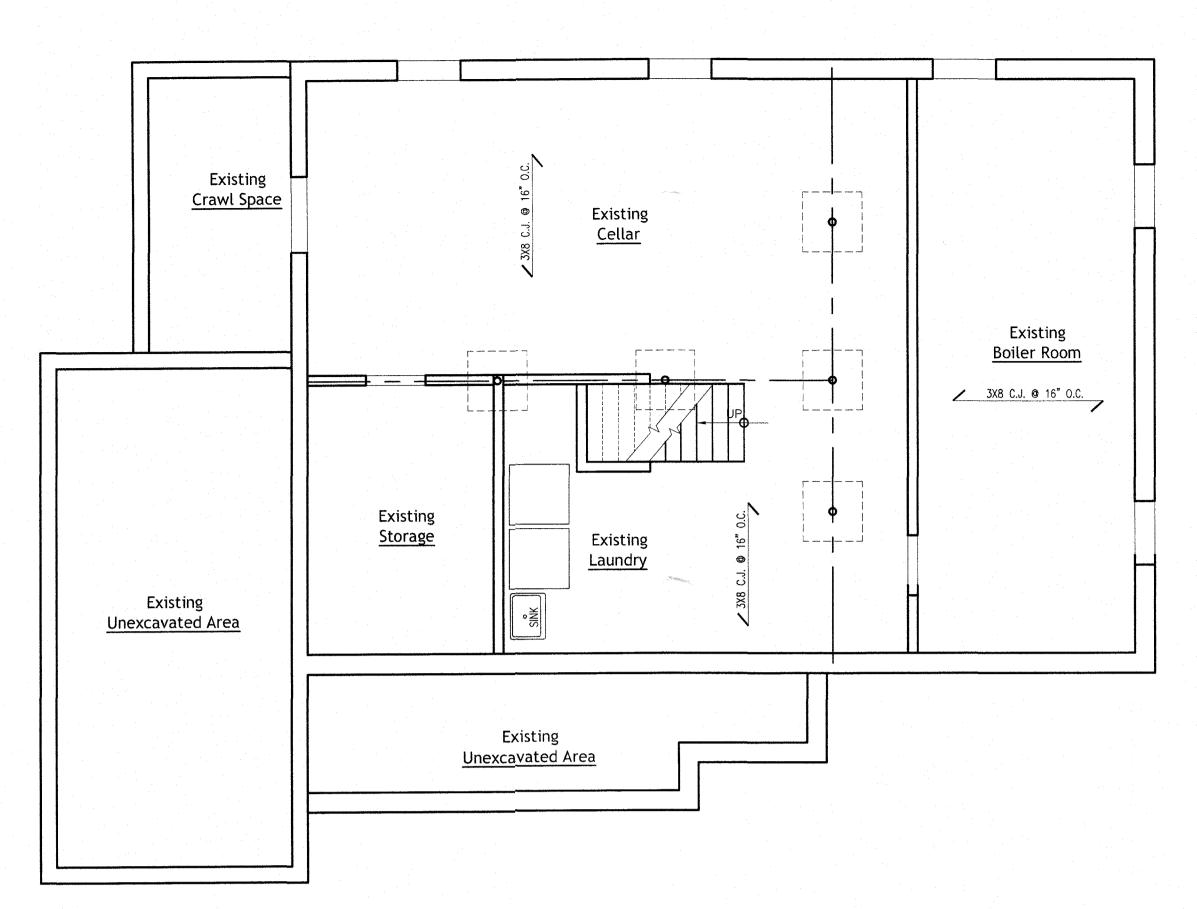
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Proposed Two Story Extension, Interior &

Exterior Renovation 2 Margaret Court Great Neck, NY 11024

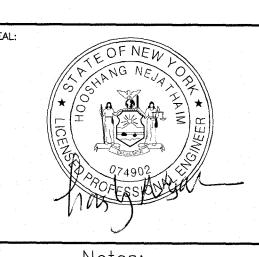
RISER DIAGRAMS NOTES & DETAILS SCHEDULES

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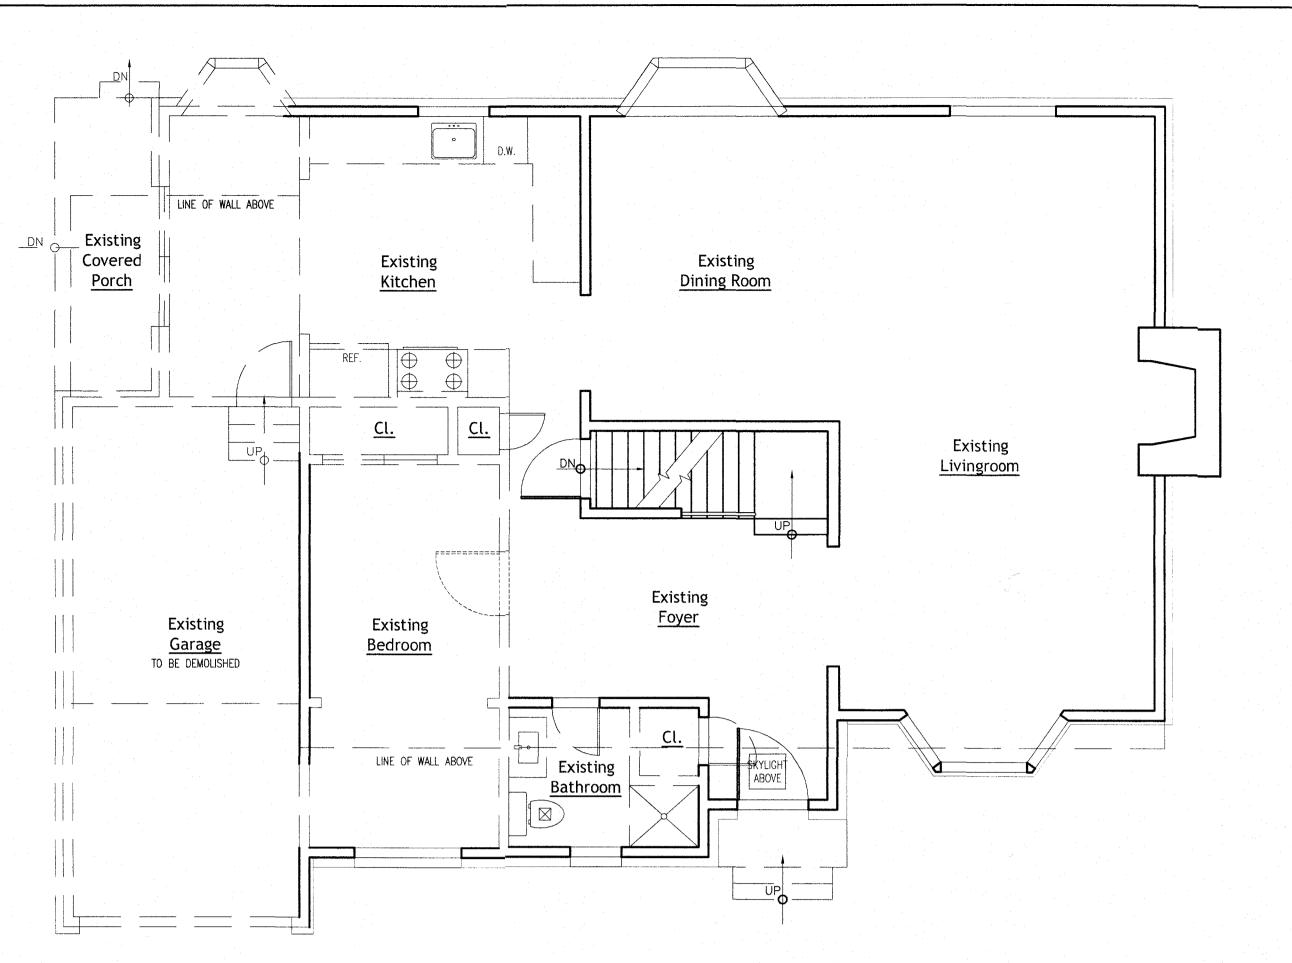
EXISTING CELLAR PLAN

1/4" = 1'-0"




EXISTING/DEMO SECOND FLOOR PLAN

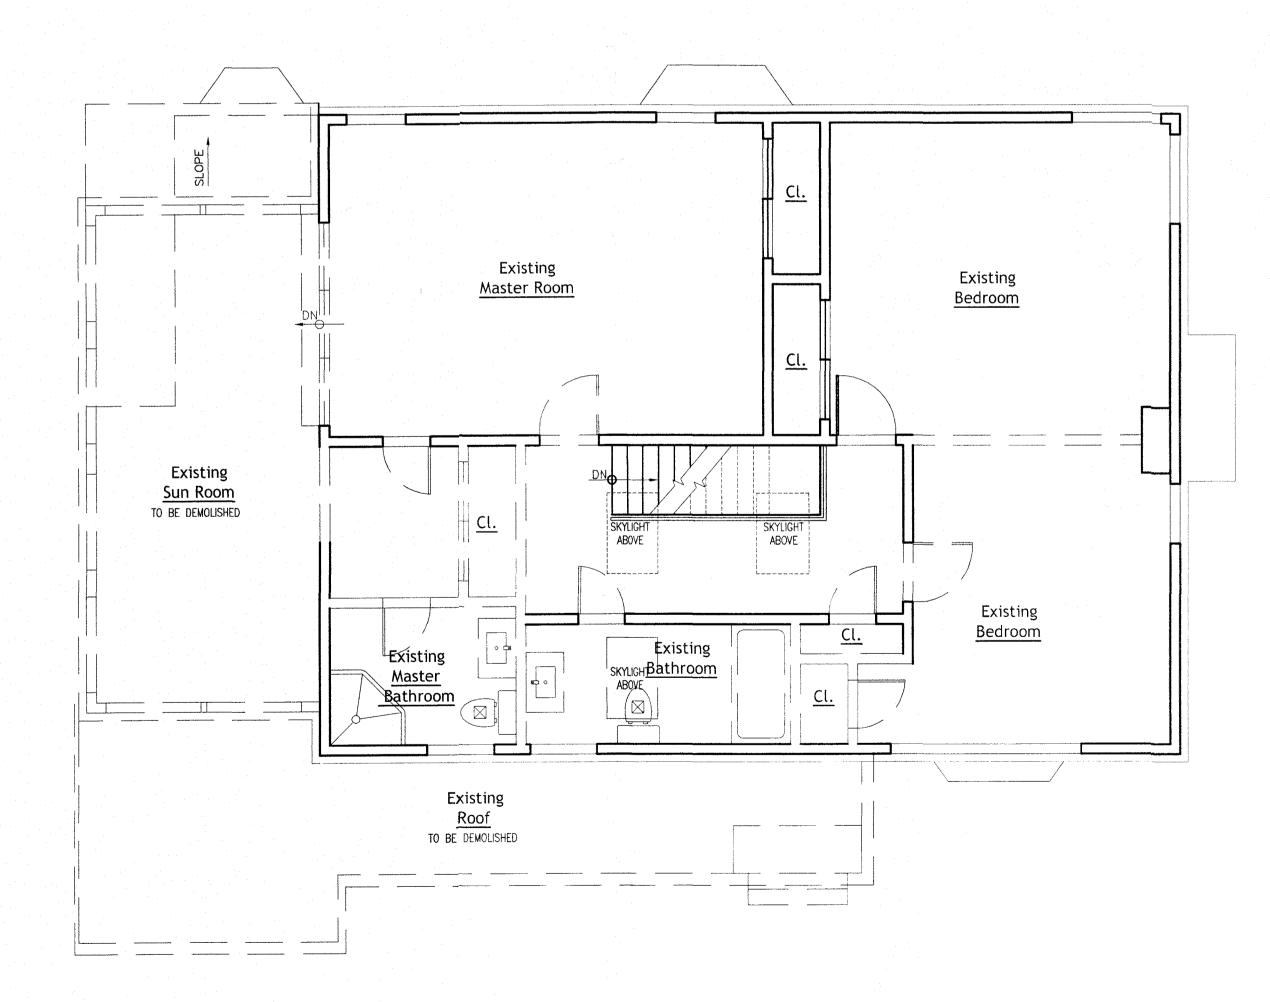1/4" = 1'-0"



EXISTING/DEMO FIRST FLOOR PLAN

1/4" = 1'-0"

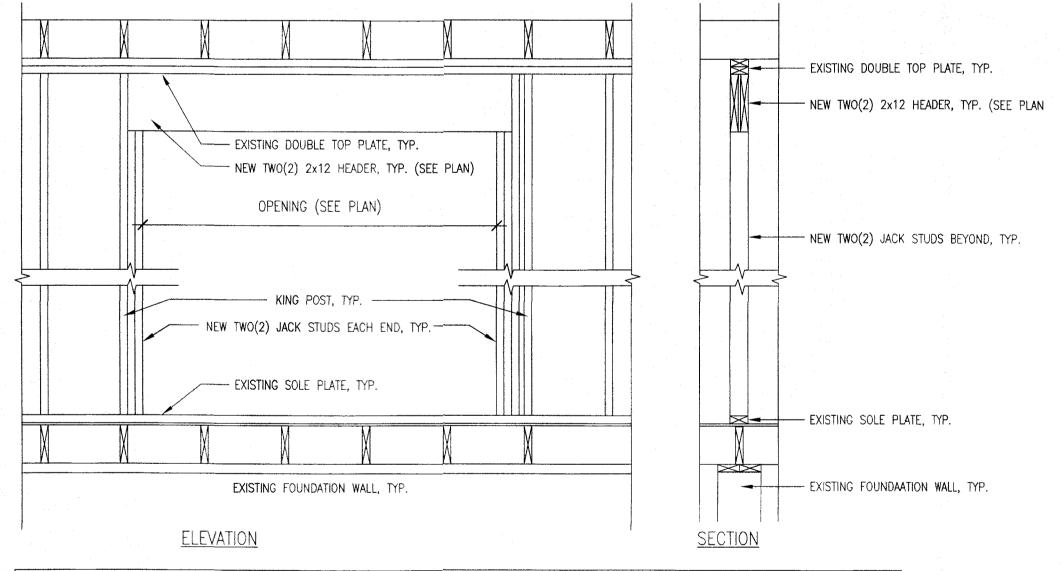

NOTE: OPENINGS IN INTERIOR BEARING PARTITION SHALL COMPLY WITH NYS BC 2308.5.5.2 AND NYS RESIDENTIAL CODE TABLE R602.7(2).

TYPICAL OPENING @ LOAD BEARING WALLS DETAIL [/] N.T.S.

LEGEND

EXISTING WALLS TO BE REMOVED

EXISTING WALLS TO REMAIN

STRUCTURAL NOTES


- PROVIDE DOUBLE FLOOR JOISTS UNDER WALLS ABOVE AND BATHROOMS. - PROVIDE TRIPLE CEILING JOISTS UNDER ROOF CONCENTRATED LOADS.
- ALL WOOD FLOOR AND CEILING JOISTS ARE TO BE DOUGLAS FIR NO.2 OR BETTER.
- ALL HEADERS TO BE (2) 2" X 10" UNLESS OTHERWISE NOTED.
 CONTRACTOR IS RESPONSIBLE TO PROVIDE TEMPORARY SHORING PRIOR TO INSTALLATION OF STEEL BEAMS.

CONTRACTOR TO VERIFY THE STRUCTURE BEFORE COMMENCING ANY WORK AND NOTIFY P.E. OF ANY DISCREPANCY



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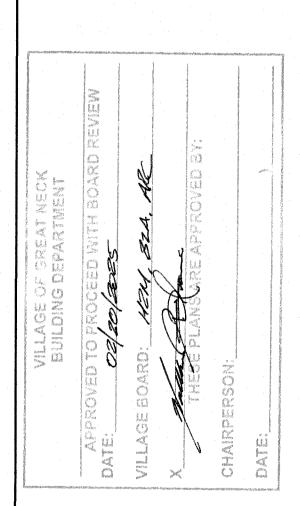
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WITHIN (5) DAYS AFTER CONTRACT HAS BEEN AWARDED
OTHERWISE CONTRACTOR WILL BE HELD RESPONSIBLE.

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VILLAGE OF GREAT NECK **BUILDING DEPARTMENT**

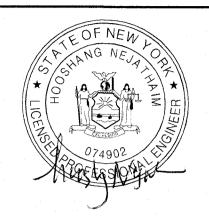

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Proposed Two Story Extension, Interior & Exterior Renovation

2 Margaret Court Great Neck, NY 11024

EXISTING / DEMOLITION FLOOR PLANS

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APPLIED 2.0" CONTINUOUS THICK CLOSED -SPRAY FOAM R-13 TO ENTIRE NEW CRAWL SPACE EXISTING CONC. FOUNDATION WALLS. EXISTING WALL TO REMAIN EXISTING EXTERIOR WALL TO REMAIN **NEW EXTERIOR WALL** STUCCO VENEER WITH 1.5" EPS FOAM BOARD (R-3) OVER 3/4" PLYWOOD SHEATHING & ONE LAYER OF #15 BUILDERS PAPER SECURED TO DOUGLAS FIR NO.2 2X6 WOOD STUDS @ 16" O.C. WITH R-19 BATT INSULATION, ONE LAYER OF %" TYPE X' GYP BD SCREWED TO STUDS, TAPED, SPACKLED, SANDED & READY FOR PAINTING. ONE HOUR FIRE RATED. EXISTING WALL WITH R-15 BATT INSULATION, ONE LAYER OF %" TYPE X' GYP BD . ONE HOUR FIRE RATED. 2X4 DOUGLAS FIR NO.2 WOOD STUDS @ 16" OC WITH $\frac{5}{8}$ " TYPE 'X' GWB BOTH SIDES, TAPED, SPACKLED, SANDED & READY FOR PAINTING. ONE HOUR FIRE RATED. **NEW LOAD BEARING WALL:** 2X4 DOUGLAS FIR NO.2 WOOD STUDS @ 16" OC WITH DOUBLE TOP PLATES & %" TYPE 'X' GWB BOTH SIDES, TAPED, SPACKLED, SANDED & READY FOR PAINTING. ONE

STRUCTURAL MEMBER

INTERCONNECTED HARDWIRED SMOKE & CARBON MONOXIDE

INTERCONNECTED HARDWIRED SMOKE & CARBON MONOXIDE

INTERCONNECTED HARDWIRED HEAT DETECTOR ALARM


65 CFM FAN DUCTED TO EXTERIOR


COMBO ALARM

HOUR FIRE RATED.


DIRECTION OF FRAMING


AREA DRAIN

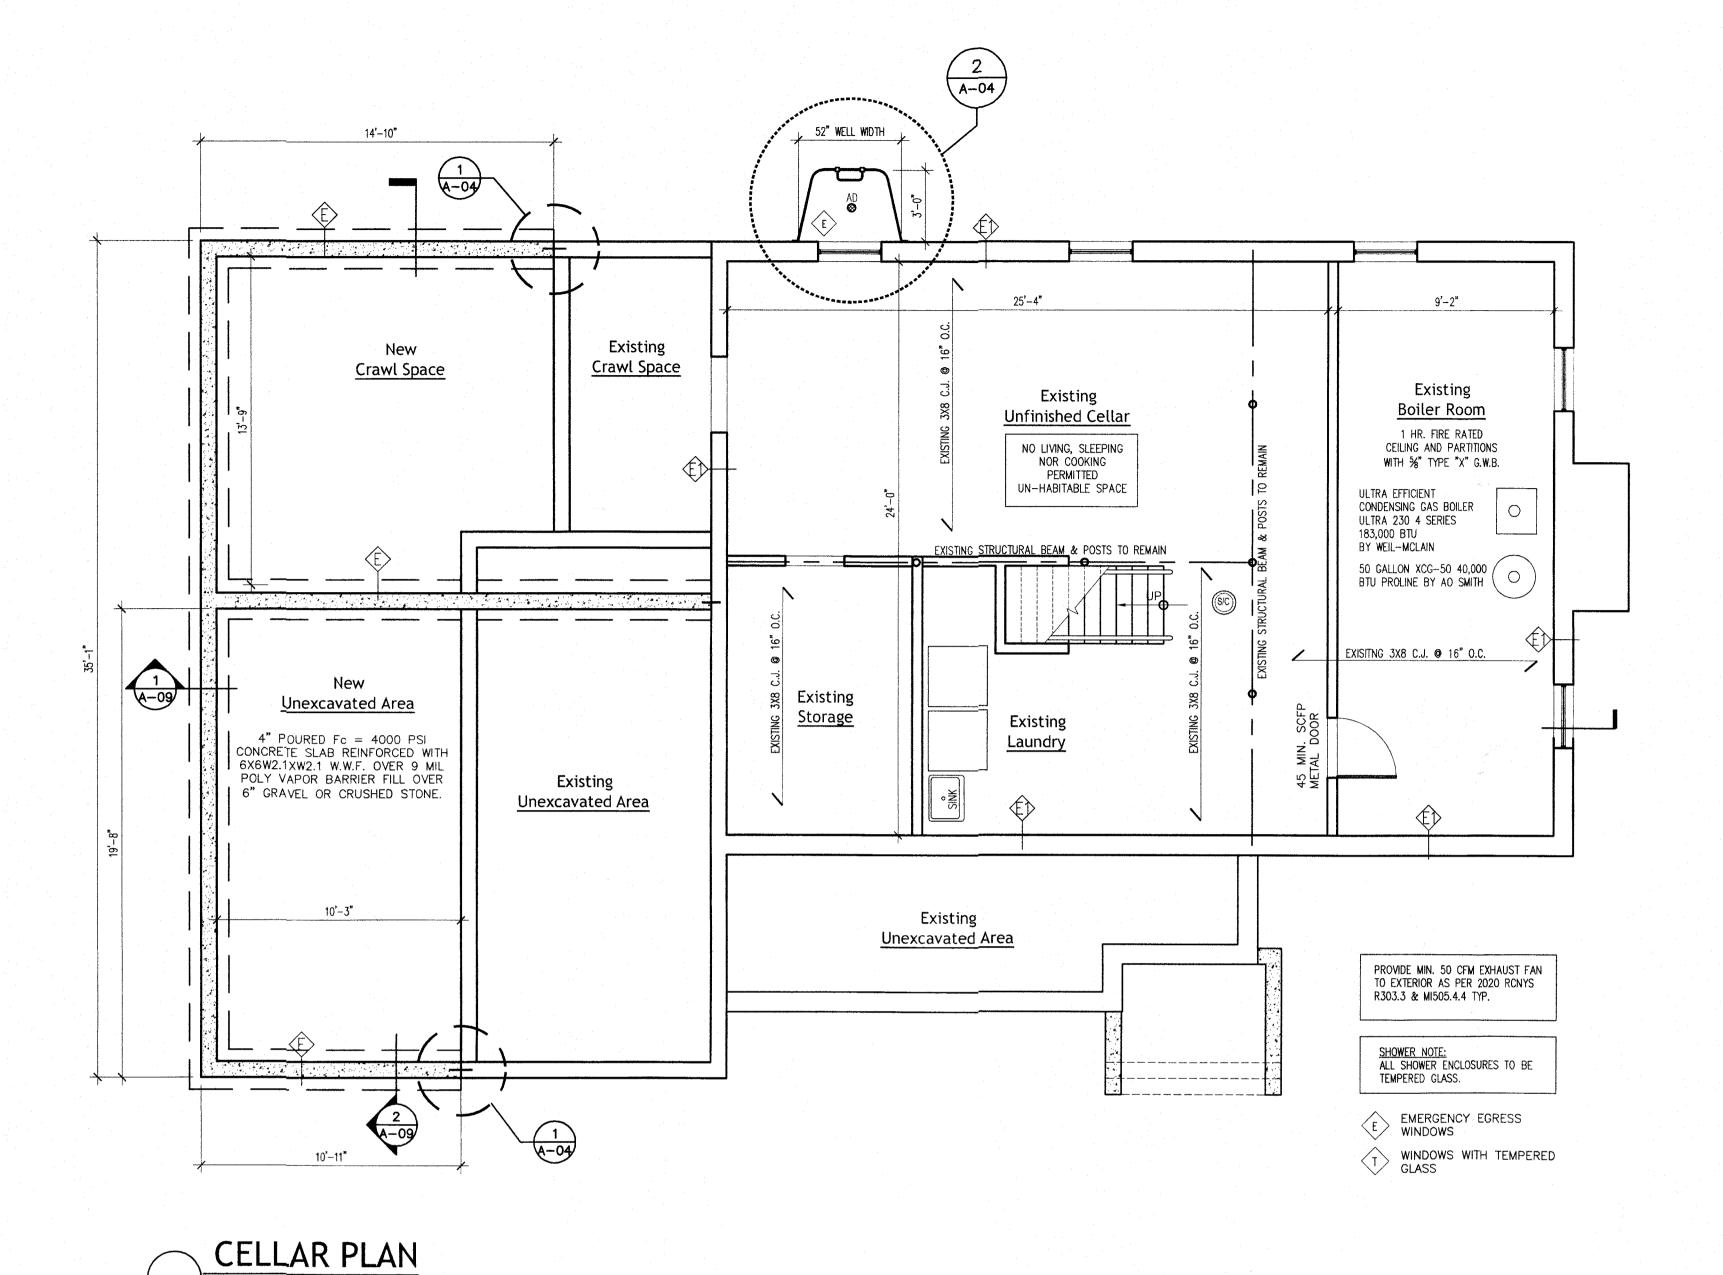

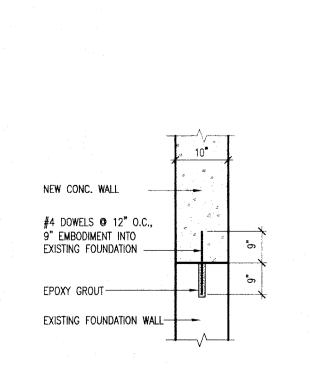


1/4" = 1'-0"

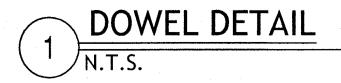

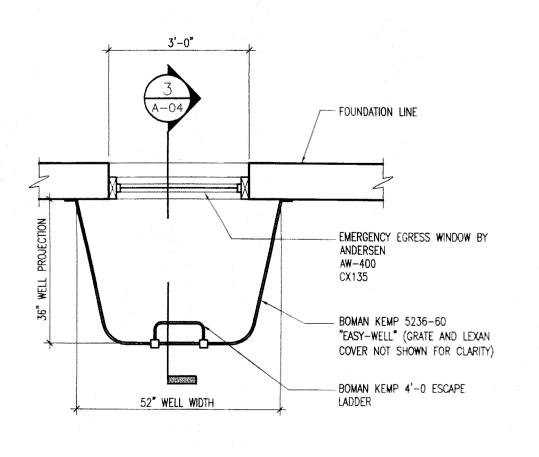

PLANE VIEW @ WINDOW WELL

1/2" = 1'-0"

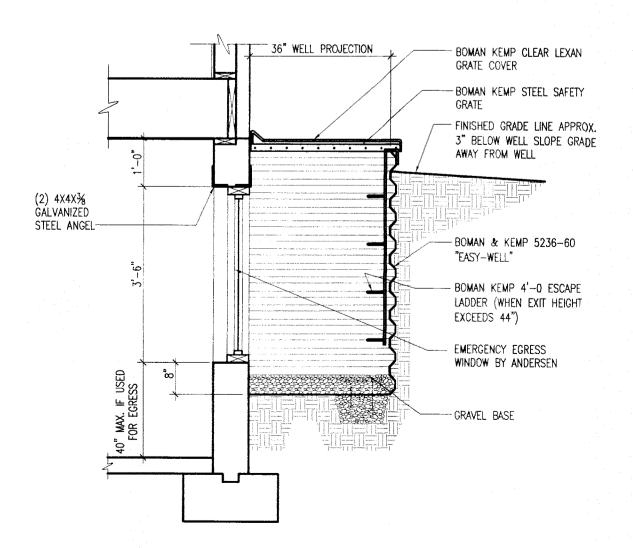


3 SECTION DETAIL @ WINDOW WELL

1/2"= 1'-0"



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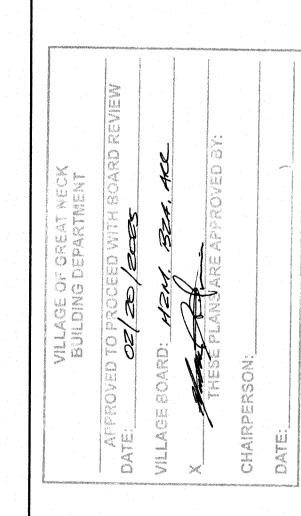
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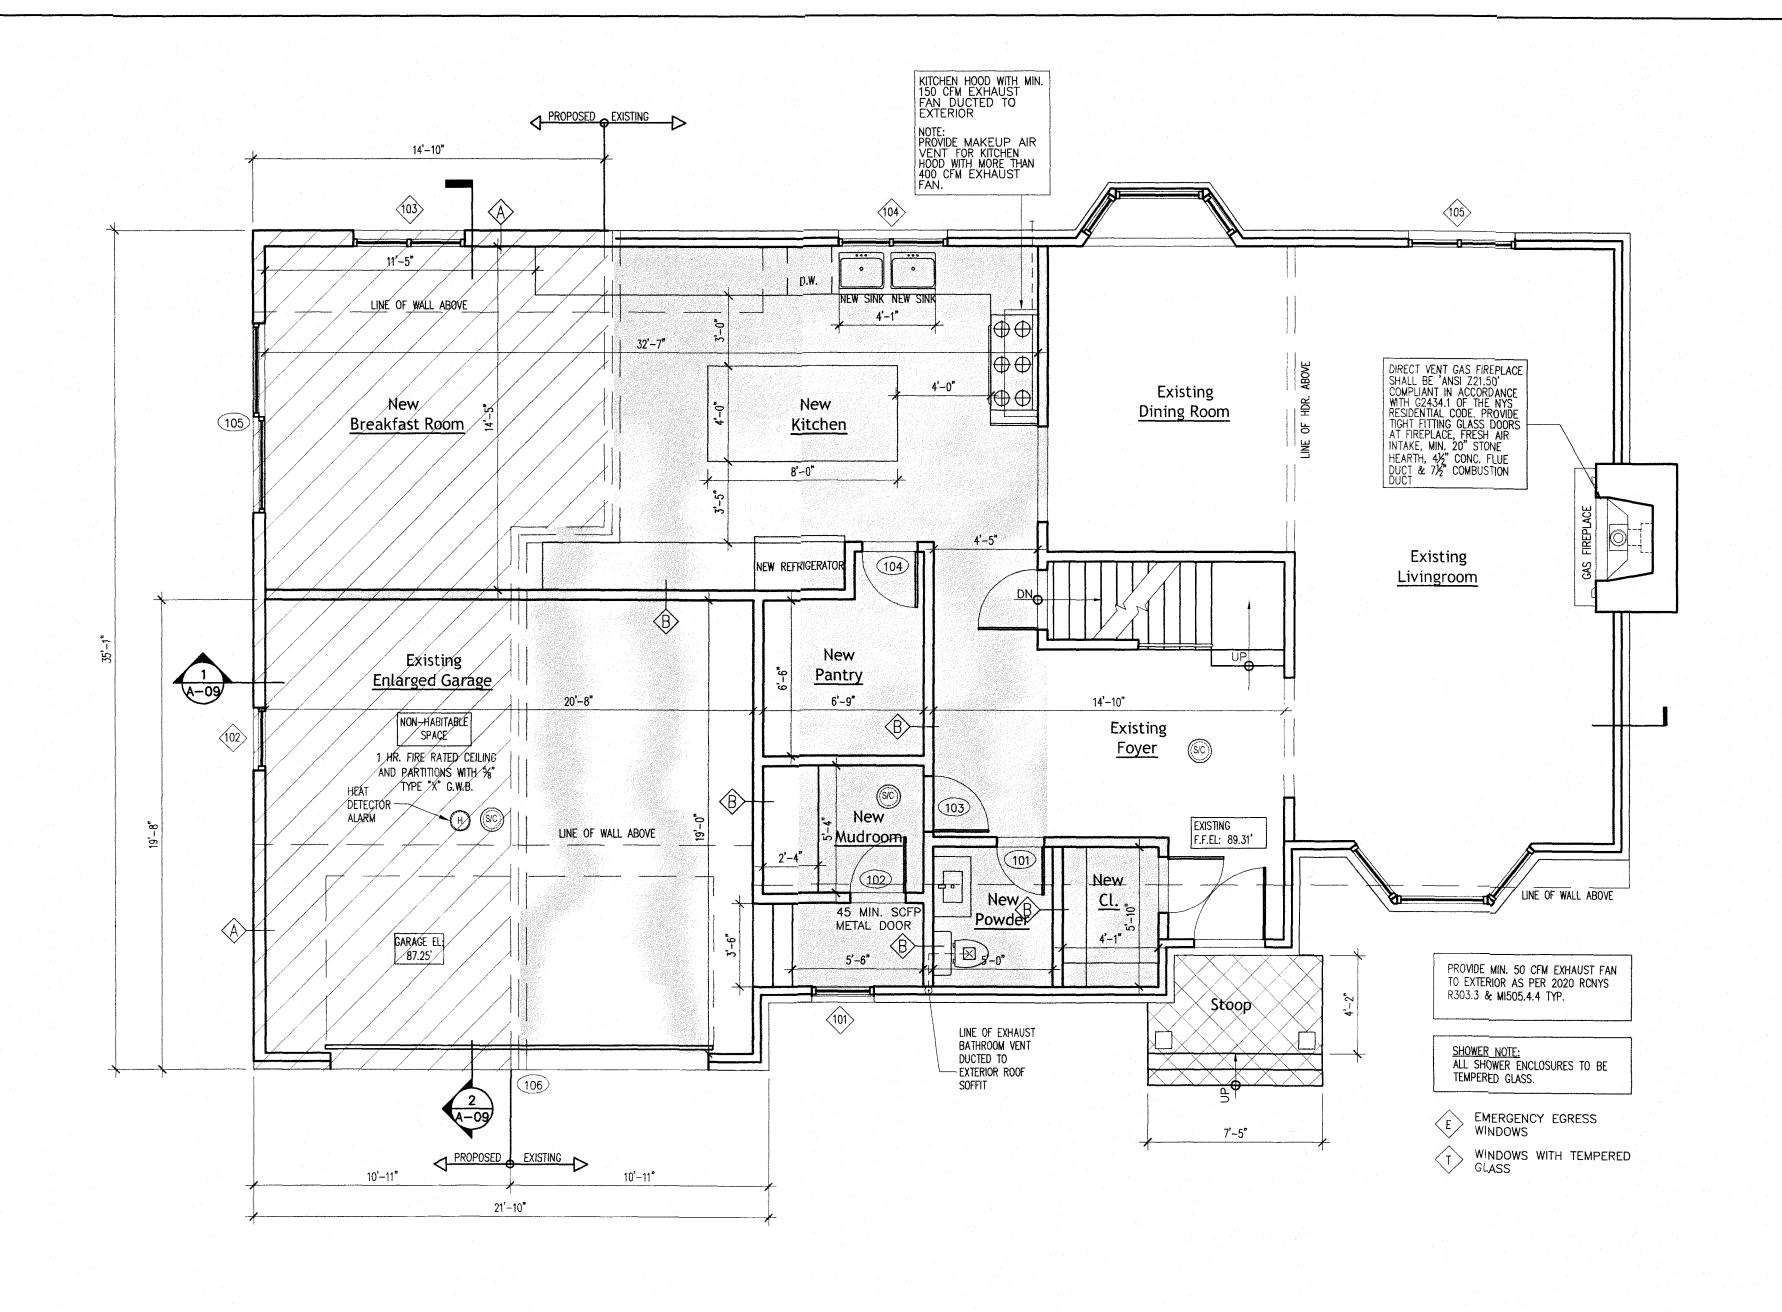
PROJECT NAME & ADDRESS:
Proposed Two Story
Extension, Interior &
Exterior Renovation
2 Margaret Court
Great Neck, NY 11024

CELLAR PLAN
NOTES & DETAILS

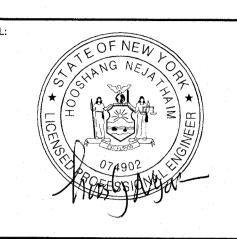DATE: DRAWN: 02/01/25 I.R.

PROJECT NO: DRAWING NO: A-04

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AREA OF FRONT COVERED PORCH - 38.24 SQ. FT.

AREA OF INTERIOR WORK - 701 SQ. FT.


AREA OF 1ST FLOOR EXTENSION - 434.74 SQ. FT.

TOTAL= 1135.74 SQ. FT.



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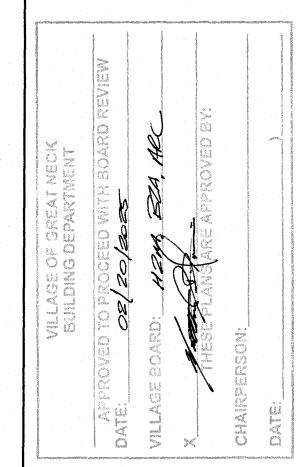
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VILLAGE OF GREAT NECK BUILDING DEPARTMENT

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FIRST FLOOR PLAN NOTES & DETAILS

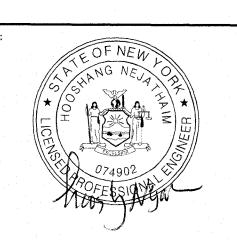
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PROPOSED SECOND FLOOR PLAN

1/4" = 1'-0"

AREA OF INTERIOR WORK - 1241.54 SQ.FT.


AREA OF 2nd FLOOR EXTENSION - 241.68 SQ.FT.

TOTAL = 1491.1 SQ.FT.

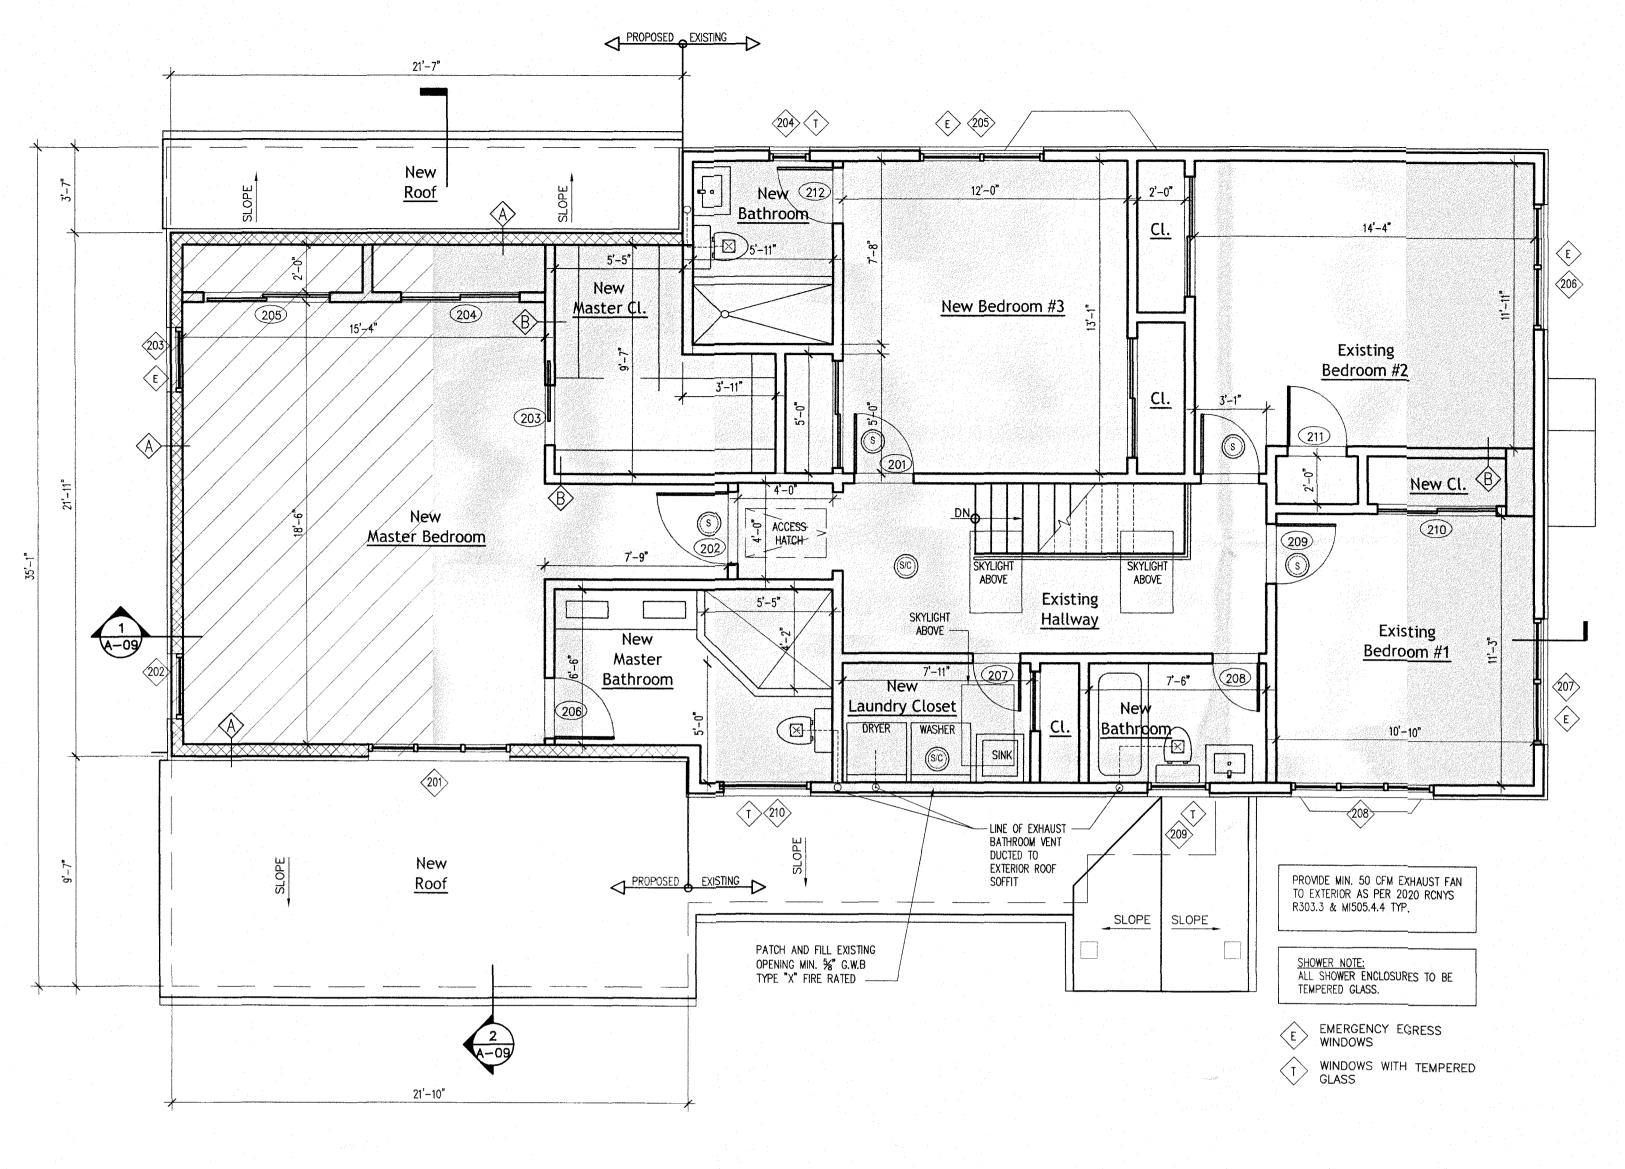

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SECOND FLOOR PLAN NOTES & DETAILS

SCALE AT A1:

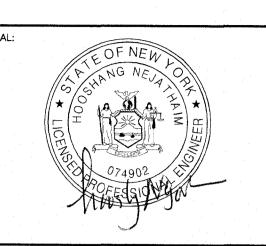N.T.S.

PROJECT NO:

24010

DATE:


02/01/25

I.R.

DRAWING NO:


A-06

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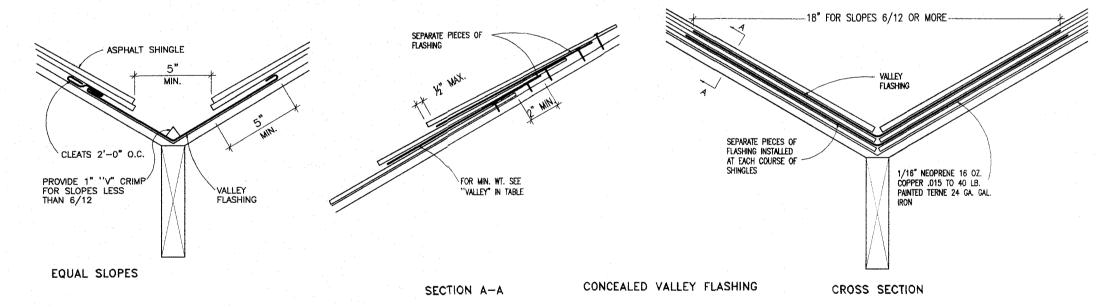


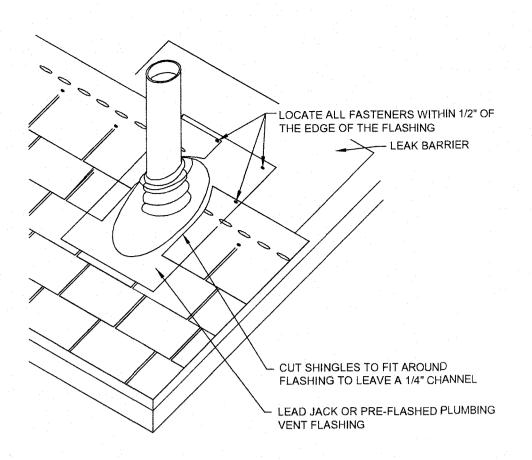
NOTES:
1.) INSTALL 24" WEATHERWATCH OR STORMGUARD LEAK BARRIER TARGET SHEET.
2.) DO NOT FACE NAIL THE PLUMBING VENT FLASHING.

PLUMBING VENT FLASHING DETAIL N.T.S.

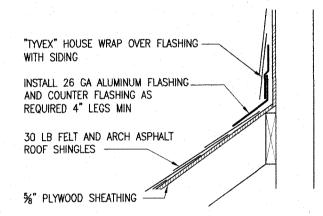

FLASHING DETAIL



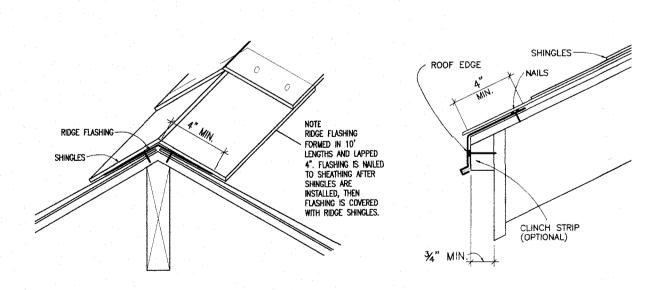

GENERAL FLASHING NOTES:


- ALL SIZES AND WEIGHTS OF MATERIAL GIVEN IN "MINIMUM THICKNESS (GAUGES OR WEIGHT) FOR COMMON FLASHING CONDITIONS" TABLE ARE MINIMUM. ACTUAL CONDITIONS MAY REQUIRE GREATER STRENGTH.
 ALL GALVANIZED STEEL MUST BE PAINTED.
 WITH LEAD FLASHING USE 16 OZ. COPPER CLEATS. IF ANY PART IS EXPOSED, USE
- 3# LEAD CLEATS.
 4. COAT ZINC WITH ASPHALTUM PAINT WHEN IN CONTACT WITH REDWOOD OR CEDAR.
 HIGH ACID CONTENT (IN THESE WOODS ONLY) DEVELOPS STAINS.
- 5. TYPE 302 STAINLESS STEEL IS AN ALL PURPOSE FLASHING TYPE.
 6. USE ONLY ALUMINUM MANUFACTURED FOR THE PURPOSE OF FLASHING.
 7. SEE MANUFACTURER'S LITERATURE FOR USE AND TYPES OF FLASHING.
 8. IN GENERAL, CLEATS WILL BE OF THE SAME MATERIAL AS FLASHING, BUT HEAVIER
- WEIGHT OR THICKER GAUGE.

 9. IN SELECTING METAL FLASHING, PRECAUTION MUST BE TAKEN NOT TO PLACE FLASHING IN DIRECT CONTACT WITH DISSIMILAR METALS THAT CAUSE ELECTROLYSIS.

 10. SPACES MARKED WITH AN "X" IN THE TABLE ARE USES NOT RECOMMENDED FOR THAT MATERIAL.


TYPICAL ROOF FLASHING NOTES & DETAIL

/ N.T.

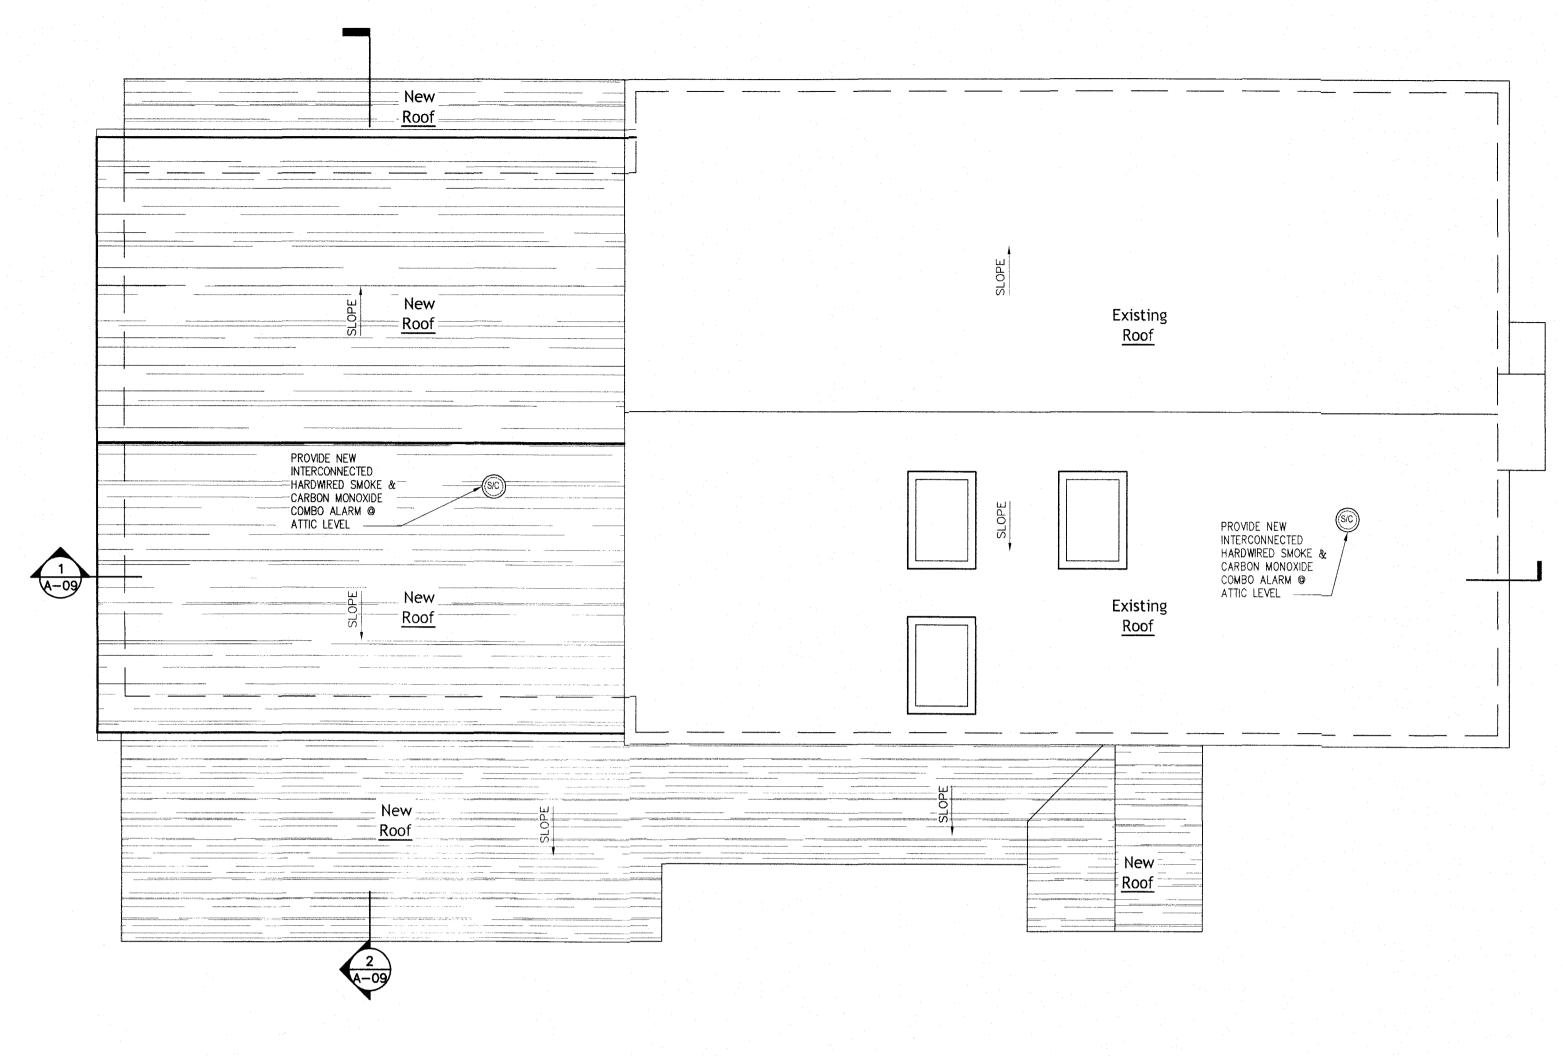

PROPOSED ROOF PLAN

1/4" = 1'-0"

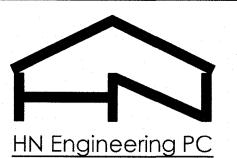


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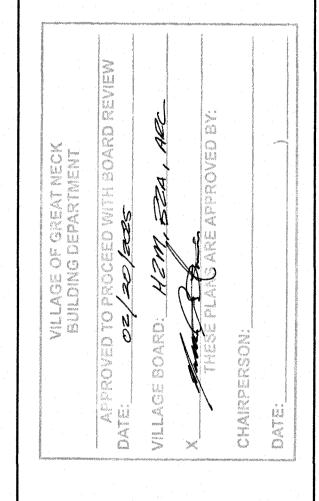
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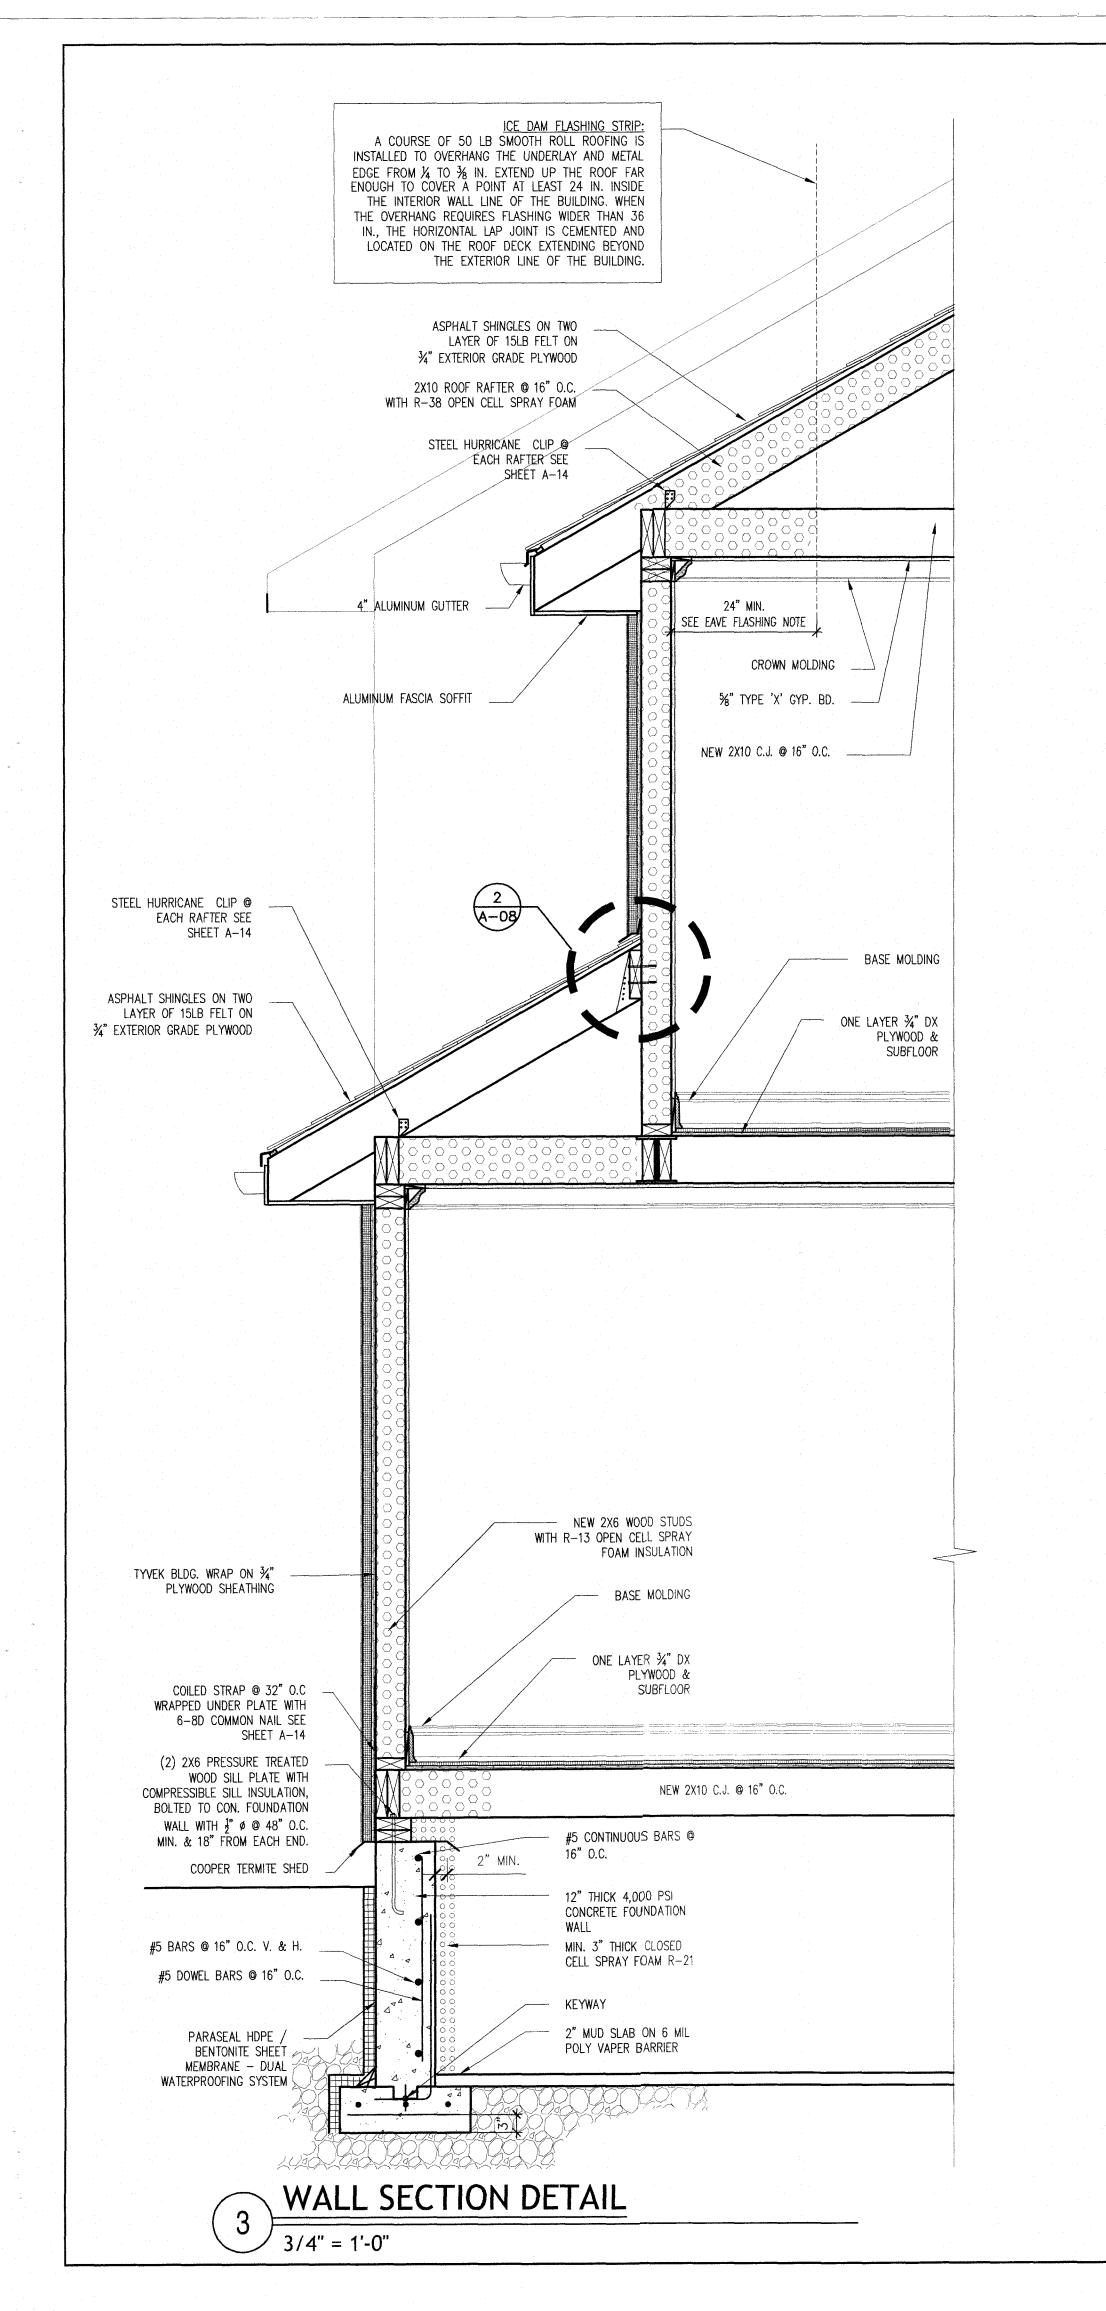
ROOF PLAN NOTES & DETAILS


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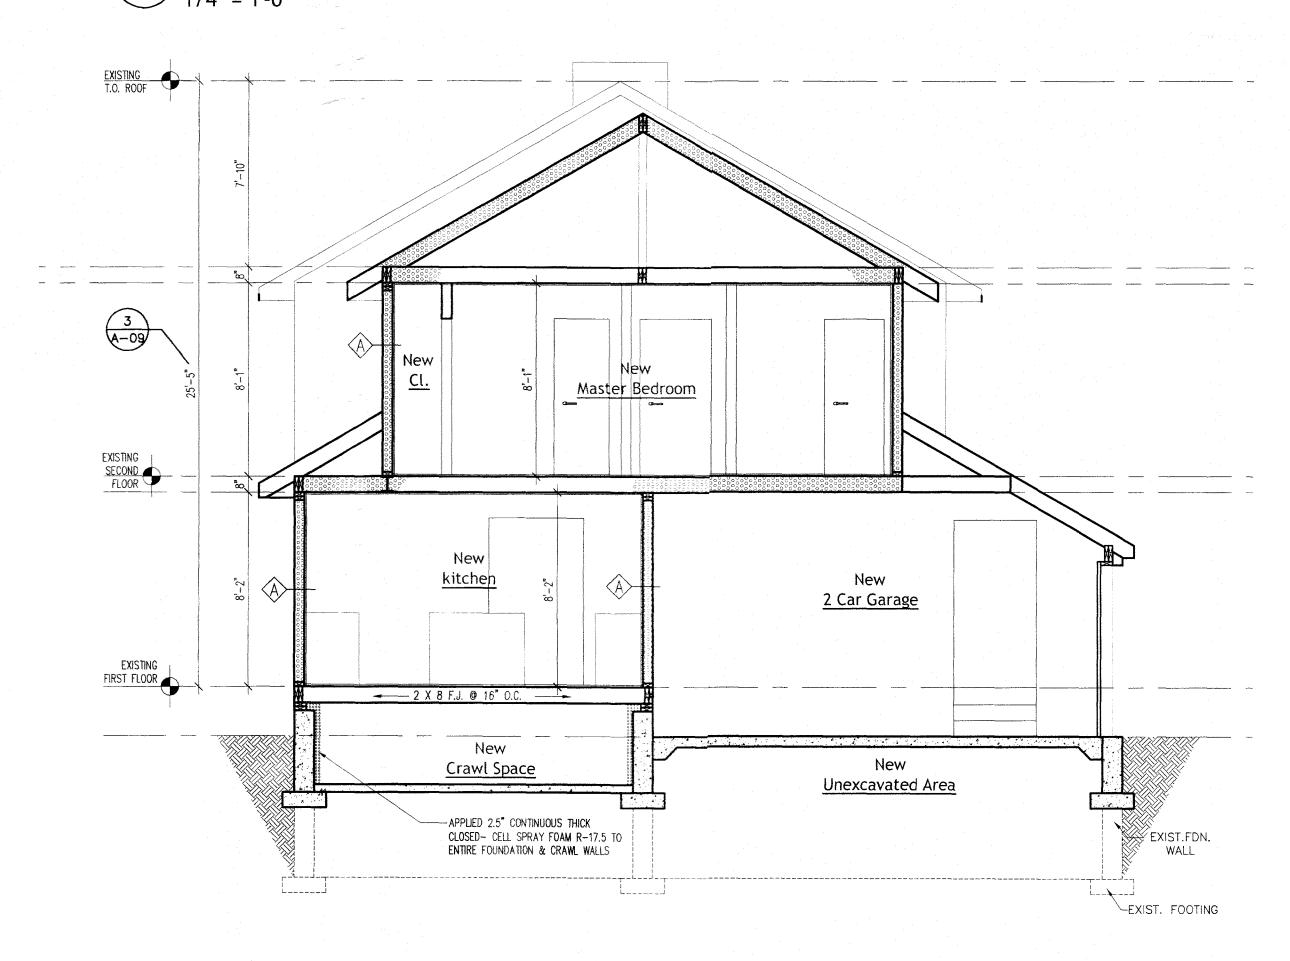
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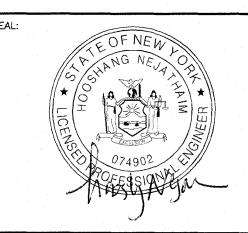
2 CROSS SECTION

1/4" = 1'-0"

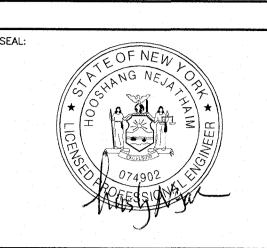

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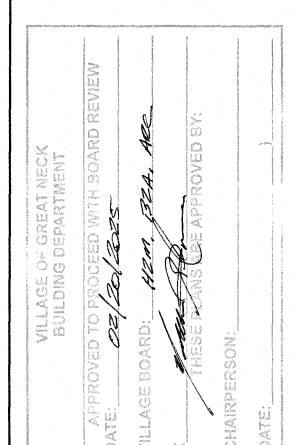
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> SECTIONS NOTES & DETAILS

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ITEM TITLE:

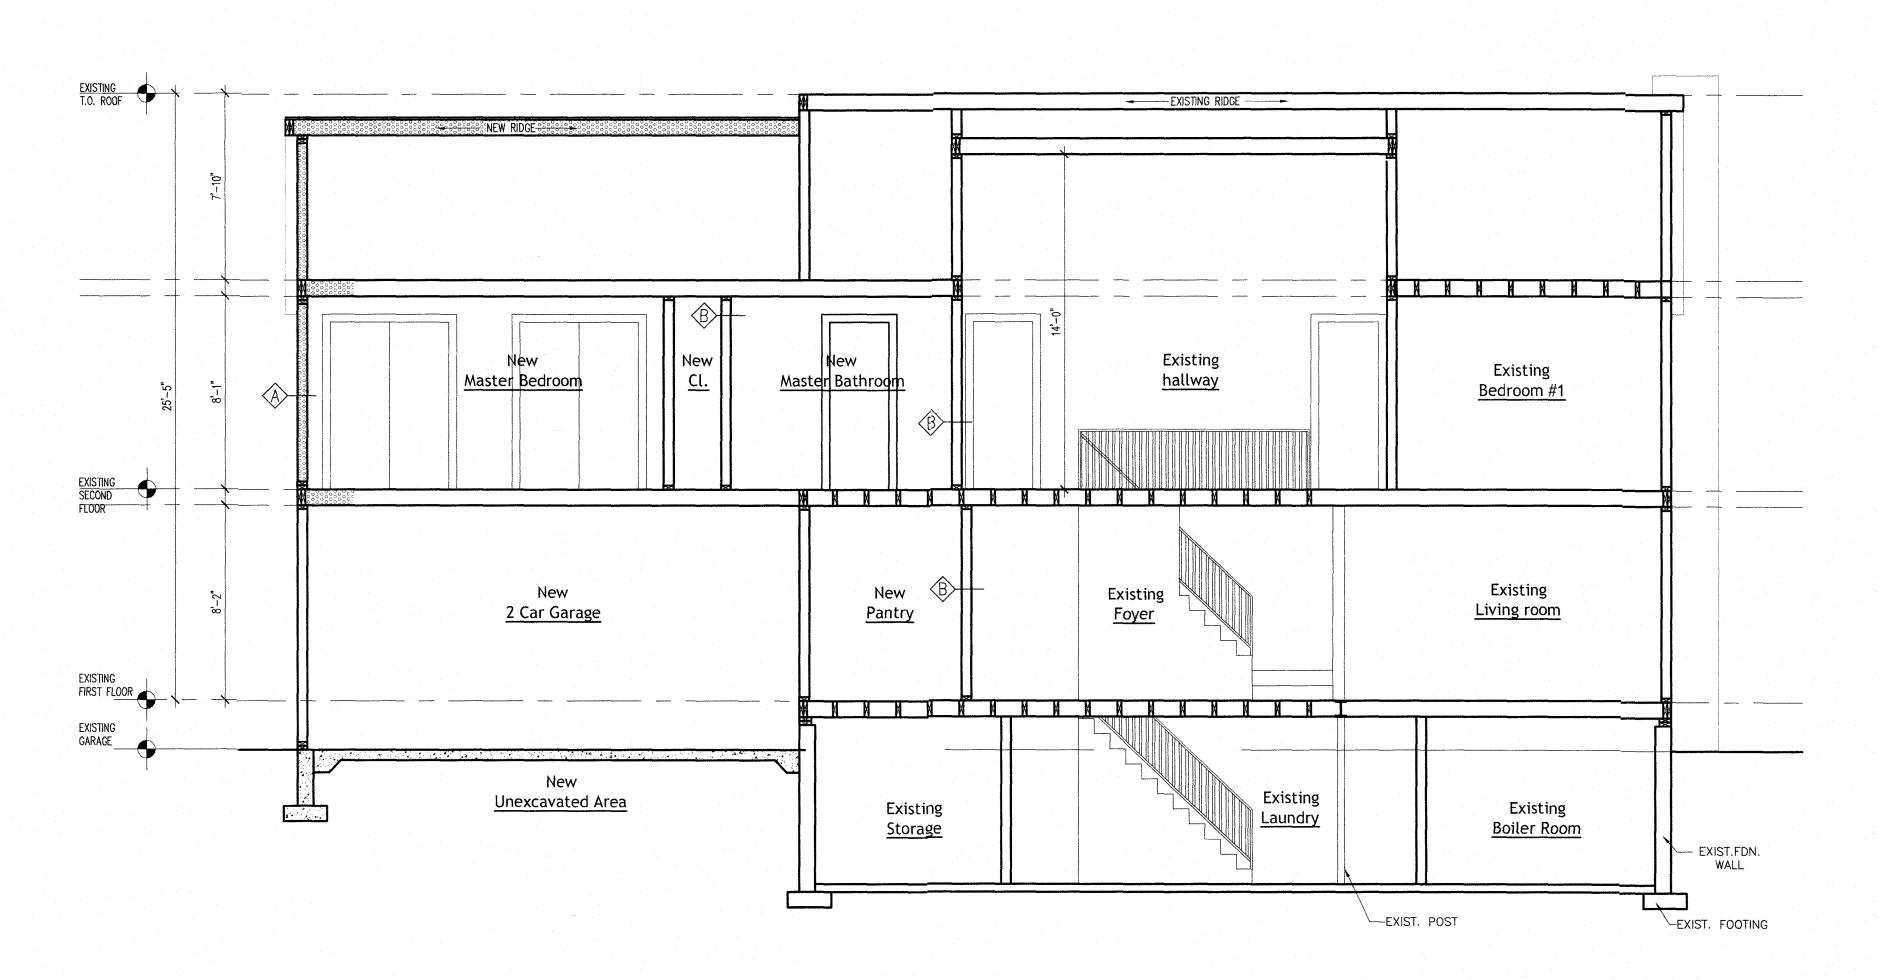NEXT MEETING DATE MAY 27 2025